

Design Review Board Meeting Tuesday, July 13, 2021 – 1:15 p.m.

Benjamin M. Racusin Council Chambers

AGENDA

The meeting will be held in-person at Town Hall in the Benjamin M. Racusin Council Chambers. The outside doors will be opened to the public one hour before the meeting start time, seating will be limited to no more than 80 individuals.

- 1. Call to Order
- 2. FOIA Compliance Public notification of this meeting has been published, posted, and distributed in compliance with the South Carolina Freedom of Information Act and the requirements of the Town of Hilton Head Island.
- 3. Roll Call
- 4. Swearing in Ceremony of New and Reappointed Design Review Board Members Performed by Josh Gruber, Deputy Town Manager
- 5. Approval of Agenda
- 6. Approval of Minutes
 - a. Meeting of June 22, 2021
- 7. Appearance by Citizens
- 8. New Business
 - a. New Development Conceptual
 - i. The Charles, DRB-001588-2021
 - ii. Tidal Wave Auto Spa, DRB-001589-2021
 - **b.** New Development Final
 - 85 Capital Drive, DRB-001600-2021
 - c. Alteration/Addition
 - i. Wei Food Hall, DRB-001598-2021
- 9. Board Business
- 10. Staff Report
 - a. Minor Corridor Report
- 11. Adjournment

Please note that a quorum of Town Council may result if four (4) or more of their members attend this meeting.



Design Review Board Meeting

June 22, 2021 at 1:15 p.m. Virtual Meeting

MEETING MINUTES

Present from the Board: Chairman Michael Gentemann, Vice Chair Cathy Foss, David McAllister, Judd Carstens, Annette Lippert, John Moleski, Debbie Remke

Absent from the Board: None

Present from Town Council: David Ames

Present from Town Staff: Chris Darnell, Urban Designer; Nicole Dixon, Development Review Administrator; Teresa Haley, Senior Administrative Assistant; Vicki Pfannenschmidt,

Temporary Administrative Assistant

1. Call to Order

Chairman Gentemann called the meeting to order at 1:15 p.m.

- 2. FOIA Compliance Public notification of this meeting has been published, posted, and distributed in compliance with the South Carolina Freedom of Information Act and the requirements of the Town of Hilton Head Island.
- 3. Roll Call See as noted above.
- 4. Presentation of the Town's Crystal Awards to outgoing Chairman Michael Gentemann and Debbie Remke

Mr. Darnell thanked Mr. Gentemann and Ms. Remke for their dedication and service to the Town of Hilton Head Island.

5. Approval of Agenda

Chairman Gentemann asked if staff had any changes to the agenda. Mr. Darnell stated that Item 8.a.i was listed as Alteration/Addition but should be New Development – Conceptual. Ms. Lippert moved to approve the agenda as amended. Vice Chair Foss seconded. By way of roll call, the motion passed by a vote of 6-0-1 (Ms. Remke abstained due to technical difficulties.)

6. Approval of Minutes

a. Meeting of June 8, 2021

Chairman Gentemann asked for a motion to approve the minutes of the June 8, 2021 regular meeting. Vice Chair Foss moved to approve. Mr. McAllister seconded. By way of roll call, the motion was approved by a vote of 7-0-0.

7. Appearance by Citizens

Public comments concerning agenda items were to be submitted electronically via the Open Town Hall HHI portal. There were no comments of record for this meeting. Citizens were provided the option to sign up for public comment participation during the meeting

by phone. There were two requests to participate by phone regarding Item 8.b.i. Chairman Gentemann will call on them during the review of that item.

8. New Business

- a. New Development Conceptual
 - i. The Charles, DRB-001440-2021

Mr. Darnell presented the application as described in the Board's agenda package. He stated the architectural detail of the proposed building is less residential in scale and not in keeping with the surrounding properties and staff recommends the application not be approved.

Chairman Gentemann asked if the applicant would like to add to Staff's narrative. The applicant presented statements regarding the project and answered questions by the Board. The Board and the applicant discussed the application and the following concerns and recommendations were made regarding the project: the front of the building needs relief from the vertical lines; the back of the building needs relief from the horizontal lines; central portion of the building in the front needs more of a presence; stairwell areas in need of additional planting to bring down scale; canopy trees needed in parking lot rather than palms; consideration of reduction of sodded areas; need for canopy trees on edge to Fort Mitchel site; discussion of pathway materials and grasses; the need to upsize the Live Oak trees in parking lot and front of building; the need to locate the pool closer to the water; the need to lower the roof height in the three columned structures where elevators are located; consideration to remove the raised roof on two column areas and just continue the roof line; discussions of alternatives and suggestions to reduce the scale of the building; consideration of more trim and trim bands to help the back elevations; the inconsistency and flow regarding the front, back and side elevations; the lack of a Lowcountry feel and more of a Mediterranean look; lack of details around the windows; too much stucco; consideration of building the fifth floor into the roofline; the need for visual support of the roof; and the contrast in the color scheme was too harsh.

Following discussion, the application was withdrawn at the applicant's request. No action was taken by the Board on the application.

- **b.** New Development Final
 - Pope Ave Starbucks, DRB-001318-2021

Mr. Darnell presented the application as described in the Board's agenda package. He noted the project received Conceptual Approval on April 30th. After that meeting, Staff received concerns from citizens about the redevelopment. Staff suggested changes to the proposed site plan that would reestablish the Pope Ave. buffer, improve pedestrian safety and improve vehicular circulation around the site in an effort to address those concerns. The applicant worked to accommodate all suggestions where possible.

Staff recommends approval with Staff review of the following:

- 1. Provide a vegetation protection plan for Staff review and approval that:
 - a. Locates tree protection fence around trees to be preserved.
 - b. Preserves understory vegetation between site and church.
 - c. Specifies a 4-6" protective wood mulch under the dripline of 31" & 21" Live Oak (front left corner) prior to construction.

- d. Specifies pre and post construction fertilization and mycor treatments by an arborist for the 31" and 21" Live Oak.
- 2. Revise the Planting Plan for Staff review and approval to:
 - a. Plant the Pope Ave. buffer more naturally.
 - b. Specify more shade tolerant planting under existing trees.

Chairman Gentemann asked if the applicant would like to add to Staff's narrative. The applicant presented statements regarding the project and answered questions by the Board. The Board and the applicant discussed the application and the following concerns and recommendations were made regarding the project: the revised site plan improvements; inclusion of a gate on the brick service yard; the need for cut sheets for fans and light fixtures; continuation of the southwest hip roof; colors for the service door and trim; the need for a color swatch for the awning; the need for canopy trees in the end islands and back; railing detail; access to the building from the handicap parking spaces; railing plan; and preservation of as much existing vegetation in shared drive between the site and neighboring church.

Sarah Coffin, Chair of Church Council of St. Andrews by the Sea Church, spoke on behalf of the Church in support of the new design.

The person that made the second request did not join the meeting.

Following the discussion, Ms. Lippert moved to approve DRB 001318-2021 with the following conditions:

- 1. All of Staff recommended conditions.
- 2. Addition of a gate at the brick service yard directly adjacent to the building with similar detailing as the service yard gate.
- 3. Submittal of cut sheets of the fan and light fixtures.
- 4. A revision of the roof profile plans south of the ladder to just extend instead of turn the hip.
- An understanding that the wood from the color board was for the handrail.
- 6. A recommendation to revise the color of the service door and trim to be Jogging Path.
- 7. A confirmation of the exposure of the hardy panel.
- 8. A recommendation to review whether the light fixture should get centered in the siding.
- 9. Submittal of the awning color and storefront color.
- 10. Submittal of a detail of the courtyard railing.
- 11. Relocation of the railing along the north side terminating further towards Pope Avenue to provide access for pedestrians directly in the building.
- 12. Replacement of the understory trees (Magnolia and Holly) at the parking islands to be Live Oaks, as specified.
- 13. All conditions are to be reviewed by staff for approval.
- Mr. McAllister seconded. By way of roll call, the motion passed by a vote of 7-0-0.

9. Board Business

a. Election of Officers for July 1, 2021 – June 30, 2022 term

Mr. Moleski nominated Vice Chair Foss to serve as Chair of the Design Review Board for the new term. Mr. McAllister seconded. By way of roll call, the motion passed by a vote of 6-0-1. (Vice Chair Foss abstained.)

Vice Chair Foss nominated John Moleski as Vice Chair of the Design Review Board for the new term. Mr. Carstens seconded. By way of roll call, the motion passed by a vote of 7-0-0.

Chairman Gentemann nominated Teresa Haley as Secretary of the Design Review Board. Vice Chair Foss seconded. By way of roll call, the motion passed by a vote of 7-0-0.

10. Staff Report

a. Minor Corridor Report - None

Mr. Darnell reminded Board members that their continuing education credits are due by the end of the month.

Mr. Darnell stated that in-person meetings will resume with the July 13, 2021 meeting.

11. Adjournment

The meeting was adjourned at 4:00 p.m.

Submitted by: Vicki Pfannenschmidt, Secretary

Approved: [DATE]



Community Development Department One Town Center Court

Hilton Head Island, SC 29928 Phone: 843-341-4757 Fax: 843-842-8908 www.hiltonheadislandsc.gov FOR OFFICIAL USE ONLY

Date Received:

Accepted by:

DRB #:

Meeting Date:

Applicant/Agent Name: CLIH BURDETT	Company: B DESIGN
Mailing Address: 7 BILSTON CT	City: 12MD State: SC Zip: 29063
Telephone: <u>803 422 5542</u> Fax:	City: IRMO State: SC Zip: 29063 E-mail: CBURDEHC3KEGMAJL.COM
Project Name: THE CHAPLES Pro	oject Address: LO3 SKULL CREEK DRUE
Parcel Number [PIN]: R 5 1 0 0 0 3 0 0 0	
	erlay District(s): HoHE
CORRIDOR RE	VIEW, MAJOR
DESIGN REVIEW BOARD (DRB)	SUBMITTAL REQUIREMENTS
Digital Submissions may be accepted via e-mail by callin	ng 843-341-4757.
Project Gategory:	
Concept Approval – Proposed Development	Alteration/Addition
Final Approval – Proposed Development	Sign
Submittal Requirements for All projects:	
jurisdiction of an ARB, the applicant shall submit s	of Action (if applicable): When a project is within the such ARB's written notice of action per LMO Section 16-ARB to meet this requirement is the responsibility of the
	ent \$175, Final Approval – Proposed Development \$175, eck made payable to the Town of Hilton Head Island.
tree protection regulations of Sec. 16-6-104.C.2, and beaches. A site analysis study to include specimen trees, accessives, orientation and other site features that may in the A draft written narrative describing the design interpretate the site analysis results. Context photographs of neighboring uses and architectures are protected by the site analysis of the site analysis results.	tectural styles. cation of new structures, parking areas and landscaping.

Additional Submittal Requirements: Final Approval – Proposed Development	
A final written narrative describing how the project conforms with the conceptual approval and design	
review guidelines of Sec. 16-3-106.F.3. Final site development plan meeting the requirements of Appendix D: D-6.F.	
Final site lighting and landscaping plans meeting the requirements of Appendix D: D-6.H and D-6.I.	
Final floor plans and elevation drawings (1/8"=1'-0" minimum scale) showing exterior building materials and	
colors with architectural sections and details to adequately describe the project.	
A color board (11"x17" maximum) containing actual color samples of all exterior finishes, keyed to the	ı
elevations, and indicating the manufacturer's name and color designation.	l
Any additional information requested by the Design Review Board at the time of concept approval, such as	ı
scale model or color renderings, that the Board finds necessary in order to act on a final application.	
Additional Submittal Requirements:	1
Alterations/Additions	l
All of the materials required for final approval of proposed development as listed above, plus the following additional materials.	
A survey (1"=30' minimum scale) of property lines, existing topography and the location of trees meeting the	
tree protection regulations of Sec. 16-6-104.C.2, and if applicable, location of bordering streets, marshes and	
beaches.	
Photographs of existing structure.	
Additional Submittal Requirements:	
Signs Accurate color randoming of sign showing dimensions, type of lettering, motorials and natural color comples	
Accurate color rendering of sign showing dimensions, type of lettering, materials and actual color samples.	
For freestanding signs:	
Site plan (1"=30' minimum scale) showing location of sign in relation to buildings, parking, existing signs,	
and property lines.	
Proposed landscaping plan.	
For wall signs:	
Photograph or drawing of the building depicting the proposed location of the sign.	
Location, fixture type, and wattage of any proposed lighting.	
	J
Note: All application items must be received by the deadline date in order to be reviewed by the DRB per LMO Appendix D: D-23.	
A representative for each agenda item is strongly encouraged to attend the meeting.	
Are there recorded private covenants and/or restrictions that are contrary to, conflict with, or prohibit	
the proposed request? If yes, a copy of the private covenants and/or restrictions must be submitted with	
this application. YES NO	
To the best of my knowledge, the information on this application and all additional documentation is tru	e,
factual, and complete. I hereby agree to abide by all conditions of any approvals granted by the Town of Hilto	n
Head Island. I understand that such conditions shall apply to the subject property only and are a right	01
obligation transferable by sale.	
I further understand that in the event of a State of Emergency due to a Disaster, the review and approval time	S
set forth in the Land Management Ordinance may be suspended.	
SIGNATURE DATE	
SIGNATURE DATE	

6.7.21

The proposed development The Charles is located in Hilton Head Plantation at the Old Fort Pub site. The name comes from Charles Fraser a pioneer in setting up development on Hilton Head Island and King Charles II for commissioning Admiral Hilton who the island is named after. This name carries with it a lot of rich history and character which is the design basis for our project.

The Old fort Pub site has its own history and sits next to the historical site of Fort Mitchell on its right side and a condominium known as the Commodore on its left. This site is known for its beautiful sunsets overlooking Skull Creek. The center of our site is currently developed as a circular parking lot with the Old Fort Pub restaurant itself set up on the waterfront of Skull Creek surrounded by beautiful live oak trees. At the entrance to the restaurant sits the largest tree on the site a 32" live Oak tree. This tree and other trees on the site as well as the beautiful sunsets became a major influence on the design of our project a 22 unit luxury condominium project, The Charles.

We wanted all of the units to have a view of Skull Creek and the sunset and to save as many trees as possible. We pulled the building back respecting the 32" Live Oak tree and established exterior amenities between the building and the creek. We also took into consideration the building setbacks and height restrictions. We originally looked at a shorter building 4 stories and 6 unit wide with covered parking on the street side which took away more green space and went set back to set back. The Hilton Head Plantation Hight restriction is less than The Town of Hilton Head at 43' vs 75' so we approached them with a 5 story over parking concept with a height restriction of 53' and taking up less green space and more freedom on the building setbacks with the edges of the building stepping down to be more sensitive to the surrounding sites. We lowered the parking under the building and raised the earth at the porte-cochere to have a grand entrance and to help hide the parking on the site. The building exterior was designed with Hilton Head low country features. With a traditional design of a heavy base a middle and a lighter top we brought into play a color scheme of rich gray colors that resemble the base middle and top and also stepped the colors along with the building.

Finally we enhanced the site with a rich in character landscape package that you experience as you meander through the site whether you are driving or walking.













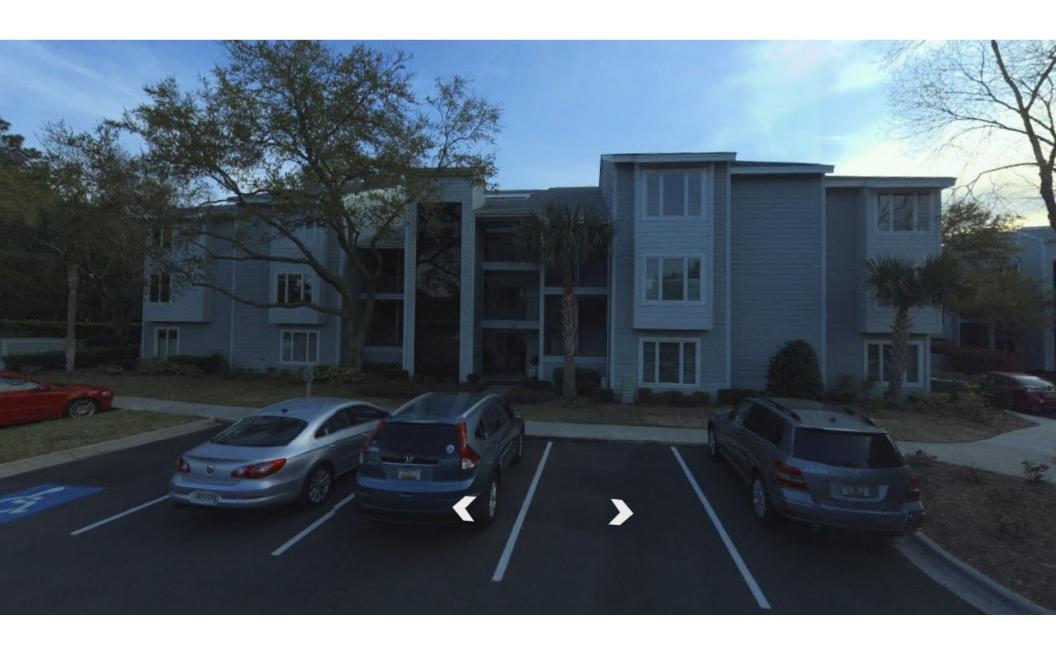





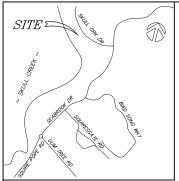

VICINITY MAP - N.T.S.

LINE TABLE				
L# LENGTH		DIRECTION		
L1	43.11'	S47*11'23"E		
L2	34.13'	S47"11'23"E		
L3	49.75	S71*22'12"W		
L4	43.52'	S18*25'39"E		
L5	5.14'	S18*25'39 " E		
L6	27.20'	N71*34'21"E		
L7	20.27'	S23'42'05"E		
L8	29.79'	N25'56'51"W		
L9	28.61'	N67*17'16"E		
L10	20.25	S18*54'02"E		
L11	26.94'	S8415'54"E		
L12	24.51	N77*39'33"E		
L13	66.36'	S18*14'03"E		
L14	56.80'	S80'07'27"E		
L15	31.64	N71*34'21"E		
L16	91.42'	S1875'19"E		
L17	54.06'	N71°44'41"E		
L18	37.85'	S71*19'30"W		
L19	15.60'	N26*25'57"W		
L20	19.51'	N13*26'24"W		
L21	24.89'	N13*33'56"W		
L22	15.07'	N14*38'02"W		
L23	13.15	N1913'51"W		
L24	7.45'	N30°01′56″W		
L25	13.32'	N00°04'29"E		
L26	5.39'	N14°09'00"W		
L27	20.99'	N27*31'35"W		
L28	10.67'	N05*53'18"E		
L29	12.73'	N20°27'21"W		
L30	3.46'	N10'48'44"E		
L31	23.19'	N18*44'19"W		
L32	10.24	S77*21'01"W		
L33	7.45'	N17'00'23"W		
L34	10.94	N44*55'35"E		
L35	25.71'	N33*58'00"W		
L36	24.35'	N15"14'49"W		
L37	20.25'	N26*05'26"W		
L38	25.26	N2417'22"W		
L39	2.78'	N2310'34"W		

REFERENCE PLAT:

- REFERENCE PLAT:

 PLAT BOOK 84, PAGE 40

 DEED BOOK 3164, PAGES 145–151

 PLAT BOOK 34, PAGE 203

 PLAT BOOK 34, PAGE 19

 PLAT BOOK 34, PAGE 199

 PLAT BOOK 24, PAGE 195

 PLAT BOOK 28, PAGE 197

 PLAT BOOK 28, PAGE 177


 PLAT BOOK 35, PAGE 417

 PLAT BOOK 37, PAGE 166

 DHEC-OCRM CRITICAL LINE TAKEN FROM A BOUNDARY SURVEY OF THIS PROPERTY BY COASTAL SURVEYING CO. DATED 10/14/15.

CURVE TABLE C# ARC RADIUS DELTA DIRECTION CHORD C1 140.20' 418.34' 1972'04" S37'42'59"E 139.54' C2 94.11' 279.14' 1978'57" S8472'52"E 93.66'



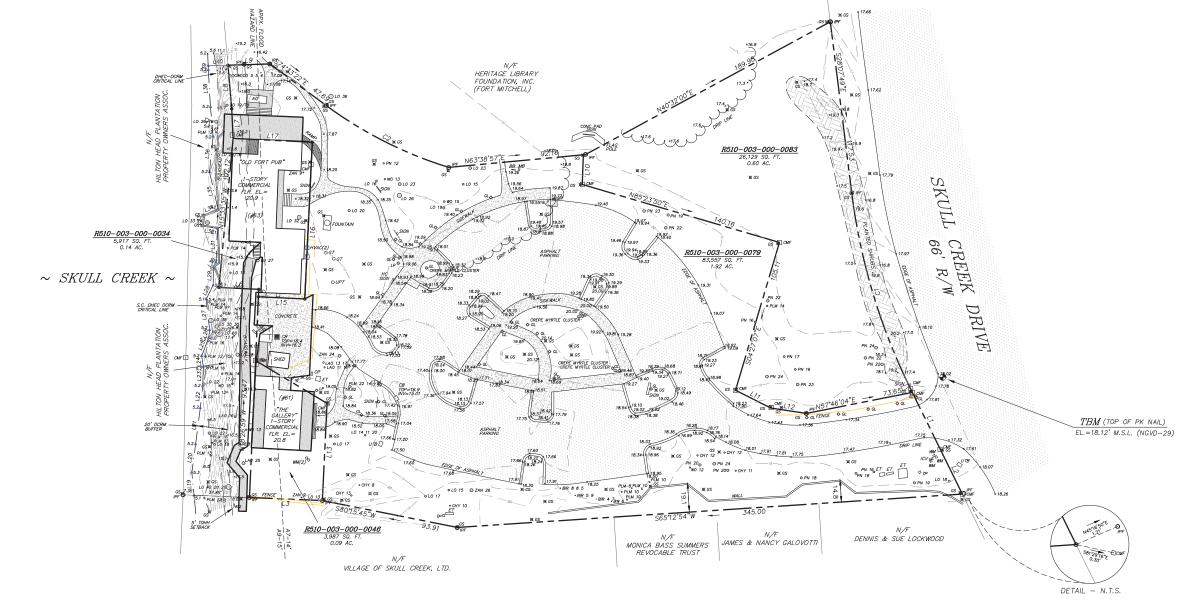

THE AREA SHOWN HEREON IS A GENERAL REPRESENTATION OF DEPARTMENT PERMIT AUTHORITY ON THE SUBSCIP PROPERTY COMPOSE, ARE SO, BY THEIR MATURE. ARE DYMANIC AND SUBJECT TO CHANGE OVER THE. BY THE DELINEATING HE PERMIT AUTHORITY OF THE DEPAREMENT, THE GEPARTMENT IN NO WAY WAVES THE RIGHT TO ASSERT PERMIT JURISDICTION AT ANY TIME IN ANY CRITICAL AREA OF THE SUBJECT PROPERTY, METHER SHOWN OR NOT.

SIGNA TURE

---19---X 19.0

DATE

The critical line shown on this plat is valid for five years from the date of this signature, subject to the cautionary language above.

- NOTES:

 NOTES:
- 3. ALL BUILDING SETBACK REQUIREMENTS SHOULD BE VERIFIED WITH THE PROPER AUTHORITIES PRIOR TO DESIGN AND CONSTRUCTION. CERTIFICATIONS ARE NOT TRANSFERABLE TO ADDITIONAL INSTITUTIONS OR SUBSEQUENT OWNERS.

LEGEND

AUJUARIUM
BILLBOARDIN
CONTROL FANEL
CONTROL FANEL
COLL CONGRETE MONUMENT FOUND
ELECTRIC TRANSFORMER
FLAG POLE
GREASE TRAP
IRRIGATION CONTROL VALVE
NEW IRON PIN SET
OLD IRON PIN FOUND
LIGHT POLE
MAIL BOX
TELEPHONE PEDESTAL
UNDERGROUND PROPANE TANK
WATER METER
CONTROL LINE
SPOT ELEVATION

WATER OAK XANTHOXYLUM REFERENCE PLAT:

A SUBDIVISION PLAT OF PHASE 1
BERKELEY HALL PLANTATION
BY: THOMAS & HUTTON ENGINEERING CO.
DATED: 07/07/00; LAST REVISED 8/20/03
FILE: J-13475

TREE LEGEND

BIRCH BLACK WALNUT

LABEL DESCRIPTIONS (TYP.) - - TREE LOCATION N 18.4 - → GROUND ELEVATION

PN 18 → TREE SPECIES & DIAMETER (IN.)

ONE FOOT CONTOUR INTERVAL

BOBBY HANCOCK

"I HEREBY STATE THAT TO THE BEST OF MY KNOWLEDGE, INFORMATION, AND BELIEF, THE SURVEY SHOWN HEREON, WAS MADE IN ACCORDANCE WITH THE REQUIREMENTS OF THE MINIMUM STANDARDS MANUAL FOR THE PRACTICE OF LAND SURVEYING IN SOUTH CARCIUM, AND MEETS OR EXCEEDS THE REQUIREMENTS FOR A CLASS "A" SURVEY AS SPECIFIED THEREIN ALSO THERE ARE NO VISIBLE ENCROACHMENTS OR PROJECTIONS OTHER THAN SHOWN."

MICHAEL R. DUNIGAN S.C.R.L.S. NO. 11905

PREPARED FOR:

A TREE AND TOPOGRAPHIC SURVEY OF OLD FORT PUB AREA


SKULL CREEK DRIVE A PORTION OF


HILTON HEAD PLANTATION

HILTON HEAD ISLAND, BEAUFORT COUNTY, SOUTH CAROLINA

SCALE: 1"=30' DATE: 12/10/20 JOB No.: 68,735TA SURVEYED BY: DJ DRAWN BY: LAN CHECKED BY: MRD



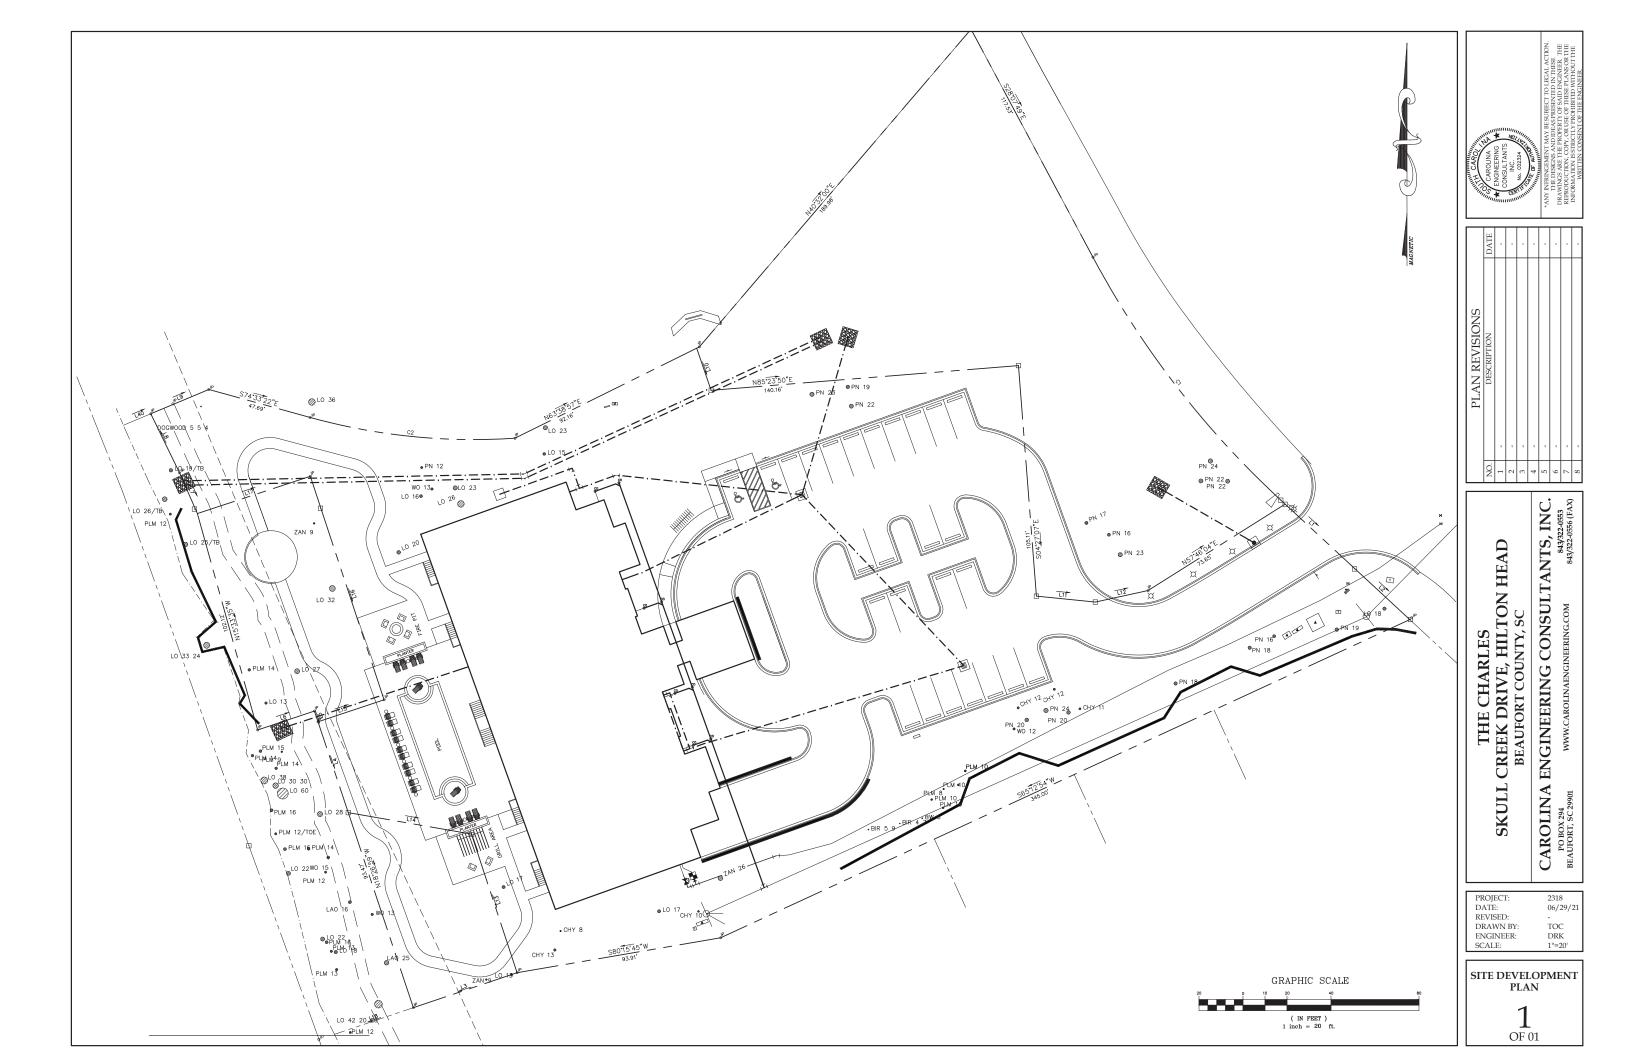

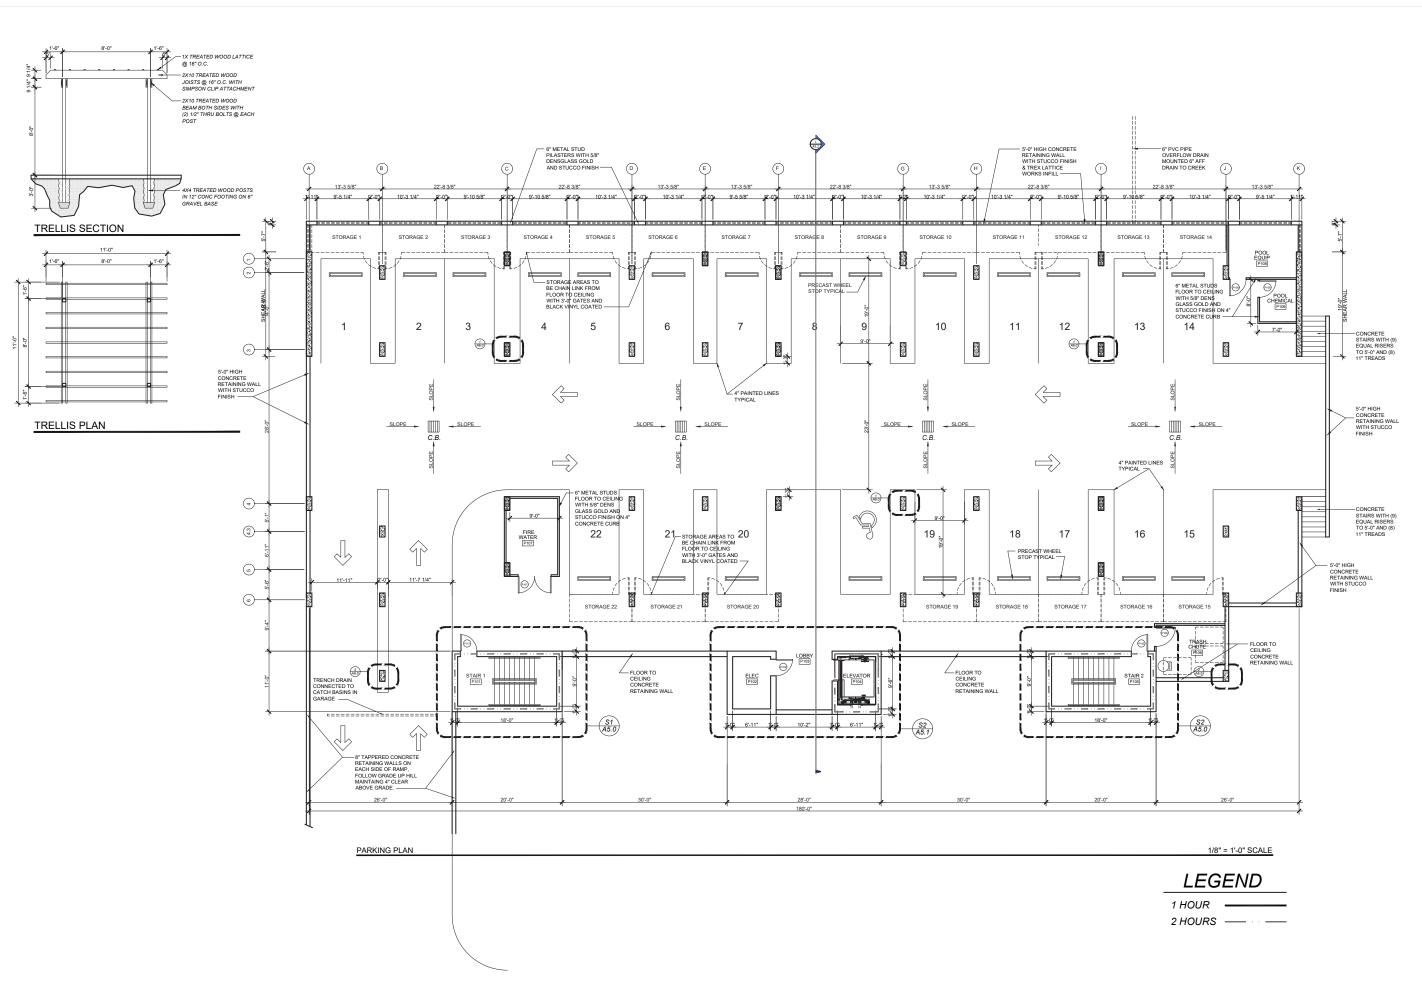






THE CHARLES PARKING PLAN



B Design Clint Burdett, AIA 7 Bilston Ct. Irmo, SC 29063 Phone 803-422-5542 Email cburdettc3k@gmail.con

DATE: 5.21.2021 REV:

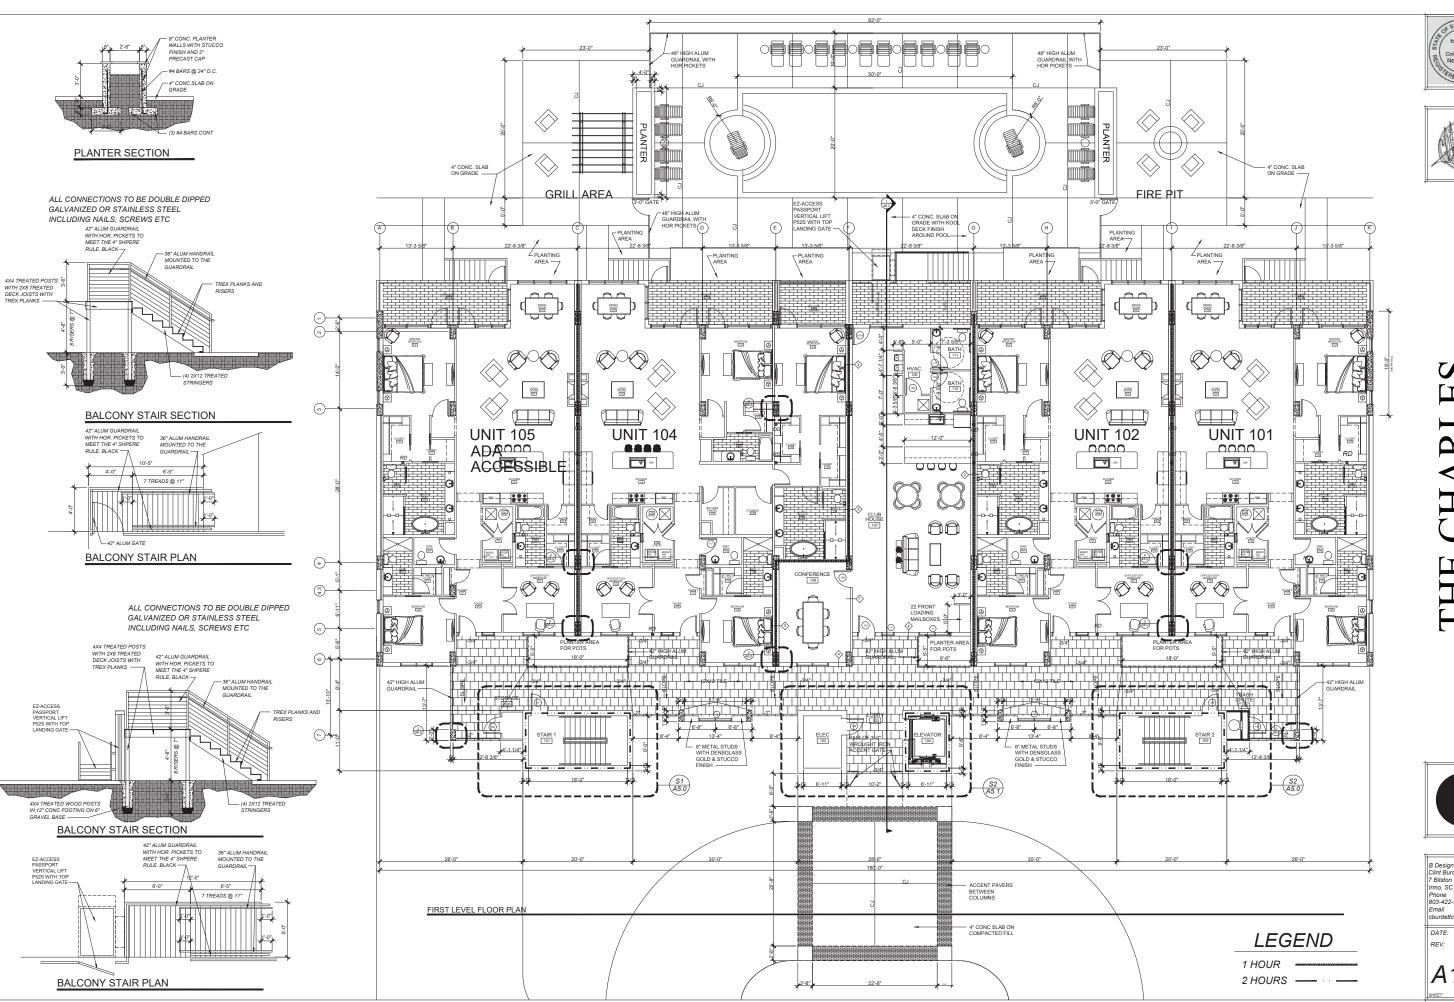





口 **PLAN** FIRST FLOOR THE



B Design Clint Burdett, AIA 7 Bilston Ct. Irmo, SC 29063 Phone 803-422-5542 Email cburdettc3k@gmail.com

DATE: 5.21.2021







FIFTH FLOOR PLAN




B Design Clint Burdett, AIA 7 Bilston Ct. Irmo, SC 29063 Phone 803-422-5542 Email cburdettc3k@gmail.con

LEGEND

2 HOURS ----

1 HOUR

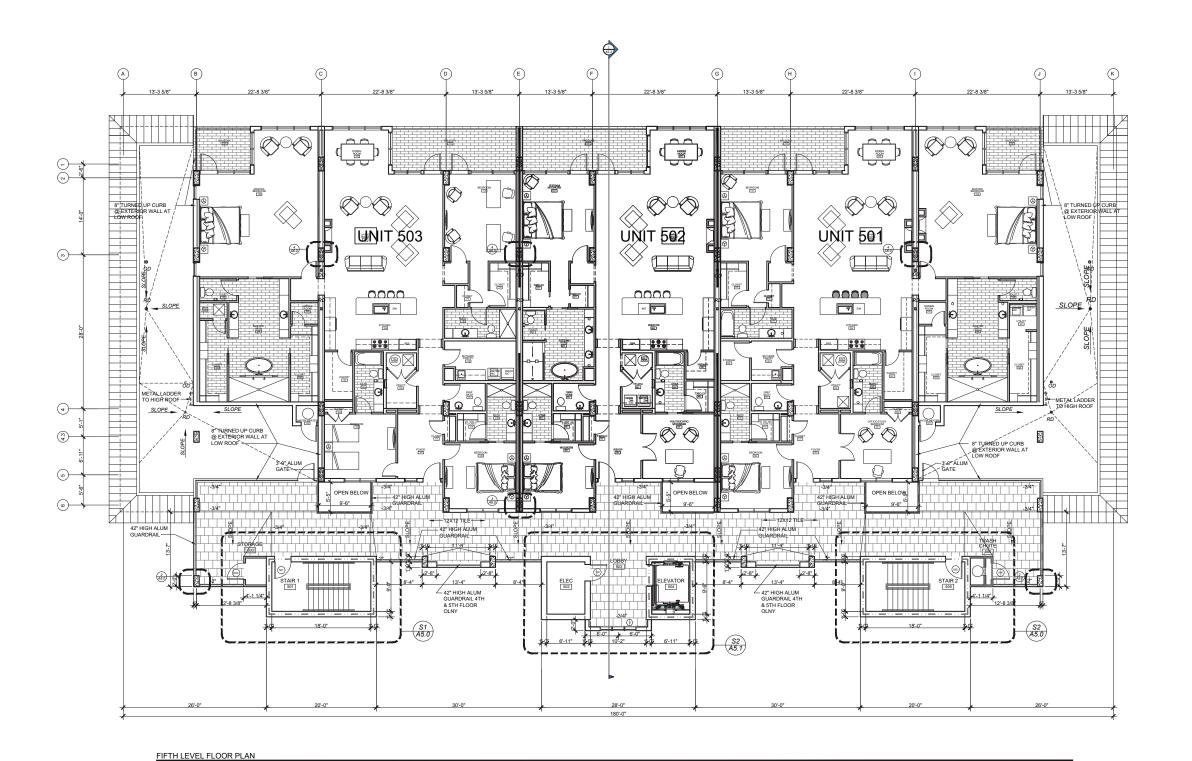












B Design Clint Burdett, AIA 7 Bilston Ct. Irmo, SC 29063 Phone 803-422-5542 Email cburdettc3k @gmail.con

DATE: 5.21.2021 REV:

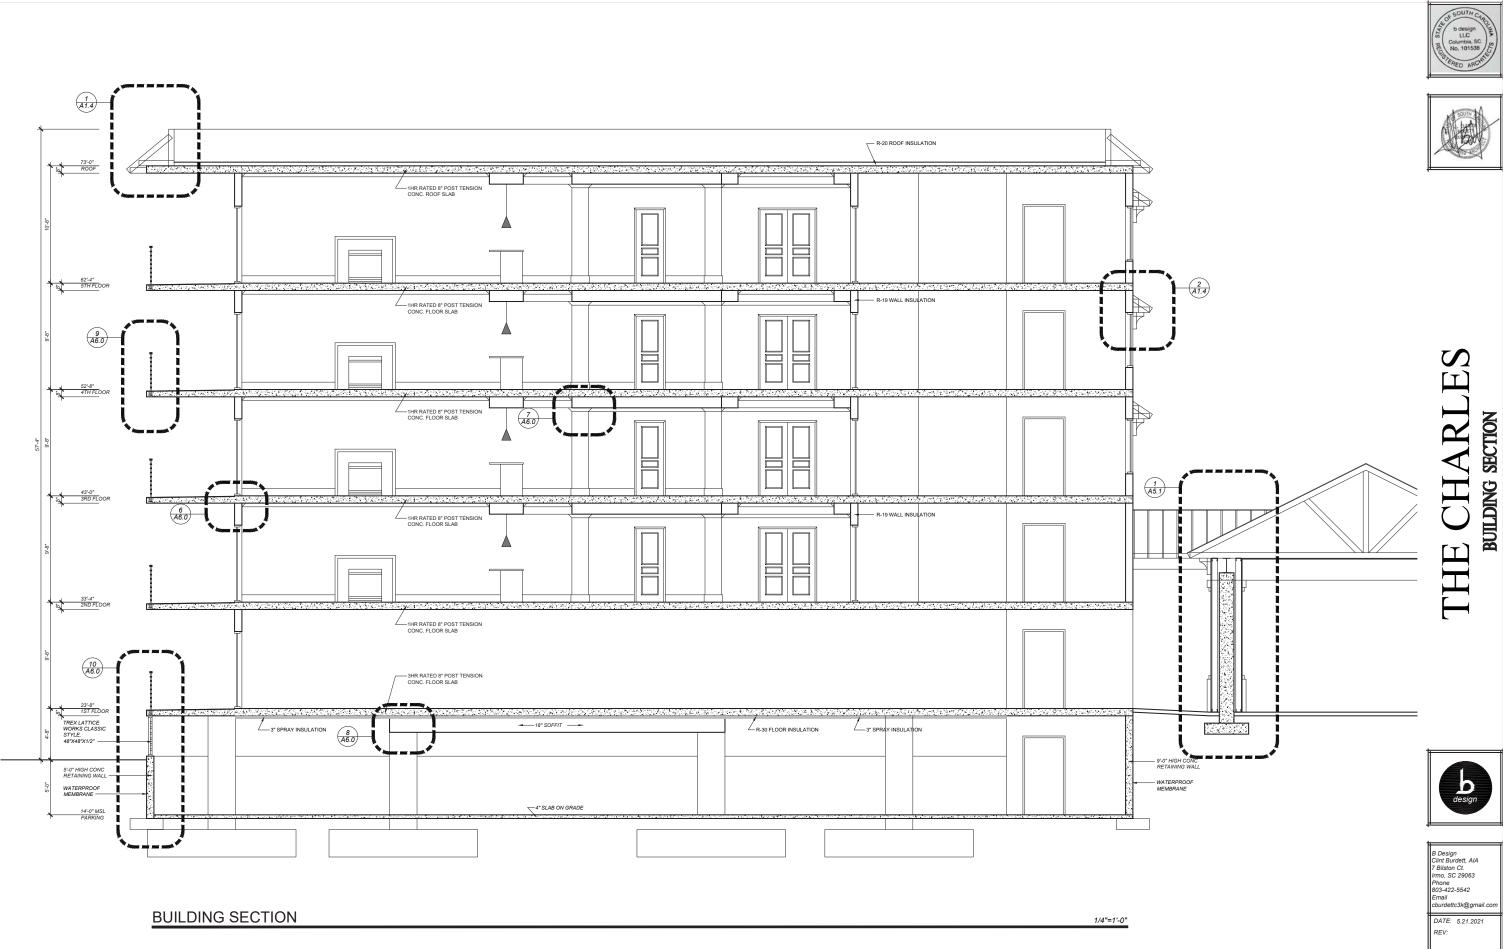







A5.2




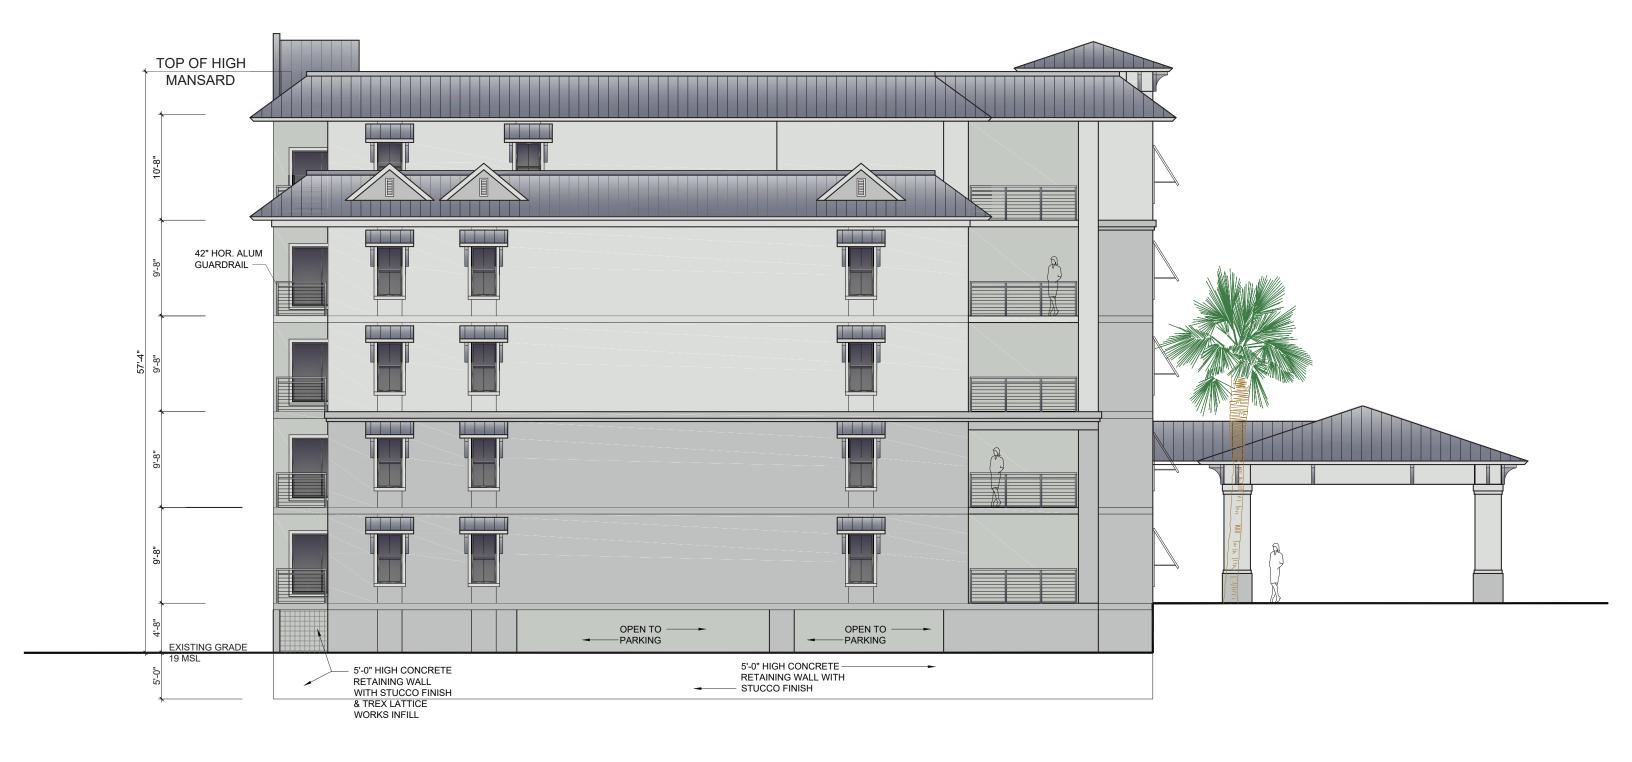





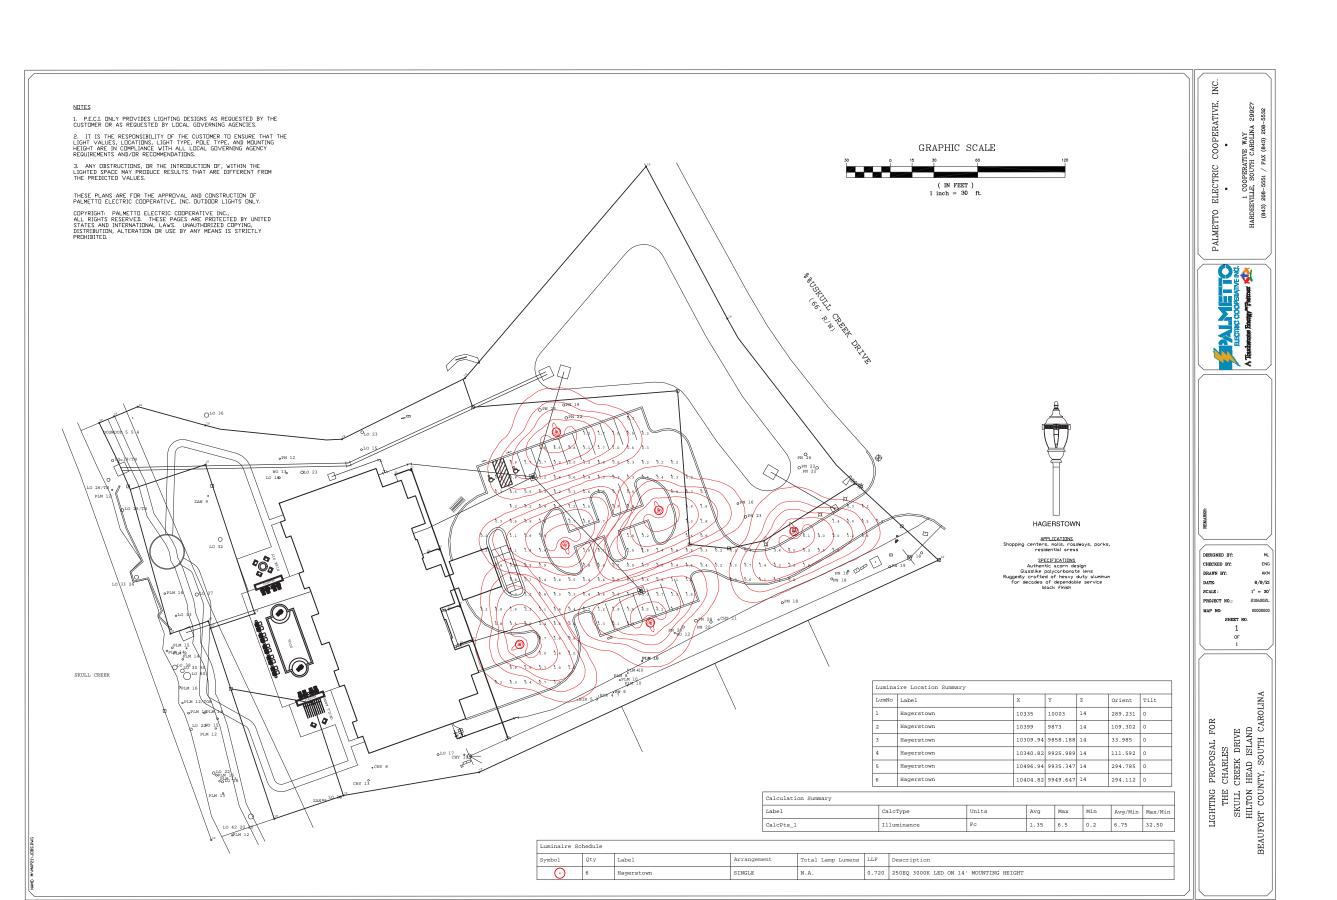

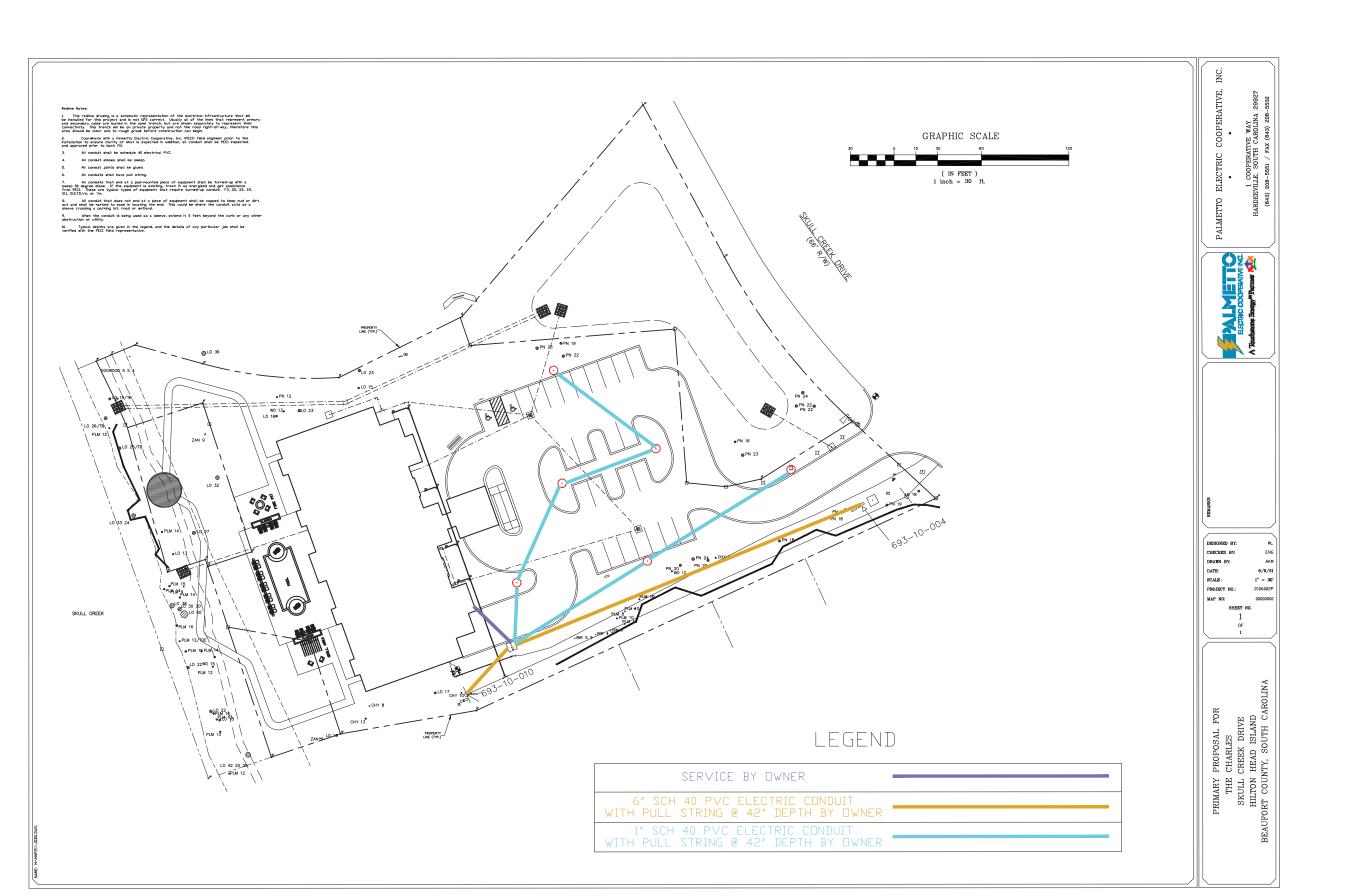

DESIGN TEAM/DRB COMMENT SHEET

The comments below are staff recommendations to the Design Review Board (DRB) and do NOT constitute DRB approval or denial.

PROJECT NAME: The Charles	DRB#: DRB-001588-2021					
DATE: 06/30/21						
RECOMMENDATION: Approval RECOMMENDED CONDITIONS: The follows 1. Provide a Demolition Plan 2. Provide a Tree Protection Plan specifying a. Preconstruction 4 – 6" mulch up b. Pre and post fertilization and mulch and provide an LMO compliant Lighting Plan	wing shall be acting: Inder canopy, yoor treatments n keeping with	ddresse		Denial ent.		
APPLICATION MATERIAL						
DRB REQUIREMENTS	Complies Yes	No	Not Applicable	Comments or Conditions		
Demolition Plan if needed				Please provide.		
ARCHITECTURAL DESIGN						
DESIGN GUIDE/LMO CRITERIA	Complies Yes	No	Not Applicable	Comments or Conditions		
Utilizes natural materials and colors		\boxtimes		 Staff is concerned the light gray colors will bleach out to white in the sun. Consider breaking up the façade with a material to contrast the stucco. 		
Utilizes a variety of materials, textures and colors		\boxtimes		Consider use of another material (in addition to the		

			•	_		
				stucco) on the exterior of the building.		
LANDSCAPE DESIGN						
DESIGN GUIDE/LMO CRITERIA	Complies Yes	No	Not Applicable	Comments or Conditions		
Provides Landscaping of a scope and size that is in proportion to the scale of the development				Scale of landscape appears inadequate. 1. The storm water detention planting is unrealistic. Consider grasses in addition, and as the main species, to what is proposed. 2. Trees are should be planted in a more natural layout instead of equidistant apart. 3. It is unclear how the landscape will relate to the buffer at water's edge.		
Provides for a harmonious setting for the site's structures, parking areas or other construction				Canopy trees should be used in the parking lot instead of palms to shade the parking and visually mitigate the building.		
	NATURAL RESOURCE PROTECTION					
NATURAL RESOURCE PROTECTIO)N					
NATURAL RESOURCE PROTECTION DESIGN GUIDE/LMO CRITERIA	Complies Yes	No	Not Applicable	Comments or Conditions		
	Complies	No 🖂	Not Applicable	 Specify pre and post construction fertilization and mycor treatment for all trees to be preserved close to construction. Specify a 4-6" wood mulch under all trees to 		
DESIGN GUIDE/LMO CRITERIA An effort has been made to preserve existing trees and	Complies Yes			Specify pre and post construction fertilization and mycor treatment for all trees to be preserved close to construction.		
DESIGN GUIDE/LMO CRITERIA An effort has been made to preserve existing trees and	Complies Yes			 Specify pre and post construction fertilization and mycor treatment for all trees to be preserved close to construction. Specify a 4-6" wood mulch under all trees to 		
DESIGN GUIDE/LMO CRITERIA An effort has been made to preserve existing trees and under story plants MISC COMMENTS/QUESTIONS	Complies Yes			 Specify pre and post construction fertilization and mycor treatment for all trees to be preserved close to construction. Specify a 4-6" wood mulch under all trees to 		
DESIGN GUIDE/LMO CRITERIA An effort has been made to preserve existing trees and under story plants	Complies Yes Tring the June 22 ⁿ	d DRB m	eeting.	 Specify pre and post construction fertilization and mycor treatment for all trees to be preserved close to construction. Specify a 4-6" wood mulch under all trees to be preserved, installed prior to demolition. 		
DESIGN GUIDE/LMO CRITERIA An effort has been made to preserve existing trees and under story plants MISC COMMENTS/QUESTIONS This project was withdrawn at the applicants request du	Complies Yes Tring the June 22 ⁿ of 1 foot-candle	d DRB m	eeting. ot-candle max. and 300	 Specify pre and post construction fertilization and mycor treatment for all trees to be preserved close to construction. Specify a 4-6" wood mulch under all trees to be preserved, installed prior to demolition. 		
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Community Development Department

One Town Center Court Hilton Head Island, SC 29928 Phone: 843-341-4757 Fax: 843-842-8908

www.hiltonheadislandsc.gov

FOR OFFICIAL USE ONLY	
Date Received:	
Accepted by:	
DRB #:	
Meeting Date:	_

Parcel Number [PIN]: R 5 1 1 0 0 8 0 0 0 2 0	Company: SHJ CONSTRUCTION GROUP City: THOMASTON State: GA Zip: 30286 E-mail: MARTIE@SHJCONSTRUCTIONGROUP.COM ect Address: 1 PLAZA DRIVE, HILTON HEAD ISLAND, SOME SERVICE STATE OF THE S
	rlay District(s): CORRIDOR & AIRPORT OVERLAY
CORRIDOR REV DESIGN REVIEW BOARD (DRB) S	
Project Category: Concept Approval – Proposed Development Final Approval – Proposed Development	Alteration/Addition Sign
2-103.I.4.b.iii.01. Submitting an application to the A applicant. Filing Fee: Concept Approval-Proposed Developmen	f Action (if applicable): When a project is within the ch ARB's written notice of action per LMO Section 16-LRB to meet this requirement is the responsibility of the at \$175, Final Approval – Proposed Development \$175, ek made payable to the Town of Hilton Head Island.
beaches. A site analysis study to include specimen trees, accessiviews, orientation and other site features that may inform A draft written narrative describing the design intented reflects the site analysis results. Context photographs of neighboring uses and architects	if applicable, location of bordering streets, marshes and s, significant topography, wetlands, buffers, setbacks, fluence design. of the project, its goals and objectives and how it ctural styles. ation of new structures, parking areas and landscaping. nowing architectural character of the proposed

	Additional Submittal Requirements: Final Approval – Proposed Development A final written narrative describing how the project conforms with the conceptual approval and design review guidelines of Sec. 16-3-106.F.3. Final site development plan meeting the requirements of Appendix D: D-6.F. Final site lighting and landscaping plans meeting the requirements of Appendix D: D-6.H and D-6.I. Final floor plans and elevation drawings (1/8"=1'-0" minimum scale) showing exterior building materials and colors with architectural sections and details to adequately describe the project. A color board (11"x17" maximum) containing actual color samples of all exterior finishes, keyed to the elevations, and indicating the manufacturer's name and color designation. Any additional information requested by the Design Review Board at the time of concept approval, such as
1	scale model or color renderings, that the Board finds necessary in order to act on a final application.
	Additional Submittal Requirements: Alterations/Additions All of the materials required for final approval of proposed development as listed above, plus the following additional materials. A survey (1"=30' minimum scale) of property lines, existing topography and the location of trees meeting the tree protection regulations of Sec. 16-6-104.C.2, and if applicable, location of bordering streets, marshes and beaches. Photographs of existing structure.
-	Additional Submittal Requirements:
	Signs Accurate color rendering of sign showing dimensions, type of lettering, materials and actual color samples.
	For freestanding signs: Site plan (1"=30" minimum scale) showing location of sign in relation to buildings, parking, existing signs, and property lines. Proposed landscaping plan.
	For wall signs: Photograph or drawing of the building depicting the proposed location of the sign. Location, fixture type, and wattage of any proposed lighting.
	Note: All application items must be received by the deadline date in order to be reviewed by the DRB per LMO Appendix D: D-23. **Trepresentative for each agenda item is strongly encouraged to attend the meeting.
A.	Are there recorded private covenants and/or restrictions that are contrary to, conflict with, or prohibit he proposed request? If yes, a copy of the private covenants and/or restrictions must be submitted with his application. YES NO
	To the best of my knowledge, the information on this application and all additional documentation is true, actual, and complete. I hereby agree to abide by all conditions of any approvals granted by the Town of Hilton Head Island. I understand that such conditions shall apply to the subject property only and are a right or obligation transferable by sale.
	further understand that in the event of a State of Emergency due to a Disaster, the review and approval times et forth in the Land Management Ordinance may be suspended.
	Market 6/29/21
3	DATE
	ast Revised 01/21/15




1344 US Hwy 19 South Suite A Leesburg, GA 31763 Phone: (229) 435-6133 Fax: (229) 439-7979 www.emc-eng.com


Development Narrative

The proposed development intends to demo the existing 2,335 sf Pizza Hut bldg. that currently encroaches into the 20' bldg. setback along with the existing 4,755 sf open bay carwash and redevelop the lot as 3,200 sf express tunnel car wash, Tidal Wave Auto Spa. The proposed development will remove one access point from Plaza Drive and one from Frontage Road. The existing property has a lot coverage of 63% and the proposed redevelopment will be removing all of the existing development and redeveloping the lot to 60 % coverage increasing the landscaped area and bring the site in to compliance with current code standards. The site plan was design to preserve all the existing Specimen and Significant trees onsite except for one 30" Loblolly Pine which due to its proximity to an existing 18" Water Oak, makes it less than ideal to try and save as a significant tree. The proposed development does not affect any existing wetlands or buffers. The site drainage patterns will be designed to mimic existing conditions and meet all the required stormwater management standards. The Landscape buffer parallel to plaza drive is designed to coordinate with the features of the building. This allows for a combined screening of the vacuum service area located East of the primary building where people will be allowed to vacuum and clean the insides of the car after it has been through the wash. The site landscaping is designed to exceed the required standards as Tidal Wave does with all their site to provide their customer with an upscale experience as they navigate the site with multiple landscape or "WOW" features. All the vacuum equipment onsite will be housed in screening structures that will match the upscaled building facades of the primary building. These structures are fully enclosed preventing any obtrusive sounds from the vacuum equipment enhancing the experience of our customers. In addition to these masonry screenings landscape feature will be placed to help the other site components like the dumpster screening area fade back into the landscaping.

Sincerely,

Alex Perry, PE Project Manager EMC Engineering Service

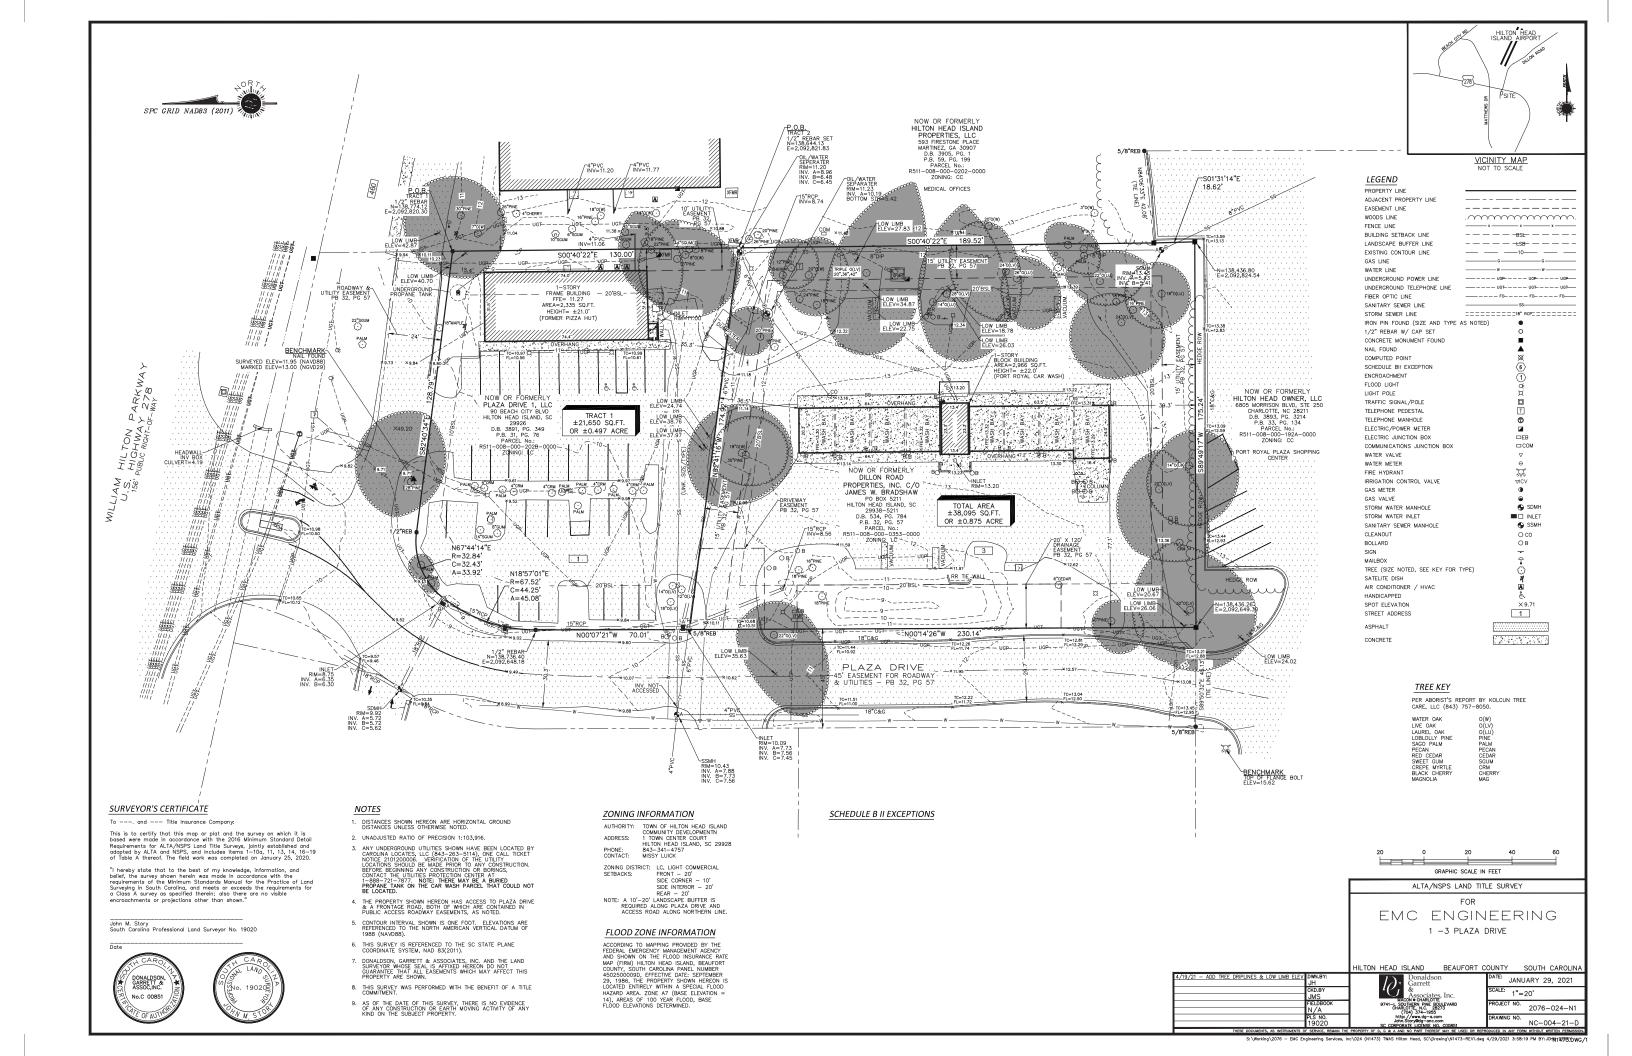

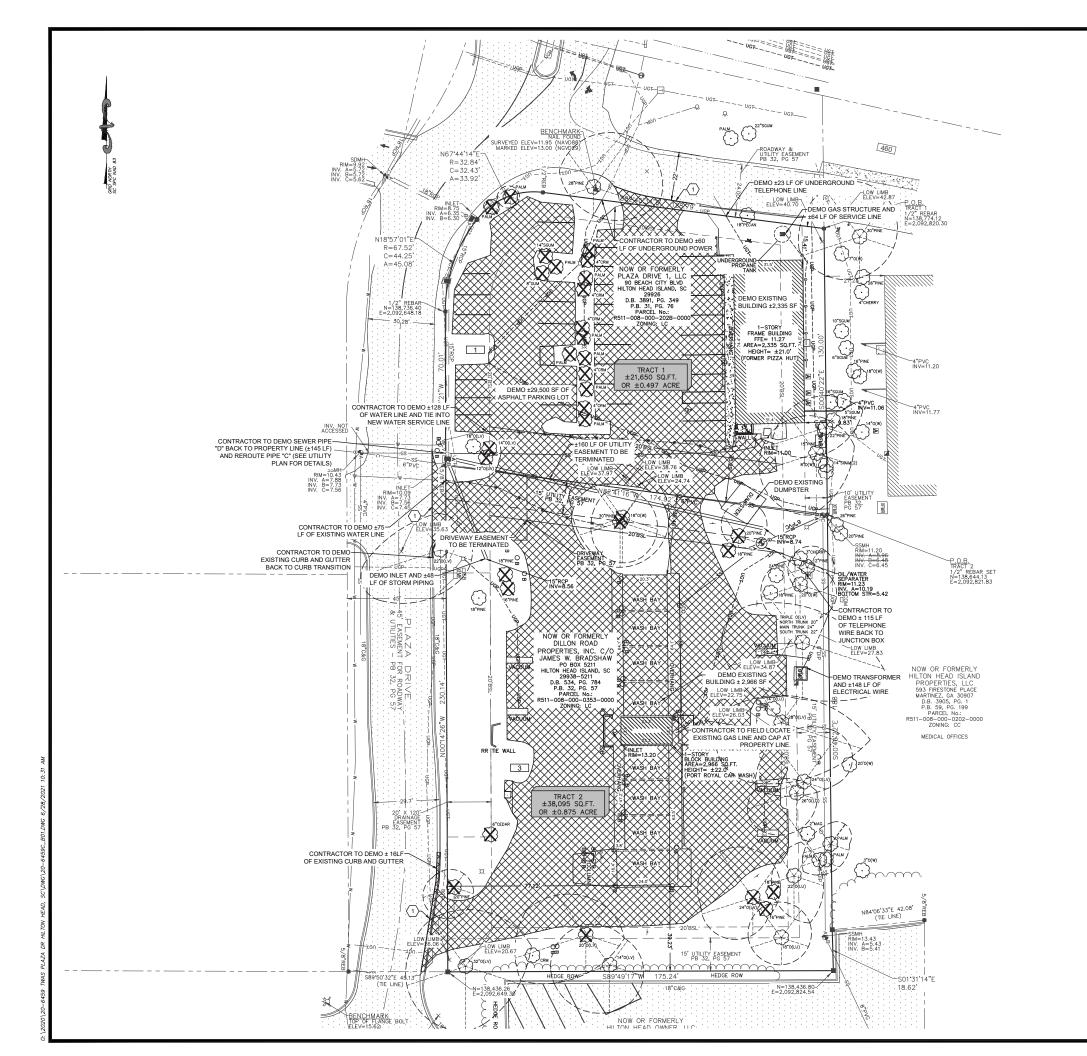

GENERAL NOTES

- DONALDSON, GARRETT AND ASSOCIATES, INC. PERFORMED AN EXISTING CONDITIONS / TOPOGRAPHICAL SURVEY OF THIS PARCEL ON 1/29/2021. THERE MAY BE EASEMENTS, SETBACK LINES OR OTHER MATTERS AFFECTING THIS PROPERTY THAT ARE NOT SHOWN ON THIS SURVEY.
- THERE ARE NO STATE WATERS LOCATED ON OR WITHIN 200' FEET OF SUBJECT PROPERTY.
- THE CONSTRUCTION AREA ULTIMATELY DRAINS TO TRIBUTARY OF BROAD CREEK.
- THE EXISTING SITE IS PIZZA HUT AND MULTI BAY CAR WASH.
- THE AREA FOR THIS PROJECT IS ± 1.37 ACRES WITH A DISTURBED AREA OF $\pm X.X$ ACRES.
- 72 HOURS PRIOR TO BEGINNING WORK AND 24 HOURS PRIOR TO RESUMING WORK AT 843-341-4600
- ALL CONSTRUCTION MATERIALS SHALL BE IN ACCORDANCE WITH THE SPECIFICATIONS AND REQUIREMENTS OF TOWN OF HILTON HEAD ISLAND. IF NOT OTHERWISE SPECIFIED, ALL MATERIALS AND CONSTRUCTION SHALL BE IN ACCORDANCE WITH THE SOUTH CAROLINA DOT STANDARD SPECIFICATIONS FOR HIGHWAY CONSTRUCTION (CURRENT EDITION) AND THE SOUTH CAROLINA DOT STANDARD HIGHWAY

DEMOLITION AND EXISTING CONDITIONS NOTES:

- CONTRACTOR SHALL FIELD VERIFY EXISTING CONDITIONS PRIOR TO BEGINNING DEMOLITION AND/OR NEW WORK. NOTIFY ENGINEER IN WRITING OF ANY DISCREPANCIES OR CONFLICTS.
- CONTRACTOR SHALL PROVIDE ADEQUATE TEMPORARY BARRIERS & WARNINGS TO LIMIT ACCESS TO PROJECT AREA TO ONLY THOSE PERSONNEL AUTHORIZED BY THE CONTRACTOR. INASMUCH AS AREAS ADJACENT TO PROJECT AREA WILL MAINTAIN "NORMAL OPERATIONS,"
- CONTRACTOR SHALL PROVIDE ADEQUATE DUST CONTROL MEASURES & SHALL MAINTAIN SAFE PASSAGEWAY FOR WORKERS & NON-WORKERS AS REQUIRED ADJACENT TO THE PROJECT SITE
- ALL ITEMS REMOVED OR DEMOLISHED BY THE CONTRACTOR WHICH ARE NOT LISTED BY THE SPECIAL PROVISIONS TO BE TURNED OVER TO THE OWNER SHALL BECOME THE PROPERTY OF THE CONTRACTOR & SHALL BECOME THE CONTRACTOR'S RESPONSIBILITY FOR PROPER DISPOSAL.
- DEMOLITION ACTIVITIES ARE NOT EXPECTED TO INCLUDE THE REMOVAL OF HAZARDOUS MATERIALS. IN THE EVENT THAT THAT HAZARDOUS MATERIALS ARE ENCOUNTERED OR SUSPECTED, CONTRACTOR SHALL NOTIFY ENGINEER IN WRITING OF THE MATERIAL.
- CONTRACTOR SHALL COORDINATE WITH APPROPRIATE UTILITY COMPANIES TO SCHEDULE ALL UTILITY & SERVICE INTERRUPTIONS TO OCCUPIED PORTIONS OF THE SITE.
- CONTRACTOR SHALL REMOVE TREES AS INDICATED ON CIVIL PLANS. CONTRACTOR SHALL USE CAUTION DURING ALL CONSTRUCTION ACTIVITIES TO PROTECT ALL TREES INDICATED TO REMAIN. CONTRACTOR SHALL BE RESPONSIBLE FOR ALL SITE CLEANUP, CLEARING AND GRUBBING PER SPECIFICATIONS. ALL TREES THAT HAVE A MARKETABLE VALUE SHALL BE SALVAGED. CONTRACTOR SHALL COORDINATE WITH OWNER AS TO THE TREES TO BE RELOCATED OR SOLD
- CONTRACTOR SHALL SAW CUT EXISTING CONCRETE AND ASPHALT PAVEMENTS AT LIMITS OF DEMOLITION TO LEAVE SMOOTH EDGE ON REMAINING CONCRETE/PAVEMENT.

FLOODPLAIN NOTES

THE PROPERTY SHOWN HEREON IS LOCATED IN FLOOD ZONE "A7" AS PER FLOOD INSURANCE RATE MAP FOR HILTON HEAD ISLAND AS SHOWN ON PANEL 9 OF 15 ON MAP NUMBER 450250 0009 D, WITH AN EFFECTIVE DATE OF 9/29/1986. ZONE "A7" DENOTES: AREAS OF 100-YEAR ELOOD: BASE FLOOD FLEVATIONS AND FLOOD HAZARD FACTORS DETERMINED

UTILITY NOTES:

- THE LOCATIONS OF UNDERGROUND UTILITIES AS SHOWN HEREON ARE BASED ON ABOVE-GROUND STRUCTURES PROVIDED BY THE SURVEYOR. LOCATIONS OF UNDERGROUND UTILITIES / STRUCTURES MAY VARY FROM LOCATIONS SHOWN HEREON
- UNDERGROUND UTILITIES / STRUCTURES MAY BE ENCOUNTERED. NO EXCAVATIONS WERE MADE DURING THE PROGRESS OF THIS SURVEY TO LOCATE BURIED UTILITIES / STRUCTURES.
- BEFORE EXCAVATIONS ARE BEGUN, GIVE THREE WORKING DAYS NOTICE TO THE UTILITIES PROTECTION CENTER AT 811 PRIOR TO ANY EXCAVATION IN ORDER THAT UNDERGROUND UTILITIES MAY BE LOCATED AND PROTECTED.

HATCH LEGEND:



DEMOLITION AREA



EXISTING CONCRETE



TREE REMOVAL

---- TREE DRIPLINE

SPECIAL NOTES:

 $\stackrel{1}{\longrightarrow}$ saw cut for smooth transition








SERVICES, INC.
349 Margie Drive. Sute 220
Wanner Robins, GA 31088
Pri. (473) 333-413088
Fax: (229) 439-7979
wannerrobins@eino-eng.com

TIDAL WAVE AUTO SPA
1 PLAZA DRIVE, HILTON HEAD ISLAND, SC 29926
HILTON HEAD ISLAND, BEAUFORT COUNTY, SOUTH CAROLINA

DRAWN BY CJM RAP SURVEYED BY: DGA SURVEY DATE: 1/29/2021 CHECKED BY: BHB SCALE: 1" = 20' 6/24/202

SHEET C3.1 OF 23



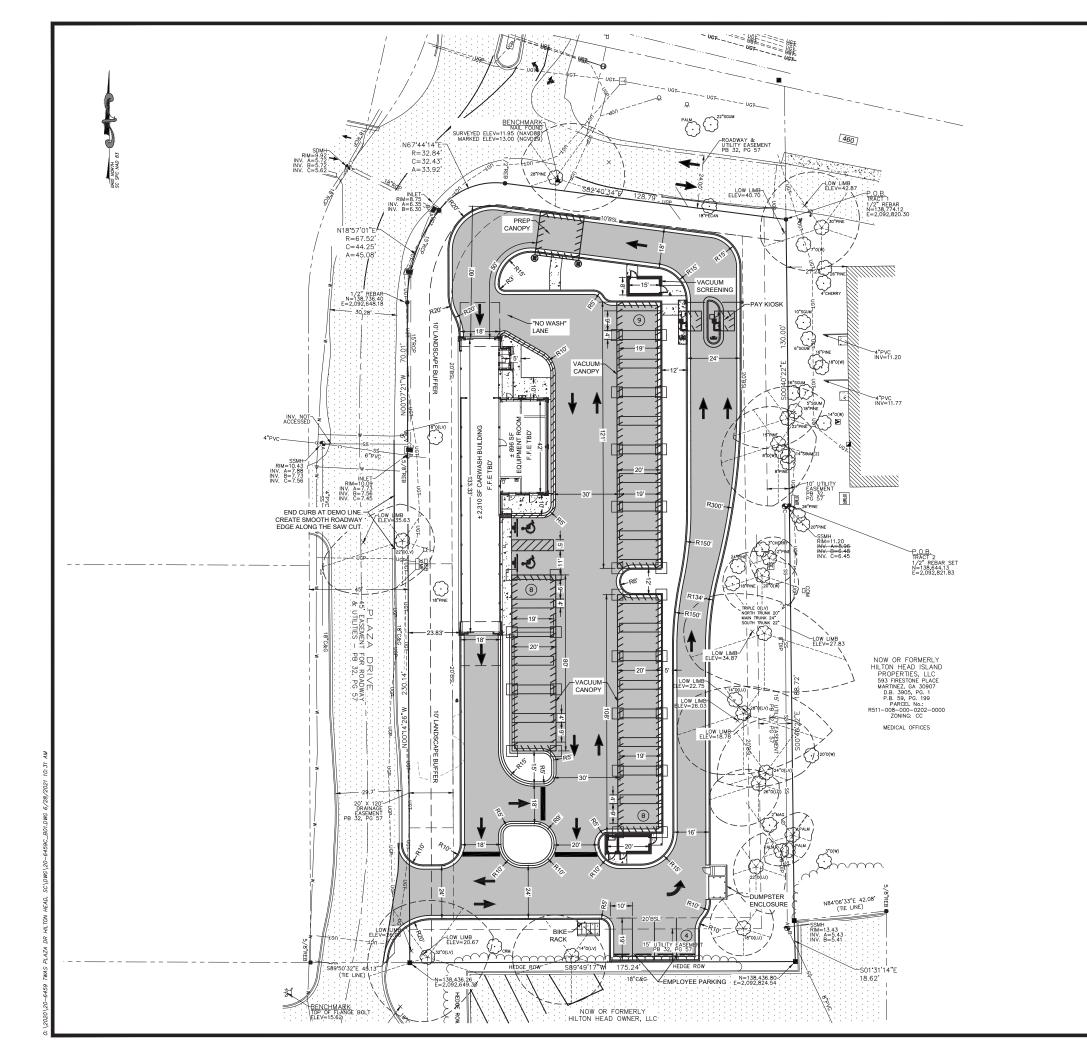

SITE INFORMATION:

ADDRESS: 1 PLAZA DRIVE, HILTON HEAD ISLAND, SOUTH CAROLINA 29926

PROPERTY AREA: ±1.37 ACRES

PROPERTY ZONING: LC - LIGHT COMMERCIAL (AIRPORT OVERLAY DISTRICT)

LANDSCAPE SETBACK: BUILDING SETBACKS: FRONT: 10' FRONT: 10' SIDE: 10' REAR: 0' SIDE: 20' REAR: 20'

PARKING NOTE:

PARKING REQUIRED: 10 SPACES PER WASH BAY 10 / 1 = 10 SPACES

PARKING PROVIDED: 27 STANDARD SPACES + 2 HANDICAPPED SPACES 29 TOTAL SPACES

SITE LAYOUT AND STAKING NOTES

- IF THE PLANS ARE NOT CLEAR OR DISCREPANCIES OCCUR, THE CONTRACTOR IS TO CONTACT EMC ENGINEERING SERVICES, INC AT 229-435-6133 FOR CLARIFICATION IMMEDIATELY.
- ALL NORTHING AND EASTING ARE TO THE FACE OF CURB, EDGE OF BUILDING.
- CONTRACTOR SHALL CAREFULLY EXAMINE ALL DOCUMENTS AND THE CONSTRUCTION SITE TO OBTAIN FIRST HAND KNOWLEDGE OF EXISTING CONDITIONS.
- ENTIRE SITE SHALL BE DRESSED TO UNIFORM, WELL DRAINED AND VISUALLY APPEALING SURFACE WITH A MINIMUM TOPSOIL LAYER OF FOUR INCHES.
- ALL STRIPING AND SIGNS SHALL CONFORM WITH THE SOUTH CAROLINA DEPARTMENT OF TRANSPORTATION AND THE MANUAL ON UNIFORM TRAFFIC CONTROL DEVICES (MUTCD) LATEST EDITION. PARKING STALL STRIPPING TO BE YELLOW WITH BLUE HANDICAPPED STRIPPING
- ALL HANDICAP PARKING SPACES AND ACCESSIBLE ROUTE SHALL CONFORM WITH THE AMERICAN WITH DISABILITY ACT DESIGN GUIDELINES AND SPECIFICATIONS LATEST EDITION.
- DIMENSIONS AND CURVE RADII ARE GIVEN TO FACE OF CURB. WHERE CURB AND GUTTER IS SHOWN. OTHERWISE DIMENSIONS ARE GIVEN TO THE EDGE OF PAVEMENT. CONTRACTOR IS TO COORDINATE WITH THE ARCHITECTURAL PLANS AS TO THE BUILDING LAYOUT AND DIMENSIONS

HATCH LEGEND:





CONCRETE SIDEWALK



4" HIGH ROLL CURB



EXISTING CONCRETE



CONCRETE PAVEMENT

PROPOSED ASPHALT

---- TREE DRIPLINE

PRE VS. POST DEVELOPED AREA:

PRE-DEVELOPED AREA: 1.37 AC POST DEVELOPED: 1.37 AC 0.86 AC IMPERVIOUS AREA: 0.82 AC IMPERVIOUS AREA: PERVIOUS AREA: 0.51 AC PERVIOUS AREA: 0.55 AC


EXISTING IMPERVIOUS COVERAGE IS: PROPOSED IMPERVIOUS COVERAGE IS: MAX. ALLOWED IMPERVIOUS COVERAGE IS: 60.0%




WAVE AUTO SPA HILTON HEAD ISLAND, SC 29926 BEAUFORT COUNTY, SOUTH CAROLI TIDAL V PLAZA DRIVE, H HEAD ISLAND, B

CJM RAP DESIGNED BY: SURVEYED BY: DGA
SURVEY DATE: 1/29/2021 CHECKED BY: 1" = 20'

SHEET C4.0 OF 23

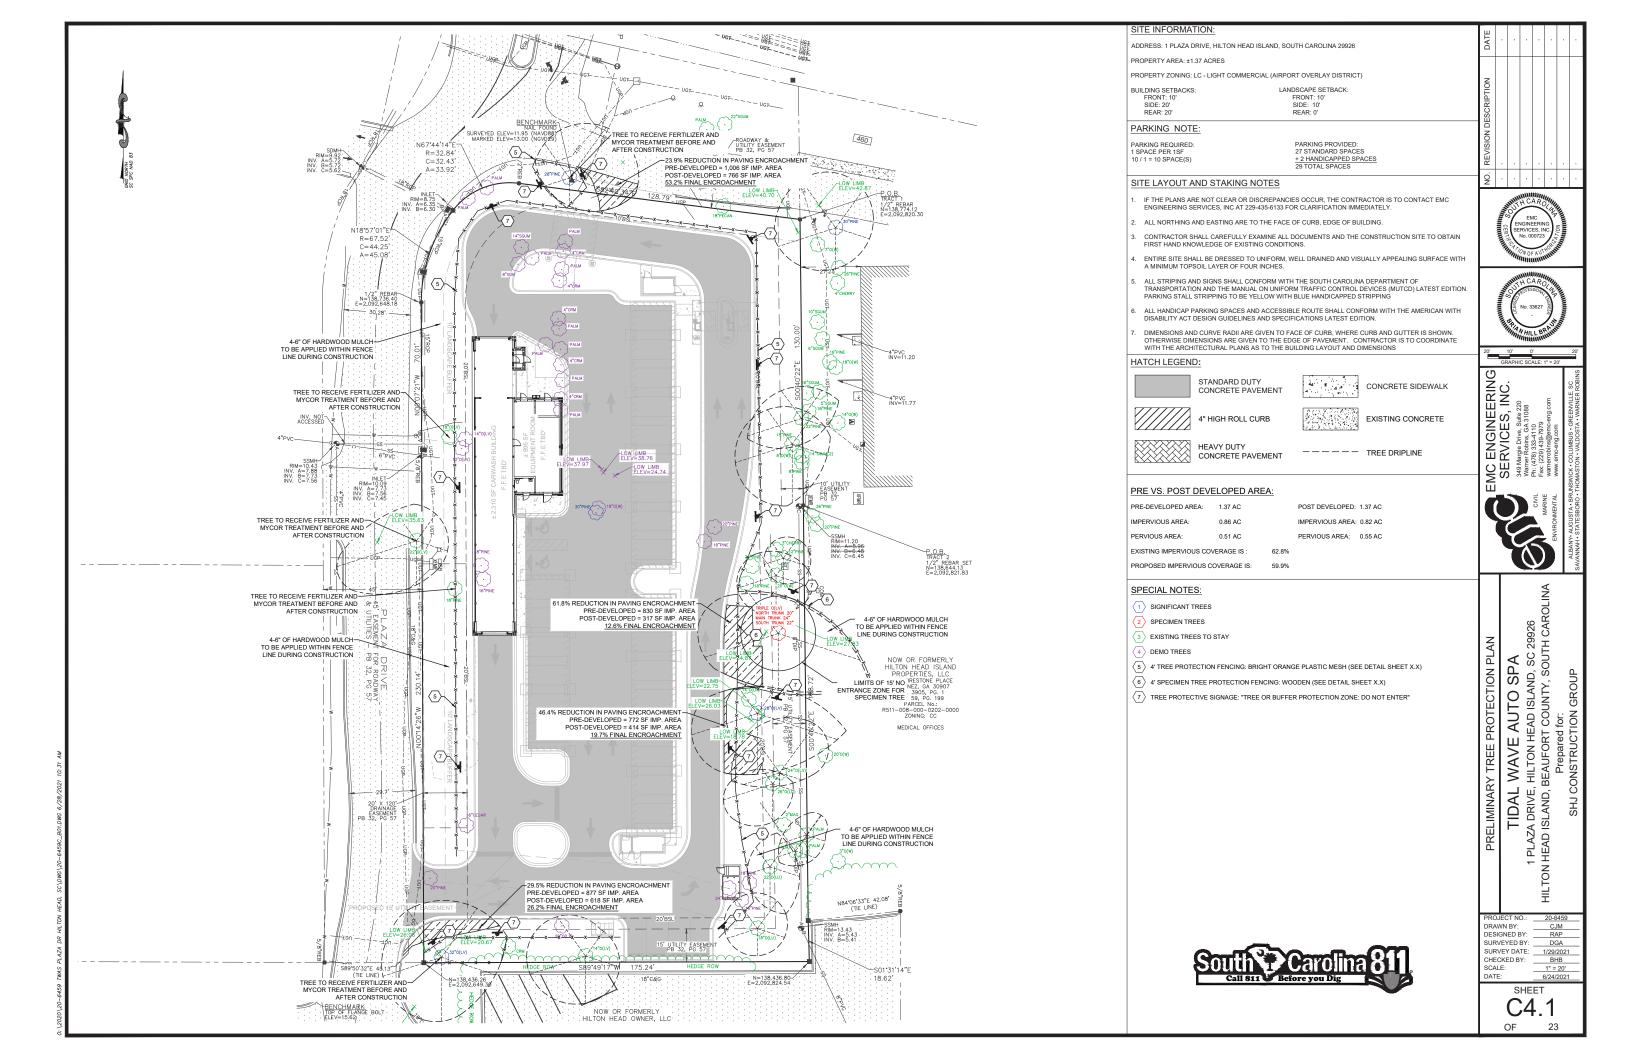

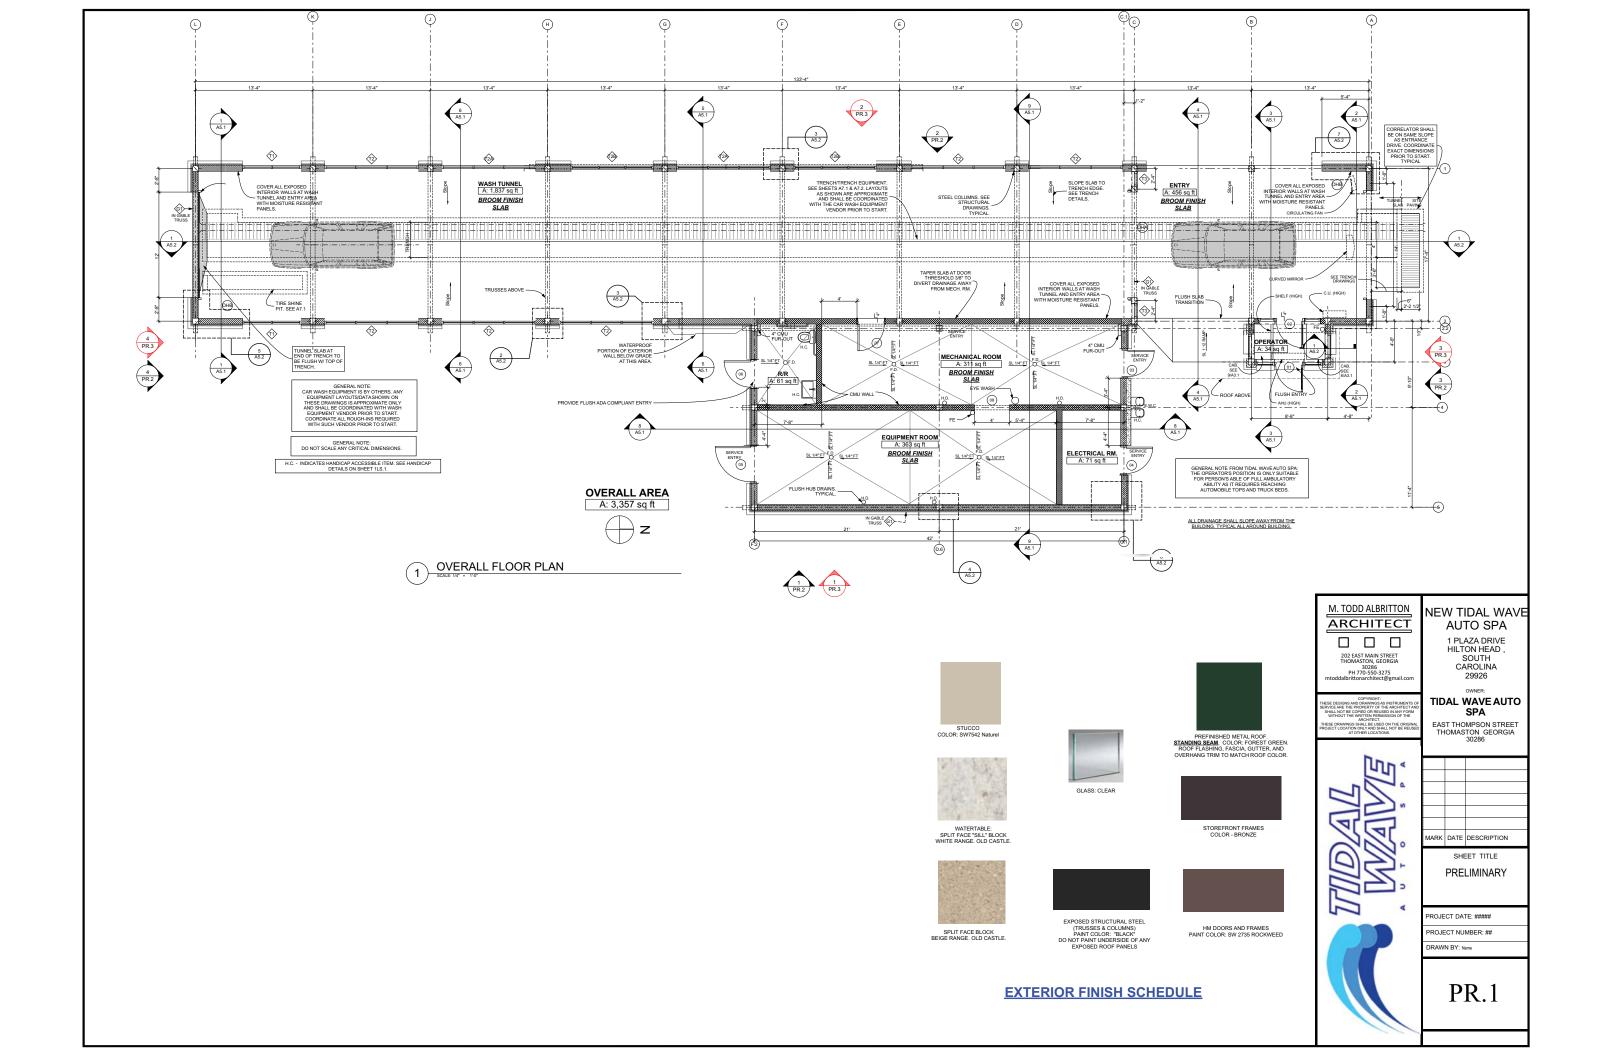








WEST ELEVATION

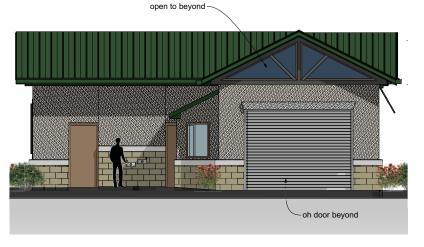

NORTH SIDE ELEVATION - ENTRY (3)





202 EAST MAIN STREET THOMASTON, GEORGIA 30286 PH 770-550-3275 iddalbrittonarchitect@gmail

THESE DESIGNS AND DRAWINGS AS INSTRUMENTS OF SERVICE ARE THE PROPERTY OF THE ARCHITECT AN SHALL NOT BE COPIED OR REUSED IN ANY POWN WITHOUT THE WRITTEN PERMISSION OF THE ARCHITECT AND ARCHITECT AND



NEW TIDAL WAVE AUTO SPA

1 PLAZA DRIVE HILTON HEAD , SOUTH CAROLINA 29926

TIDAL WAVE AUTO SPA EAST THOMPSON STREET THOMASTON GEORGIA 30286


ARK DATE DESCRIPTION

SHEET TITLE PRELIMINARY

PROJECT DATE: ##### PROJECT NUMBER: ##

DRAWN BY: Name

PR.3

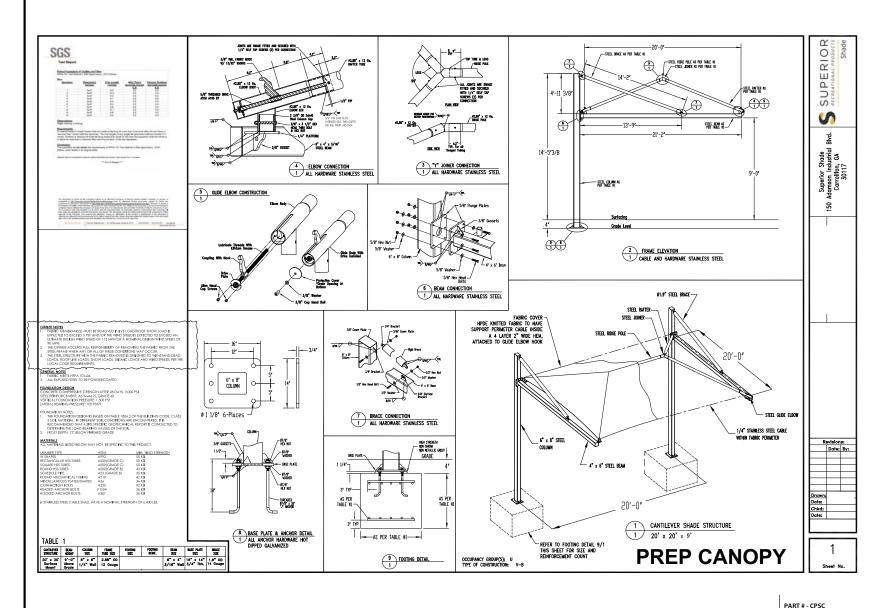



DESIGN INFORMATION INDICATED ON THIS SHEET IS DIAGRAMMATICAL IN NATURE AND NOT MEANT FOR CONSTRUCTION. FINAL DESIGN SHALL BE BY LICENSED STRUCTURAL ENGINEERS HIRED OR EMPLOYEED BY CANOPY MANUFACTURER.


DESIGNS SHALL MEET ALL RELATED LOCAL AND STATE CODES, REGULATIONS, AND LOAD CRITERIA.

COLORS:

COLORS TO MATCH MAIN CAR WASH BUILDING. COORDINATE WITH TIDAL WAVE, INC PRIOR TO START

DEFFERRED SUBMITTALS:

PRIOR TO CANOPY FABRICATION OR INSTALL. PROVIDE DETAILED DESIGN SHOP DRAWINGS PREPARED BY A STRUCTURAL ENGINEER HIRED OR EMPLOYEED BY CANOPY MANUFACTURER. SUCH DRAWINGS SHALL BE CERTIFIED/STAMPED AND SIGNED BY THE RELATED DESIGN ENGINEER. SUBMIT TO LOCAL AUTHORITIES FOR REVIEW AND APPROVAL PRIOR TO START OF ANY RELATED WORK.

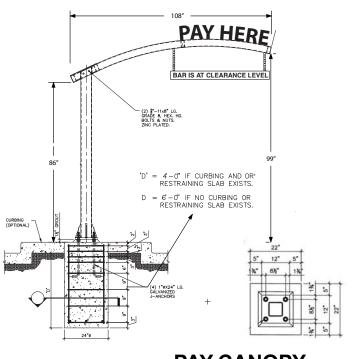

SPECIFICATIONS

NOTES:

tubing 2" x 4" x .250" wrapped with baked enamel aluminum.

Post is heavy steel 6" x 6" x .250"

PRE-ENGINEER
METAL BUILDING
COLUMN KRAPKV
VENEER TO MATCH PLAN - VAC CANOPY TYPICAL END ELEVATION TYPICAL SECTION TYPICAL SIDE ELEVATION VACUUM CANOPY CANOPY IS A PRE-ENGINEERD METAL BUILDING STRUCTURE.

SEE SITE PLAN

DEFFERRED SUBMITTALS: DEFFERRED SUBMITTALS:
PRIOR TO CANOPY FABRICATION OR INSTALL,
PROVIDE DETAILED DESIGN SHOP DRAWINGS
PREPARED BY A STRUCTURAL ENGINEER HIRED
EMPLOYEED BY CANOPY MANUFACTURER. SUC
DRAWINGS SHALL BE CERTIFICISTAMPED AIGNED BY THE RELATED DESIGN ENGINEER. SUE PRIOR TO START OF ANY RELATED WORK.

COLORS: COLORS TO MATCH MAIN CAR WASH BUILDING. OORDINATE WITH TIDAL WAVE, INC PRIOR TO STAR:

M. TODD ALBRITTON ARCHITECT

202 EAST MAIN STREET THOMASTON, GEORGIA 30286 PH 770-550-3275

TIDAL WAVE AUTO SPA

NEW TIDAL WAVE

AUTO SPA

1 PLAZA DRIVE HILTON HEAD.

SOUTH CAROLINA

EAST THOMPSON STREET THOMASTON GEORGIA 30286

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WITHOUT THE WRITTEN PERMISSION OF THE
ARCHITECT.
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ROJECT LOCATION ONLY AND SHALL NOT BE RE


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PROJECT DATE: ##### PROJECT NUMBER: ## RAWN BY: Name

PR.4

PAY CANOPY



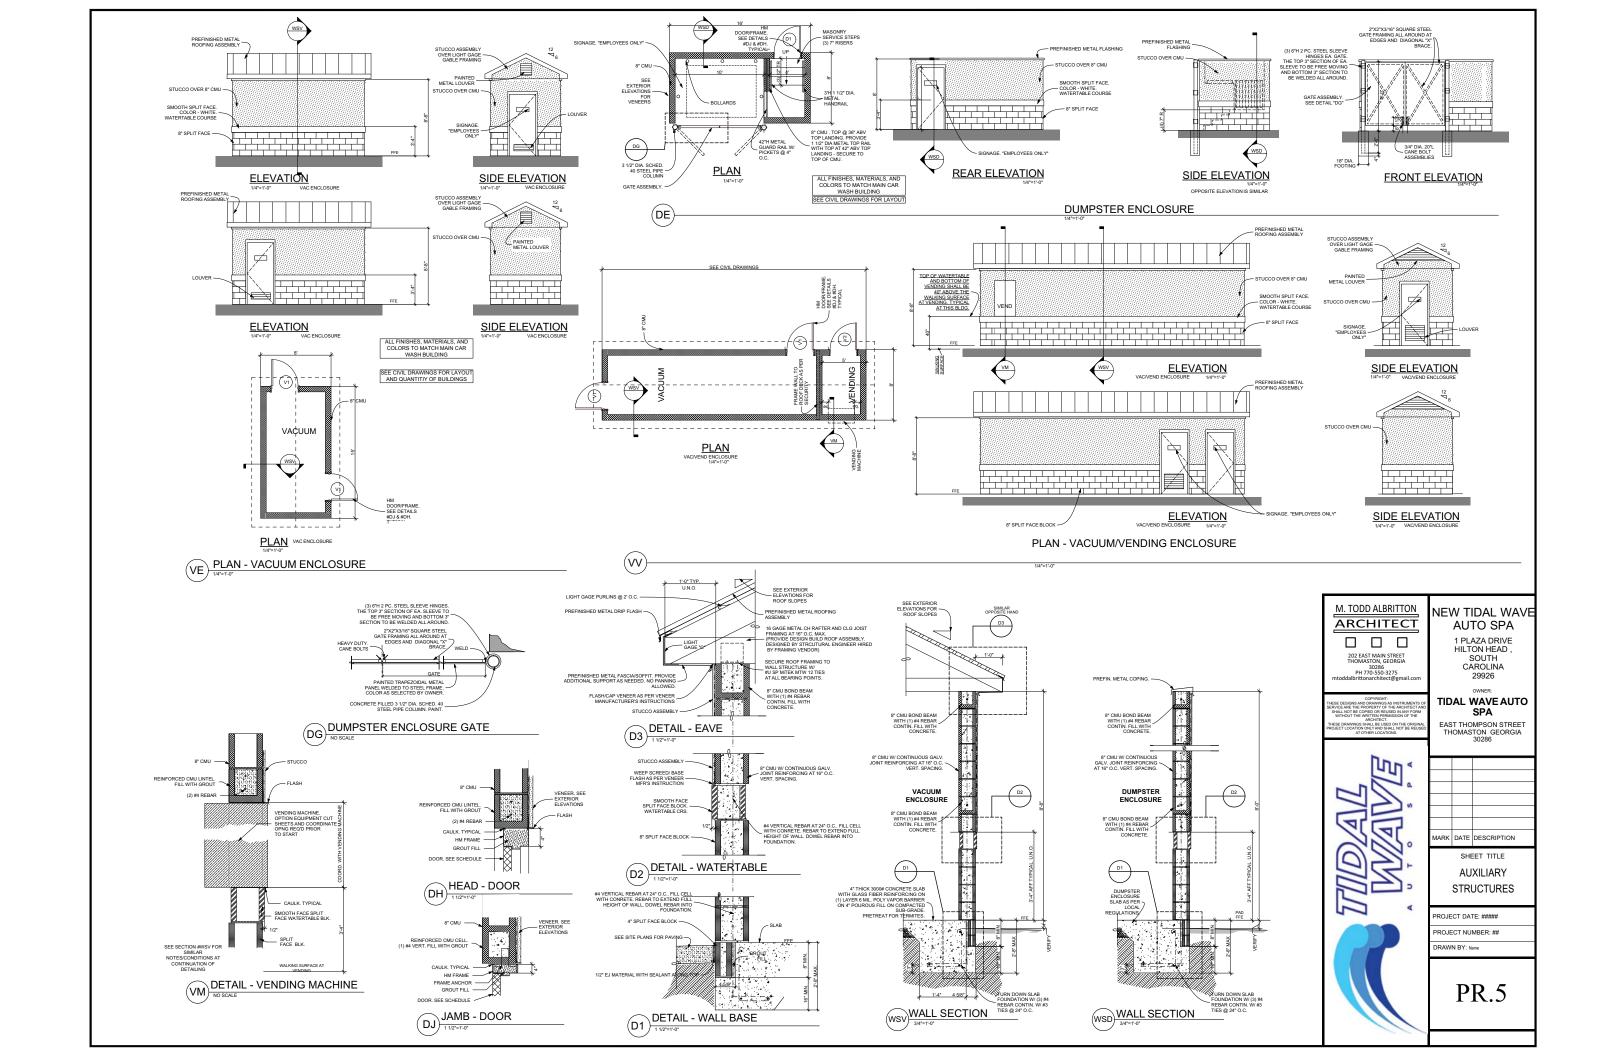

VIEW FROM EAST SIDE

- PREP CANOPY -PAY CANOPIES




1 BIRD'S EYE VIEW - OVERALL SITE



TIDAL WAVE AUTO SPA

EAST THOMPSON STREET THOMASTON GEORGIA 30286

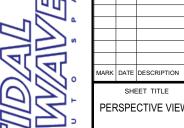

SHEET TITLE PERSPECTIVE VIEWS

PROJECT DATE: ##### PROJECT NUMBER: ##

DRAWN BY: Name

PR.6









M. TODD ALBRITTON ARCHITECT

202 EAST MAIN STREET THOMASTON, GEORGIA 30286 PH 770-550-3275 ddalbrittonarchitect@gmail.coi

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NEW TIDAL WAVE AUTO SPA

1 PLAZA DRIVE HILTON HEAD , SOUTH CAROLINA 29926

TIDAL WAVE AUTO SPA


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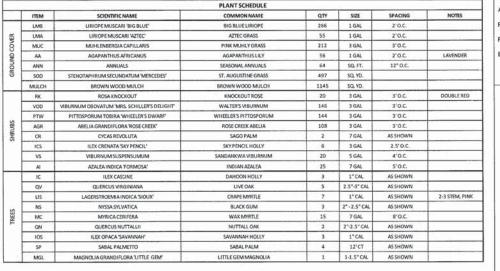
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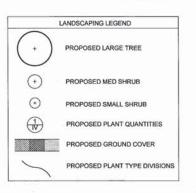
PERSPECTIVE VIEWS


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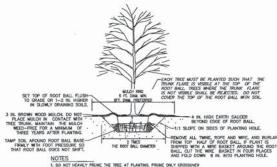






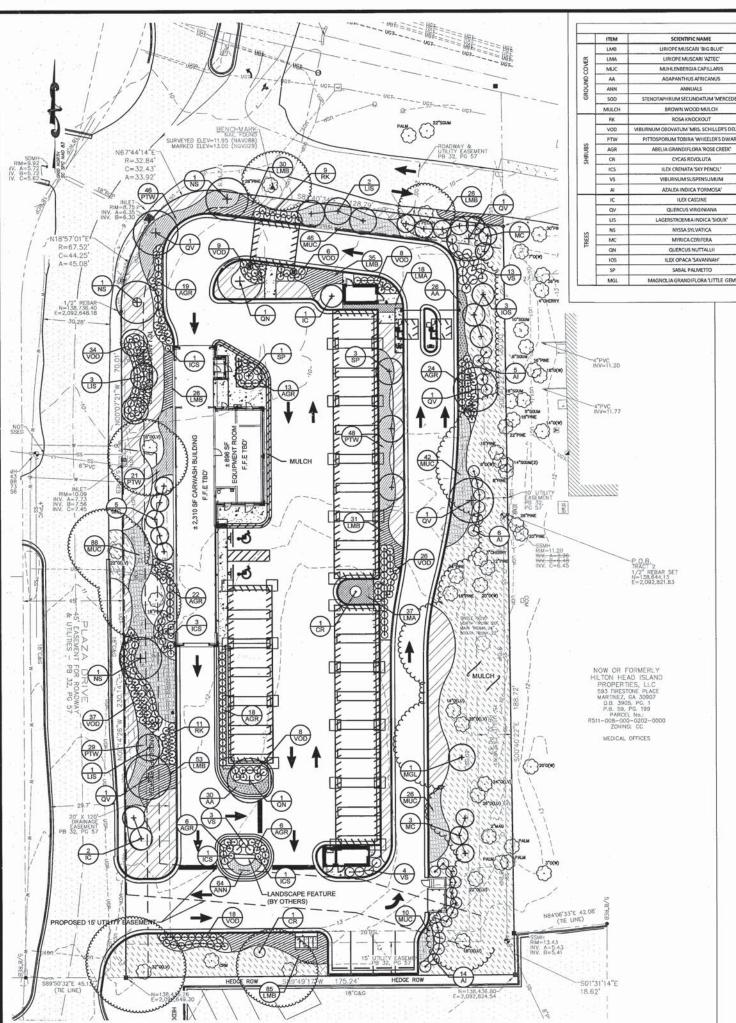

SHRUB PLANTING

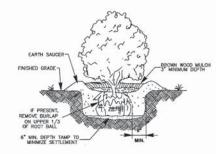

E THE THEE AT PLANTING, PRUINE ONLY CROSSION EADERS, AND BROKEN OR DEAD BRANCHES, SOM ATERIAL BRANCHES MAY BE PRUINED; HOWEVER, D BNAL BUDS OF BRANCHES THAT EXTEND TO THE

TREE PLANTING

SITE INFORMATION:

ADDRESS: 1 PLAZA DRIVE, HILTON HEAD ISLAND, SOUTH CAROLINA 29926

PROPERTY AREA: ±1.37 ACRES

PROPERTY ZONING: LC - LIGHT COMMERCIAL (AIRPORT OVERLAY DISTRICT)

LANDSCAPE SETBACK BUILDING SETBACKS: FRONT: 10' FRONT: 10' SIDE: 20' SIDE: 10'

LANDSCAPE NOTES:

- ALL DISTURBED AREAS NOT COVERED BY STRUCTURES, PAVING OR LANDSCAPING SHALL BE
- 2. ALL PLANT BEDS SHALL HAVE 3° OF BROWN WOOD MULCH AS REQUIRED.
- 3. ALL SOIL USED FOR PLANTING SHALL CONSIST OF REGIONALLY APPROPRIATE SOILS.
- ALL TREES LOCATED IN SOD AREAS SHALL HAVE A MULCH RING AROUND THEM WITH EDGING AS
- ALL PLANTINGS SHALL BE THOROUGHLY WATERED BY THE LANDSCAPE CONTRACTOR AT THE TIME OF THE PLANTINGS.
- THE SITE SHALL BE CLEAN OF ALL DEBRIS AND TRASH AFTER CONSTRUCTION HAS COMPLETED.
- NO LARGE TREES SHALL BE PLANTED WITHIN 10 FEET OF ANY UNDERGROUND UTILITY LINE OR STORM DRAIN. LANDSCAPE CONTRACTOR SHALL VERIFY LOCATION OF UTILITIES PRIOR TO BEGINNING PLANT INSTALLATION. LANDSCAPE ARCHITECT TO APPROVE ALL REVISIONS TO PLANT LOCATIONS. LANDSCAPE CONTRACTOR SHALL BE RESPONSIBLE FOR REPAIR OF ANY UTILITY LINES DAMAGED DURING PLANTING.
- 8. SEE DETAILS ON THIS SHEET FOR SHRUB AND TREE INSTALLATION.
- TOP SOIL SHALL BE ADDED TO WITHIN 1" OF TOP OF CURB / EDGE OF PAVEMENT
- AN UNDERGROUND IRRIGATION SYSTEM, SHALL BE INSTALLED AND SHALL COMPLY WITH ALL TOWN OF HILTON HEAD ISLAND CODES AND REGULATIONS AND ALSO COMPLY WITH THE LATEST NATIONAL ELECTRIC CODE RULES FOR ALL ELECTRIC WORKS AND MATERIALS.

GUARANTEE:
THE CONTRACTOR SHALL GUARANTEE ALL WORKMANSHIP AND PLANT MATERIAL TO BE FREE OF
DEFECTS FOR A PERIOD OF ONE (1) YEAR FROM FINAL ACCEPTANCE OF THE PROJECT, CONTRACTOR
SHALL REPLACE ANY PLANT MATERIAL FOUND TO BE DEFECTIVE WITHIN THE PERIOD OF GUARANTEE
AT NO COST TO THE OWNER, EXCEPT REPAIRS OR REPLACEMENT NECESSITATED BY DAMAGE BY
OTHERS OR DIEBACK DUE TO INSUFFICIENT IRRIGATION/WATERING SCHEDULE.

12. CONTRACTOR TO INSTALL LANDSCAPING AROUND SIGN IN ACCORDANCE WITH APPROVED SIGNAGE PACKAGE.

IRRIGATION NOTES:

- ALL LANDSCAPE AREAS AND LAWNS ADJACENT TO PAVED AREAS AND/OR STREETS ARE TO BE FULLY
- IRRIGATION SYSTEM TO INCLUDE ALL SPRAY HEADS, VALVES AND CONTROLLERS.
- A SEPARATE METER AND BACKFLOW PREVENTOR WILL BE REQUIRED (SEE UTILITY PLAN).

LANDSCAPE GRADING NOTES:

- CONTRACTOR TO GRADE ALL AREAS ON THE LANDSCAPE PLAN, INCLUDING RIGHT-OF-WAY, HATCHED FOR SEEDING & SODDING.
- TOP SOIL SHALL BE STRIPPED FROM ALL CUT AND FILL AREAS, STOCKPILED AND REDISTRIBUTED OVER GRADED AREAS. PROVIDE EROSION AND SEDIMENTATION CONTROLS AROUND STOCKPILES DURING CONSTRUCTION.
- 3. TILL SOIL TO A DEPTH OF 4" MINIMUM.
- 4. REMOVE ALL ROCKS LARGER THAN 1" MEASURED IN LARGEST DIRECTION.
- GRADE ALL AREAS TO MAINTAIN POSITIVE SLOPE AWAY FROM BUILDING.
- ALL GRADED AREAS TO RECEIVE SEED OR SOD, TOP SOIL, STRAW AND WATER UNTIL A HEALTHY STAND OF GRASS IS OBTAINED.

LAWN SEEDING AND SODDING NOTES:

- ALL LAWNS FROM FACE OF THE BUILDING AND ON THE SIDE WHERE THERE IS PARKING OR A STREET ARE REQUIRED TO BE FULLY SODDED. ALL OTHER LANDSCAPE AREAS TO RECEIVE SEED.
- AREAS TO RECEIVE SEED OR SOD SHALL BE CLEAN OF DEBRIS AND FREE OF WEEDS.
- TONS PER ACRE. STRAW, NETTING, AND OTHER ANTI-EROSION MATERIALS TO BE REMOVED AFTER ESTABLISHED LAWN.
- MAINTENANCE SHALL BEGIN IMMEDIATELY AFTER SEEDING. WATER REGULARLY TO KEEP LAWN AREAS MOIST TO MAXIMIZE GERMINATION AND MAINTAIN OPTIMUM GROWTH AND SURVIVAL TO ACHIEVE AN ACCEPTABLE STAND OF ESTABLISHED LAWN PRIOR TO THE STORE POSSESSION DATE, FREE OF ERODED OR BARE AREAS.

LANDSCAPE CALCULATIONS:

PER 100FT: 2 OVERSTORY TREES (10 REQUIRED; 3 EXISTING, 7 PROPOSED), 4 UNDERSTORY TREES (20 REQUIRED; 20 PROPOSED), 10 EVERGREEN SHRUBS (49 REQUIRED; >49 PROVIDED)

SITE TREES REQUIRED = 38°

SITE THEES REQUIRED = 36"

1.12" - CAT 1 PROVIDED: 5 QV (12.5"); 5 IOS (5")

2.8" - CAT 2 PROVIDED: 1 QN (2"); 4 NS (8")

3.12" - CAT 3 PROVIDED: 4 SP (24"); 3 JV (6")

4.1" - CAT 4 PROVIDED: 2 LIS (2")

HATCH LEGEND:

MULCHED AREAS



SODDED AREAS



DESIGNED BY RAP SURVEYED BY: DGA 1/29/2021 CHECKED BY: BHB SCALE: 1" = 20' DATE: 6/24/2021

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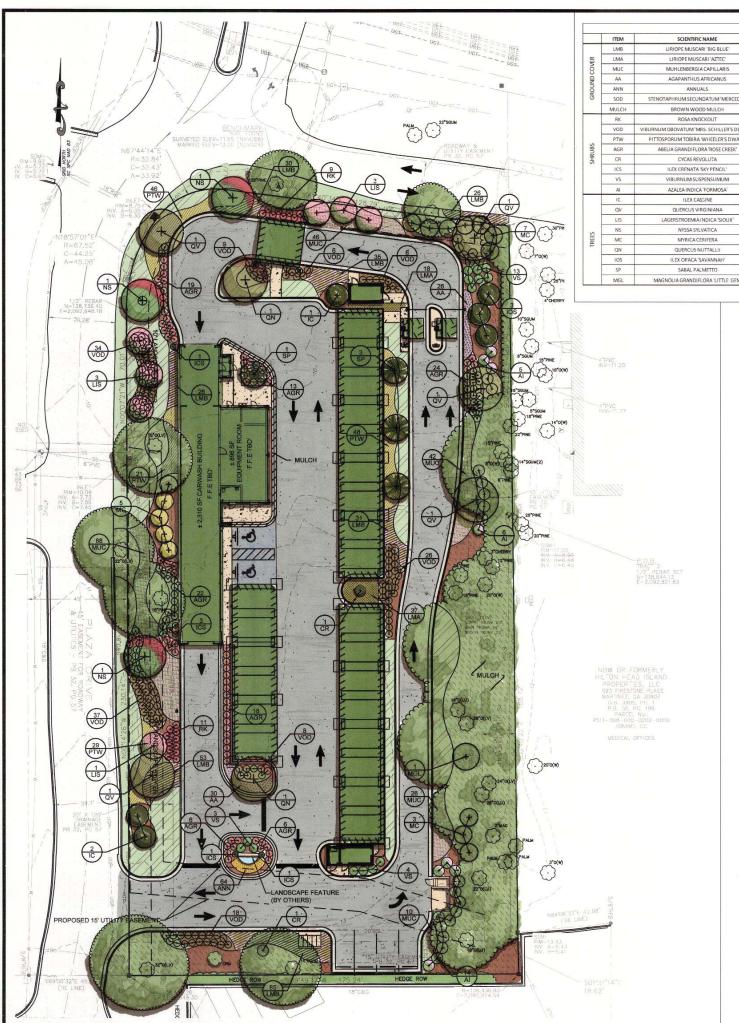
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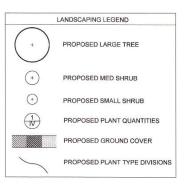
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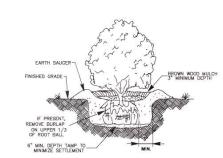
BEAUFORT

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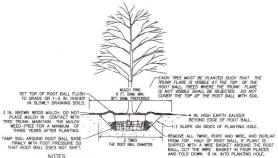






NOTES

SHRUB PLANTING



TREE PLANTING

SITE INFORMATION:

ADDRESS: 1 PLAZA DRIVE, HILTON HEAD ISLAND, SOUTH CAROLINA 29926

PROPERTY AREA: ±1.37 ACRES

PROPERTY ZONING: LC - LIGHT COMMERCIAL (AIRPORT OVERLAY DISTRICT)

FRONT: 10' SIDE: 20' SIDE: 10'

LANDSCAPE NOTES:

- ALL DISTURBED AREAS NOT COVERED BY STRUCTURES, PAVING OR LANDSCAPING SHALL BE SODDED.
- 2. ALL PLANT BEDS SHALL HAVE 3" OF BROWN WOOD MULCH AS REQUIRED.
- ALL SOIL USED FOR PLANTING SHALL CONSIST OF REGIONALLY APPROPRIATE SOILS.
- ALL TREES LOCATED IN SOD AREAS SHALL HAVE A MULCH RING AROUND THEM WITH EDGING AS
- ALL PLANTINGS SHALL BE THOROUGHLY WATERED BY THE LANDSCAPE CONTRACTOR AT THE TIME OF THE PLANTINGS.
- THE SITE SHALL BE CLEAN OF ALL DEBRIS AND TRASH AFTER CONSTRUCTION HAS COMPLETED
- NO LARGE TREES SHALL BE PLANTED WITHIN 10 FEET OF ANY UNDERGROUND UTILITY LINE OR STORM DRAIN. LANDSCAPE CONTRACTOR SHALL VERIFY LOCATION OF UTILITIES PRIOR TO BEGINNING PLANT INSTALLATION. LANDSCAPE ARCHITECT TO APPROVE ALL REVISIONS TO PLANT LOCATIONS. LANDSCAPE CONTRACTOR SHALL BE RESPONSIBLE FOR REPAIR OF ANY UTILITY LINES DAMAGED DURING PLANTING.
- SEE DETAILS ON THIS SHEET FOR SHRUB AND TREE INSTALLATION.
- TOP SOIL SHALL BE ADDED TO WITHIN 1" OF TOP OF CURB / EDGE OF PAVEMENT
- AN UNDERGROUND IRRIGATION SYSTEM, SHALL BE INSTALLED AND SHALL COMPLY WITH ALL TOWN OF HILTON HEAD ISLAND CODES AND REGULATIONS AND ALSO COMPLY WITH THE LATEST NATIONAL ELECTRIC CODE RULES FOR ALL ELECTRIC WORKS AND MATERIALS.

GUARANTEE: THE CONTRACTOR SHALL GUARANTEE ALL WORKMANSHIP AND PLANT MATERIAL TO BE FREE OF

DEFECTS FOR A PERIOD OF ONE (1) YEAR FROM FINAL ACCEPTANCE OF THE PROJECT. CONTRACTOR SHALL REPLACE ANY PLANT MATERIAL FOUND TO BE DEFECTIVE WITHIN THE PERIOD OF GUARANTEE AT NO COST TO THE OWNER, EXCEPT REPAIRS OR REPLACEMENT NECESSITATED BY DAMAGE BY OTHERS OR DIEBACK DUE TO INSUFFICIENT IRRIGATION/WATERING SCHEDULE.

CONTRACTOR TO INSTALL LANDSCAPING AROUND SIGN IN ACCORDANCE WITH APPROVED SIGNAGE PACKAGE.

IRRIGATION NOTES:

- ALL LANDSCAPE AREAS AND LAWNS ADJACENT TO PAVED AREAS AND/OR STREETS ARE TO BE FULLY
- IRRIGATION SYSTEM TO INCLUDE ALL SPRAY HEADS, VALVES AND CONTROLLERS.
- 3. A SEPARATE METER AND BACKFLOW PREVENTOR WILL BE REQUIRED (SEE UTILITY PLAN).

LANDSCAPE GRADING NOTES:

- CONTRACTOR TO GRADE ALL AREAS ON THE LANDSCAPE PLAN, INCLUDING RIGHT-OF-WAY, HATCHED FOR SEEDING & SODDING.
- TOP SOIL SHALL BE STRIPPED FROM ALL CUT AND FILL AREAS. STOCKPILED AND REDISTRIBUTED OVER GRADED AREAS. PROVIDE EROSION AND SEDIMENTATION CONTROLS AROUND STOCKPILES DURING CONSTRUCTION.
- 3. TILL SOIL TO A DEPTH OF 4" MINIMUM.
- 4. REMOVE ALL ROCKS LARGER THAN 1" MEASURED IN LARGEST DIRECTION.
- 5. GRADE ALL AREAS TO MAINTAIN POSITIVE SLOPE AWAY FROM BUILDING.
- 6. ALL GRADED AREAS TO RECEIVE SEED OR SOD, TOP SOIL, STRAW AND WATER UNTIL A HEALTHY STAND OF GRASS IS OBTAINED.

LAWN SEEDING AND SODDING NOTES:

- ALL LAWNS FROM FACE OF THE BUILDING AND ON THE SIDE WHERE THERE IS PARKING OR A STREET ARE REQUIRED TO BE FULLY SODDED. ALL OTHER LANDSCAPE AREAS TO RECEIVE SEED.
- AREAS TO RECEIVE SEED OR SOD SHALL BE CLEAN OF DEBRIS AND FREE OF WEEDS.
- SEED MIX TO BE DROUGHT TOLERANCE FESCUE OR REGIONAL SPECIFIC BLEND. $\frac{1}{2}$, TO $\frac{1}{3}$ OF THE SEED MIXTURE TO BE ANNUAL RYE TO AIDE IN LIMITING EROSION OF PERENNIAL SEED DURING GERMINATION
- STRAW SHALL BE THRESHED STRAW OF HAY, OATS, WHEAT, BARLEY, OR RYE. SPREAD AT A RATE OF 2 1/2 TONS PER ACRE. STRAW, NETTING, AND OTHER ANTI-EROSION MATERIALS TO BE REMOVED AFTER ESTABLISHED LAWN.
- MAINTENANCE SHALL BEGIN IMMEDIATELY AFTER SEEDING, WATER REGULARLY TO KEEP LAWN AREAS MOIST TO MAXIMIZE GERMINATION AND MAINTAIN OPTIMUM GROWTH AND SURVIVAL TO ACHIEVE AN ACCEPTABLE STAND OF ESTABLISHED LAWN PRIOR TO THE STORE POSSESSION DATE, FREE OF ERODED OR BARE AREAS.

LANDSCAPE CALCULATIONS:

TYPE A - OPTION 2 BUFFER = 490 LF
PER 100FT: 2 OVERSTORY TREES (10 REQUIRED; 3 EXISTING, 7 PROPOSED), 4 UNDERSTORY TREES (20 REQUIRED; 20 PROPOSED), 10 EVERGREEN SHRUBS (49 REQUIRED; >49 PROVIDED)

SITE TREES REQUIRED = 38'

1. 12" - CAT 1 PROVIDED: 5 QV (12.5"); 5 IOS (5")
2. 8" - CAT 2 PROVIDED: 1 QN (2"); 4 NS (8")
3. 12" - CAT 3 PROVIDED: 4 SP (2"); 4 NS (8")
4. 1" - CAT 4 PROVIDED: 2 LIS (2")

HATCH LEGEND:



MULCHED AREAS



SODDED AREAS



DRAWN BY SURVEYED BY DGA SURVEY DATE: 1/29/2021 CHECKED BY: BHB SCALE: 6/24/2021

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DESIGN TEAM/DRB COMMENT SHEET

The comments below are staff recommendations to the Design Review Board (DRB) and do NOT constitute DRB approval or denial.

PROJI	ECT NAME: Tidal W	ave Auto Spa	DRB#: DRB-0015	89-2021
DATE	: 06/30/2021			
		Approval Approval with Con		
RECO	MMENDED CONDITION	ONS: The following shall be addressed a	t Final.	
1.	Revise the window size	e to be more in proportion to the façade o	n the Plaza Drive side of th	ne "Carwash Building".
2.	Increase the roof overh	ang to be more in keeping with Island Ch	aracter.	
3.	Reconsider the cantilev	er canopies in favor of a structural system	n more in keeping with Isla	and Character.
4.	Increase the landscape	and or add a structure to screen the entra	nce to the "Carwash Buildi	ng" and the "Prep Canopy" from
	William Hilton Pkwy.			
5.	Provide a tree protection	n plan.		

ARCHITECTURAL DESIGN				
DESIGN GUIDE/LMO CRITERIA	Complies Yes	No	Not Applicable	Comments or Conditions
Design is unobtrusive and set into the natural environment				Because the "Carwash Building" is so close to the Plaza Drive the windows on that side of the building need to be reduced.
Overhangs are sufficient for the façade height.		\boxtimes		Building overhangs should reflect lowcountry architectural vernacular.
Windows are in proportion to the facade		\boxtimes		Windows are not in proportion to the façade. Colored lights will be visible from Plaza Drive.
Accessory elements are design to coordinate with the primary structure				The cantilevered canopies at the "Pay Kiosk" and the "Prep Canopy" appear unchanged from the previous submission and do not coordinate with the primary structure and are not in keeping with Island Character as described in the Design Guide.

LANDSCAPE DESIGN				
DESIGN GUIDE/LMO CRITERIA	Complies Yes	No	Not Applicable	Comments or Conditions
Provides for a harmonious setting for the site's structures, parking areas or other construction				Provide landscape and or structure to screen the entrance to the "Carwash Building" and the "Prep Canopy" from William Hilton Pkwy.
NATURAL RESOURCE PROTECTIO)N			
DESIGN GUIDE/LMO CRITERIA	Complies Yes	No	Not Applicable	Comments or Conditions
An effort has been made to preserve existing trees and under story plants		\boxtimes		Provide a tree protection plan at Final.
Supplemental and replacement trees meet LMO requirements for size, species and number				Mitigation trees must be 10' tall min. and 2" caliper.
MISC COMMENTS/QUESTIONS				
This project was withdrawn at the applicants request du	ring the June 8 th r	neeting.		



Town of Hilton Head Island

Community Development Department One Town Center Court

Hilton Head Island, SC 29928 Phone: 843-341-4757 Fax: 843-842-8908

www.hiltonheadislandsc.gov

FOR OFFICIAL USE ONLY
Date Received:
Accepted by:
DRB #:
Meeting Date:

Applicant/Agent Name: Leonard V. Martelli	Company: Martelli Architects, LLC
Mailing Address: 39 Persimmon Street, Suite 601	City: Bluffton State: SC Zip: 29910
Геlephone: <u>843-757-5776</u> Fax: <u>843-501-2309</u>	E-mail: LMartelli@MartelliArchitects.com
Project Name: Lot 10, Capital Business Park P	Project Address: 85 Capital Drive
Parcel Number [PIN]: R 5 1 1 0 0 8 0 0 0 0	0 4 4 0 0 0 0 0
Zoning District: LI C	Overlay District(s):DRB
CORRIDOR RI	EVIEW, MAJOR
	, and the second
DESIGN REVIEW BOARD (DRB	B) SUBMITTAL REQUIREMENTS
Digital Submissions may be accepted via e-mail by call	ing 843-341-4757.
Project Category:	
Concept Approval – Proposed Development	Alteration/Addition
Final Approval – Proposed Development	Sign
Submittal Requirements for All projects:	
jurisdiction of an ARB, the applicant shall submit	e of Action (if applicable): When a project is within the t such ARB's written notice of action per LMO Section 16- te ARB to meet this requirement is the <u>responsibility of the</u>
	ment \$175, Final Approval – Proposed Development \$175, heck made payable to the Town of Hilton Head Island.
Additional Submittal Requirements:	
Concept Approval – Proposed Development	
	es, existing topography and the location of trees meeting the and if applicable, location of bordering streets, marshes and
beaches.	and if approadic, rotation of bordering streets, marsiles and
1 — · · · · · · · · · · · · · · · · · ·	ccess, significant topography, wetlands, buffers, setbacks,
views, orientation and other site features that may	on the project, its goals and objectives and how it
reflects the site analysis results.	ent of the project, its goals and objectives and now it
Context photographs of neighboring uses and arch	
	location of new structures, parking areas and landscaping.
Conceptual sketches of primary exterior elevation development, materials, colors, shadow lines and	

Last Revised 01/21/15 1

review guidelines of Sec. 16-3-106.F.3. Final site development plan meeting the Final site lighting and landscaping plans Final floor plans and elevation drawings colors with architectural sections and det A color board (11"x17" maximum) contatelevations, and indicating the manufactural Any additional information requested by	meeting the requirements of Appendix D: D-6.H and D-6.I. (1/8"=1'-0" minimum scale) showing exterior building materials and tails to adequately describe the project. ining actual color samples of all exterior finishes, keyed to the
additional materials. A survey (1"=30' minimum scale) of pro	proval of proposed development as listed above, plus the following perty lines, existing topography and the location of trees meeting the 04.C.2, and if applicable, location of bordering streets, marshes and
For freestanding signs:	g dimensions, type of lettering, materials and actual color samples. ng location of sign in relation to buildings, parking, existing signs,
Photograph or drawing of the building de Location, fixture type, and wattage of an	epicting the proposed location of the sign. y proposed lighting. ddline date in order to be reviewed by the DRB per LMO Appendix D: D-23.
A representative for each agenda item is strongly enco Are there recorded private covenants and/o	uraged to attend the meeting. r restrictions that are contrary to, conflict with, or prohibit
the proposed request? If yes, a copy of the p this application. YES NO	orivate covenants and/or restrictions must be submitted with
factual, and complete. I hereby agree to abide	on on this application and all additional documentation is true by all conditions of any approvals granted by the Town of Hilton ons shall apply to the subject property only and are a right of
I further understand that in the event of a Stateset forth in the Land Management Ordinary of	te of Emergency due to a Disaster, the review and approval time nay be suspended.
Juna V. Martin	06/29/2021
SIGNAZURZ 1 Last Revi ed 01/21/15	DATE

PROJECT NARRATIVE FOR LOT 10 CAPITAL BUSINESS PARK 85 CAPITAL DRIVE TOWN OF HILTON HEAD JOB NO. 2285

The proposed project will consist of constructing a 6,029 SF building with paved parking for Dyess Air (an HVAC contractor). The property is a 1.16 acre site located at 85 Capital Drive in the Capital Business Park. It is currently undeveloped and is zoned LI (light industrial).

The site plan shows a 20' adjacent street setback/buffer from Capital Drive, a 40' adjacent street setback/15' buffer from Leg-of-Mutton Road and a 20' adjacent use setback/20' buffer on the east and southern property lines. The zoning standards allow 65% impervious on the site and the site plan shows 51%. The owner is proposing to install twenty-six (26) parking spaces due to his business's requirements:

Parking

2,200 SF of office space x 1 space/350 GFA office = 6 spaces 3,829 SF of indoor storage x 1 space/1,300 GFA of storage = 3 spaces Fleet Vehicles = $\frac{17}{2}$ spaces

Total = 26 Spaces

His fleet of service trucks are parked on site each night and that many parking spaces are required for his employee's personal vehicles and his company trucks; seventeen (17) of the spaces are shown to be pervious.

The sides and rear of the building will have overhead doors for his trucks to load and unload out of daily, so paving will be required up to the foundation on both sides and the building. We have shown minimum drive aisle widths of 24' for two-way traffic (and where parking abuts) and 30' in the rear to accommodate his delivery trucks. There is also a $15' \times 40'$ Loading Zone shown at the rear of the building. The site will take access off of Capital Drive with two (2) full movement accesses shown to accommodate his delivery trucks.

One specimen tree (a 40" live oak) is located at the rear of the site. No paving or soil compaction is shown to occur within 15' of the trunk of the tree and low impact brick pavers will be placed at or above grade under the canopy of the tree as needed to allow traffic circulation at the rear of the site.

Drainage for the project will be provided by the Capital Business Park master planned storm water detention system.

Electrical and telephone service will be provided by Palmetto Electric and Hargray, respectively. Water and sewer service will be provided by the Hilton Head Public Service District. Fire protection and emergency services are provided by the Town of Hilton Head Fire Department.

The design and layout of the building and materials used were chosen to try and make the building blend with the natural surroundings on the lot and neighborhood. We used subtle greys, tans and browns for the siding materials, brick to tie the building into the ground plane, as well as introducing some exposed wood rafters and beams for the roof over the main entrance of the building to try and bring some warmth to the building. We utilized additional plantings along the front on Capital Drive and down the side on Leg O Mutton Rd as well.



THE TOWN OF HILTON HEAD ISLAND DESIGN REVIEW BOARD (DRB) – NOTICE OF ACTION

PROJECT NAME:	85 Capital Drive	PROJECT #: DRB-002636-2020
PROJECT ADDRESS:	85 Capital Drive	
CATEGORY:	Alteration/Addition	
ACTION DATE:	January 12, 2021	NOTICE DATE: January 15, 2021
APPLICANT/AGENT:	Leonard Martelli, Martelli Architects 39 Persimmon Street Bluffton, SC 29910 E-mail: lmartelli@martelliarchitects.c	om
On the above meeting da	nte your Application received the follo	wing action:
APPROVED AS		
	TH THE SPECIFIC CONDITIONS L	ISTED BELOW
☐ DENIED		
	AT THE APPLICANTS REQUEST	
2. All sidewalk conne	to retain as much vegetation in the Leg (ections should align with the doors. of the light fixtures.	O Mutton buffer as is possible.
UNLESS A DEVELOPMENT 2-103.H) IS APPROVED OR REVIEW IS NOT REQUIRE	T PLAN (SEE LMO 16-2-103.G) OR SMALL , WHERE DEVELOPMENT PLAN REVIEW	ONE YEAR FROM THE DATE OF THIS NOTICE RESIDENTIAL DEVELOPMENT (SEE LMO 16- V OR SMALL RESIDENTIAL DEVELOPMENT LETED. YOU HAVE THE RIGHT TO APPEAL O 16-2-103-I.4.c.ii.
PLEASE CONTACT THE C	OMMUNITY DEVELOPMENT DEPARTM S ARE REQUIRED FROM THE DEVELOPM	CONSTITUTE AUTHORITY TO PROCEED. ENT AT 843-341-4757 TO FIND OUT IF OTHER MENT REVIEW AND ZONING, BUILDING, OR
BY:	//////////////////////////////////////	an Designer

14" & 17" Aluminum Modified Warehouse Shades



RMWHS14 14"W x 81/4"H RMWHS17

17"W x 91/4"H

1 Medium 200W 100" Wire **UL Listed Wet Locations**

- Finishes: -

RMWHS14 ABR • Architectural Bronze RMWHS14 BA • Brushed Aluminum RMWHS14 SB • Satin Black RMWHS14 SG • Satin Green RMWHS14 SR • Satin Red RMWHS14 WH • White

RMWHS17 ABR • Architectural Bronze RMWHS17 BA • Brushed Aluminum RMWHS17 SB • Satin Black RMWHS17 SG • Satin Green RMWHS17 SR • Satin Red RMWHS17 WH · White

14" & 17" Warehouse Shades



RWHS14 14"W x 81/4"H

RWHS17 17"W x 9¼"H

1 Medium 200W 100" Wire **UL Listed Wet Locations**

Finishes: -

RWHS14 ABR • Architectural Bronze RWHS14 GA • Galvanized RWHS14 GY · Gray

RWHS14 NB · Navy Blue RWH\$14 NC · Natural Copper RWHS14 SB · Satin Black RWHS14 SG · Satin Green RWHS14 SR • Satin Red

RWHS14 WH · White

RWHS17 ABR • Architectural Bronze RWH\$17 GA • Galvanized RWHS17 GY · Gray

RWHS17 NB • Navy Blue RWHS17 NC · Natural Copper RWHS17 SB · Satin Black RWHS17 SG · Satin Green RWHS17 SR • Satin Red RWHS17 WH · White

10" & 12" Emblem Shades



RES₁₀ 10"W x 13"H RES12

12"W x 141/2"H

RES10 WH • White

1 Medium 200W 100" Wire **UL Listed Wet Locations**

15" & 18" Railroad Shades



RRRS14 14"W x 91/2"H RRRS18 18"W x 10"H

1 Medium 100W 100" Wire **UL Listed Wet Locations** Removable glass guard and inside etched glass included

Finishes:

RES10 ABR • Architectural Bronze RES10 GA · Galvanized RES10 SB · Satin Black RES10 SG • Satin Green RES10 SR · Satin Red

RES12 ABR · Architectural Bronze RES12 GA · Galvanized RES12 SB · Satin Black RES12 SG • Satin Green RES12 SR · Satin Red

RES12 WH · White

Finishes:

RRRS14 ABR · Architectural Bronze RRRS14 CP • Copper RRRS14 GA • Galvanized RRRS14 SB • Satin Black

RRRS18 ABR • Architectural Bronze RRRS18 CP · Copper RRRS18 GA · Galvanized RRRS18 SB • Satin Black



MARTELLI ARCHITECTS, LLC

39 PERSIMMON ST. #60I, BLUFFTON, SC 299IO PH: (843) 757-5776 FAX: (843) 50I-2309

DYESS FINISH SAMPLES



Walls – Board & Batten – SW7673 Service Yard



Walls - Horizontal Siding – SW7668



Walls - Horizontal Siding – SW7103 Parapet Trim & Bermuda Shutters



Walls – Porcelain Tile – Willow




Foundation – Savannah Gray Classic Georgia-Cherokee Brick





Walls - Ash Gray



Roof – Standing Seam Metal – Medium Bronze

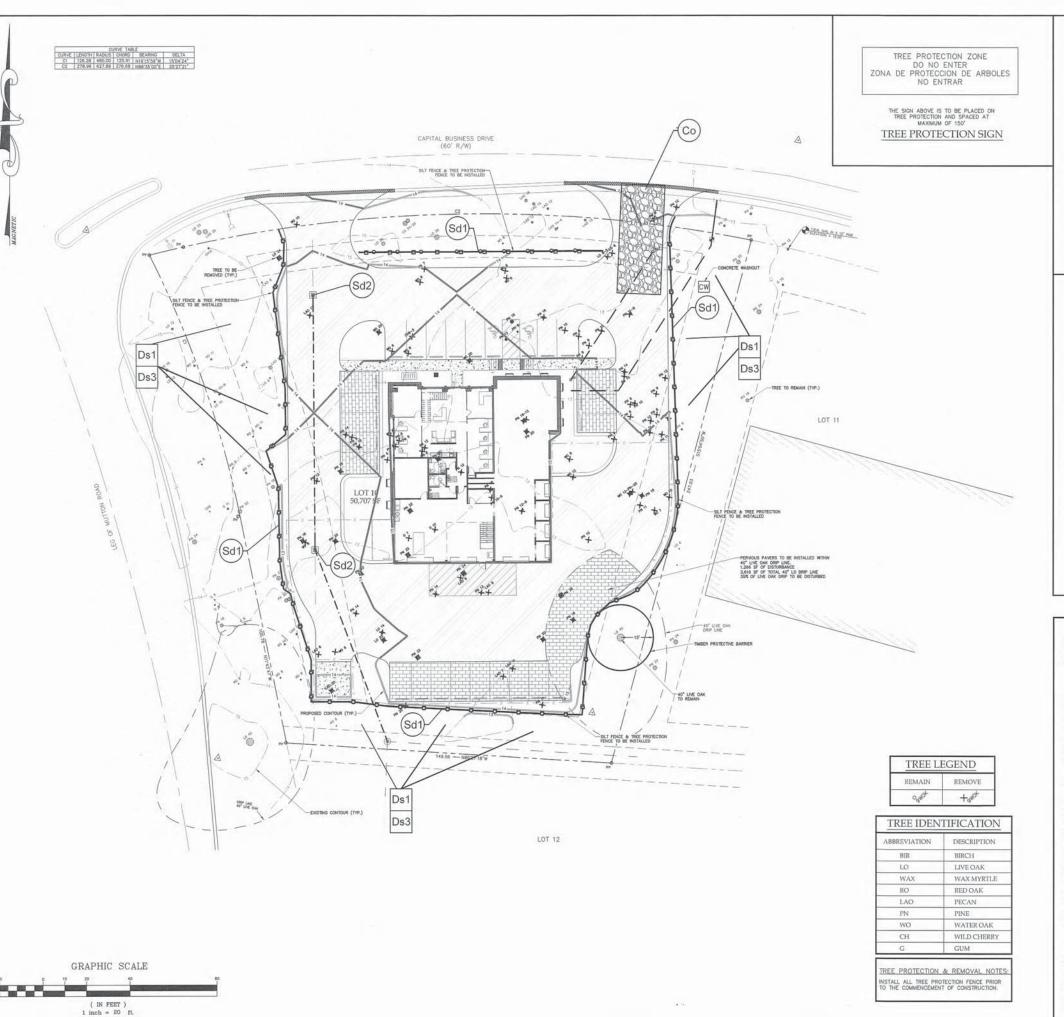

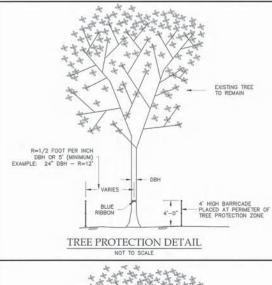

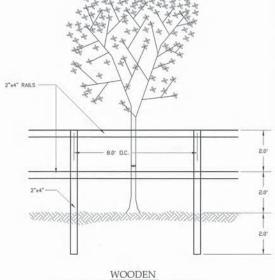

SEDIMENT & EROSION CONTROL NOTES:

TREE PROTECTION BARRIER DETAIL

SCALE: TREE PROTECTION & REMOVAL AND SEDIMENT & EROSION CONTROL PLAN

PLAN REVISIONS
DESCRIPTION

CAPITAL BUSINESS PARK TOWN OF HILTON HEAD BEAUFORT COUNTY, SC

ENGINEERING CONSULTANTS, INC.

CAROLINA I PO BOX 294 BEAUFORT, SC 29901

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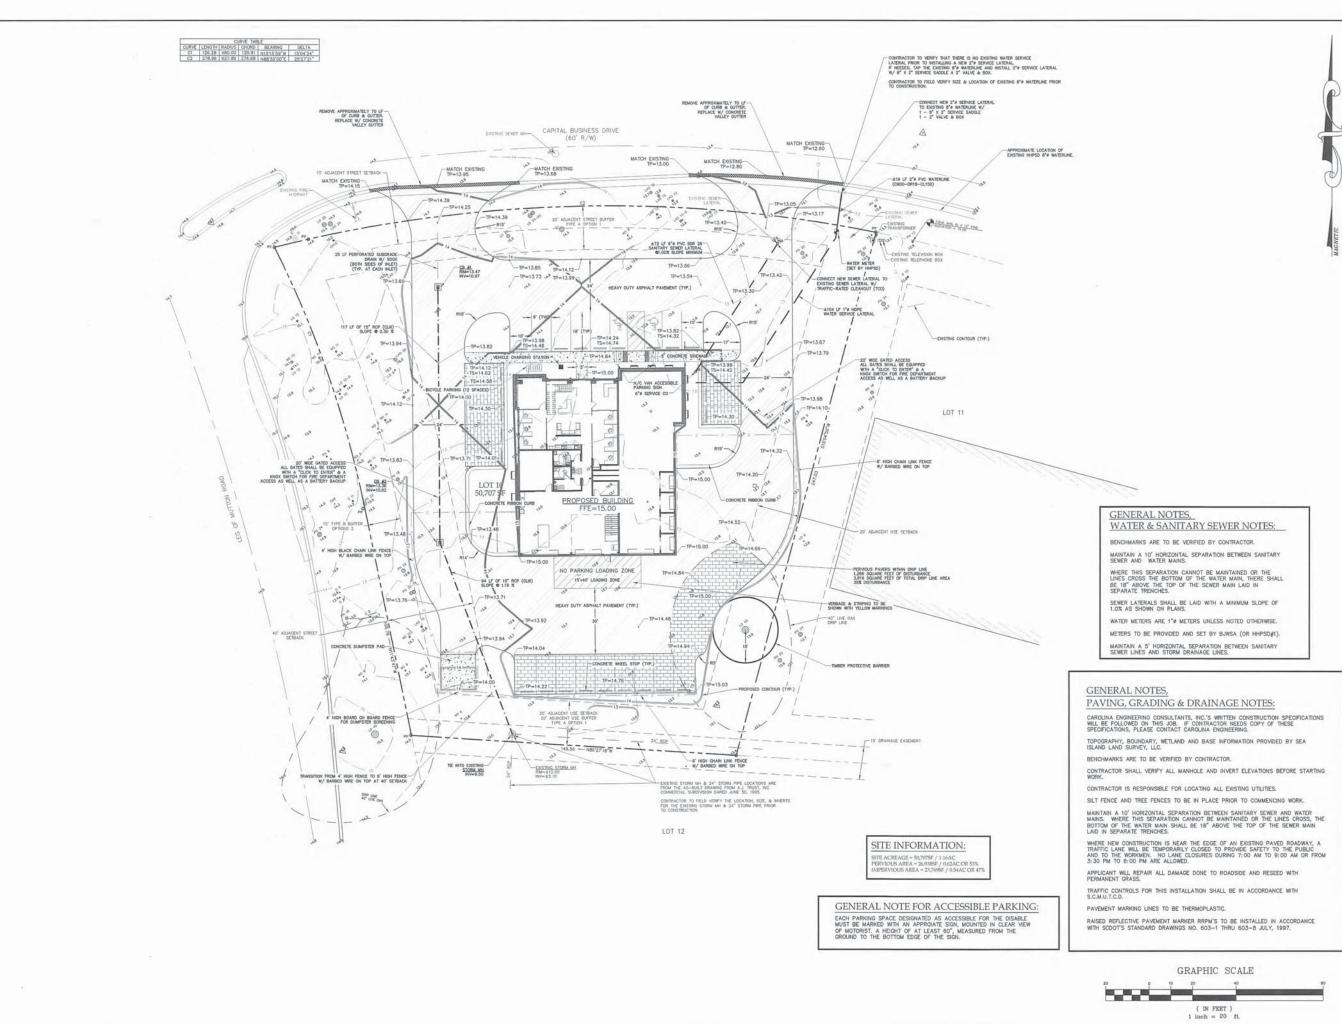
PROJECT:

REVISED: DRAWN BY:

ENGINEER:

2285 01/28/21 04/21/21 TOC DRK 1"=20'

OF 6





CONSULTANTS, INC. 843/322-0553 NEERING.COM 843/322-0556 (FAX) O CAPITAL BUSINESS P TOWN OF HILTON HEAD BEAUFORT COUNTY, SC

ENGINEERING

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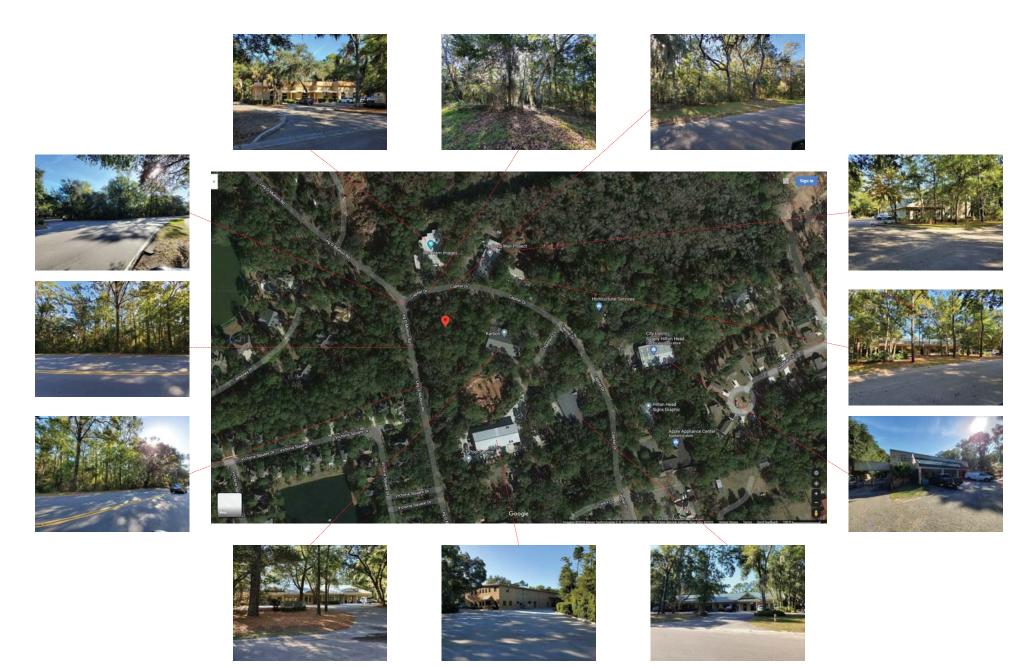
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CAROLINA 1 PO BOX 294 BEAUFORT, SC 29901


PROIECT: 2285 01/29/21 DATE: REVISED: 04/21/21 DRAWN BY: TOC ENGINEER: DRK SCALE:

SITE DEVELOPMENT PLAN

OF 6



Site Photos

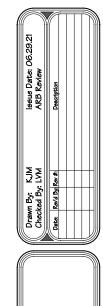


Proposed New Office for:
Dyess Air
85 Capitol Business Drive
Hilton Head Island, SC




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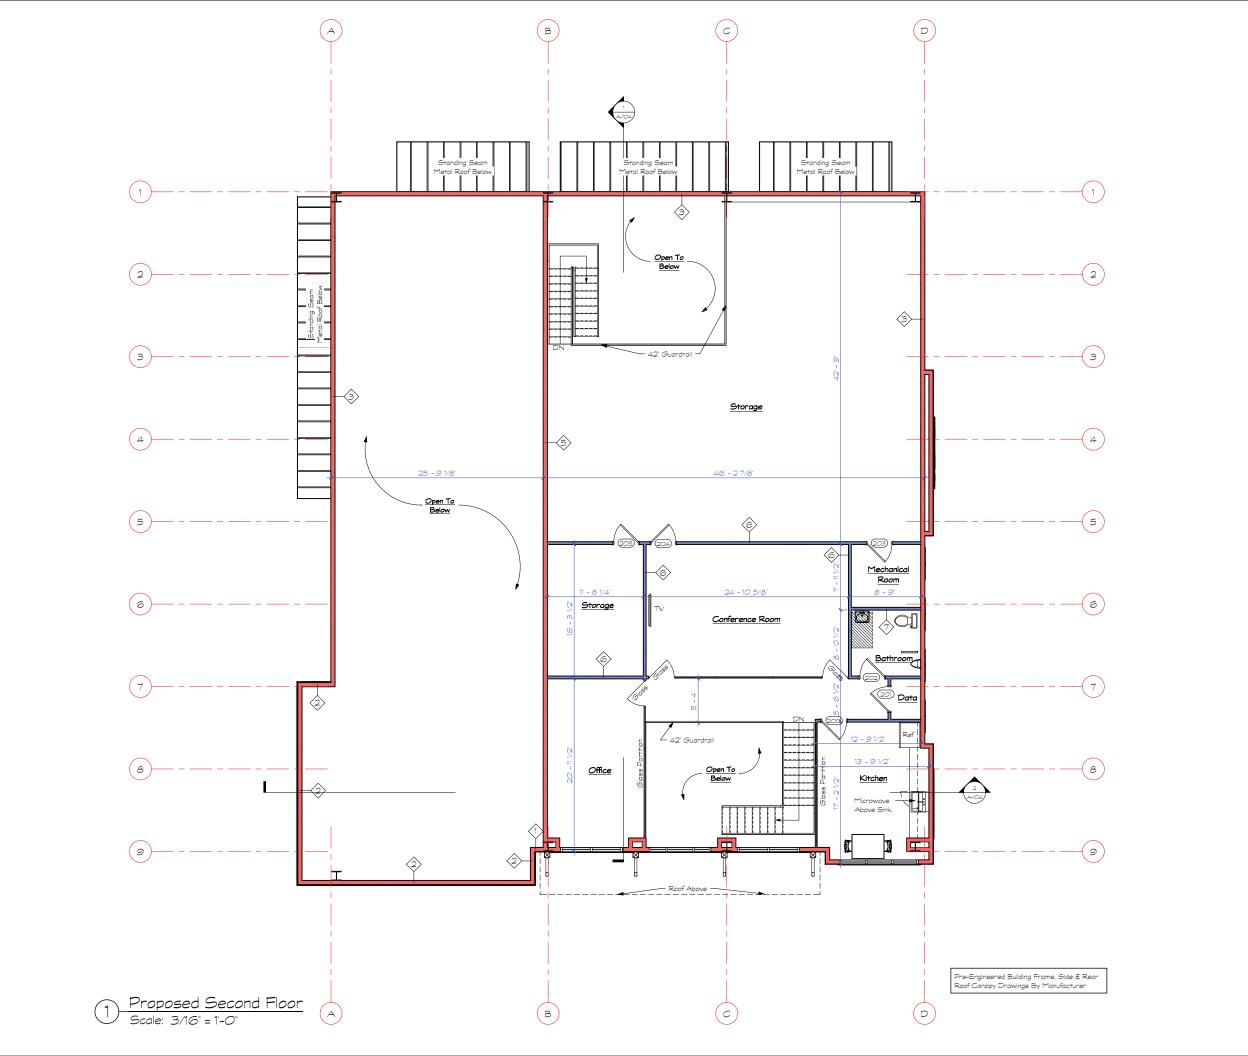





Proposed New Office for:
Dyess Air
85 Capitol Business Drive
Hilton Head Island, SC

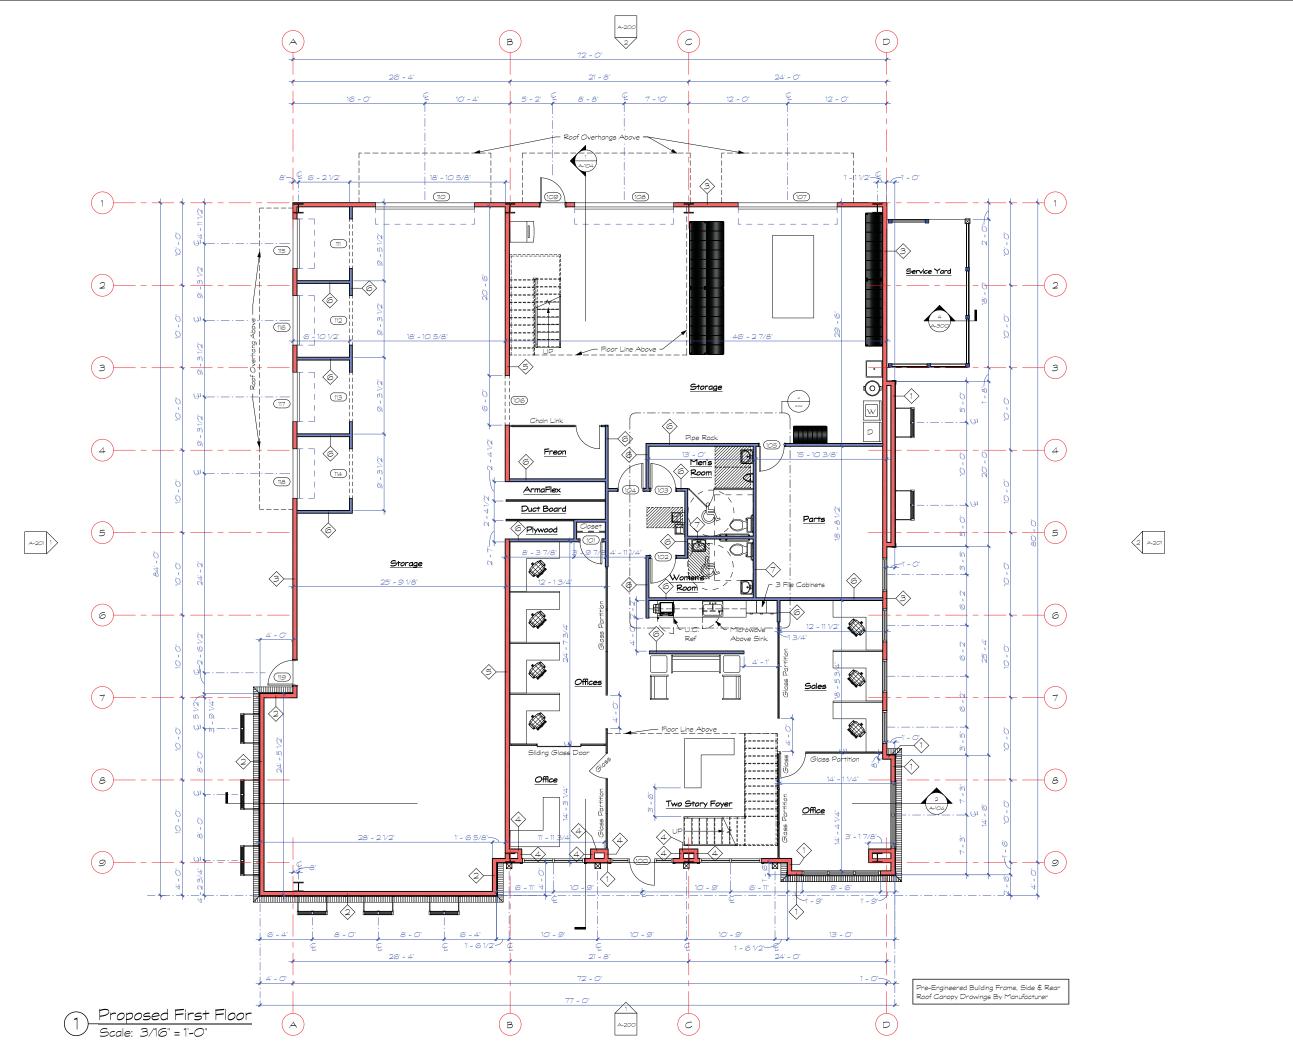

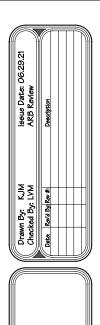





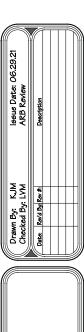



Proposed New Office for:
Dyess Air
85 Capitol Business Drive




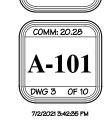

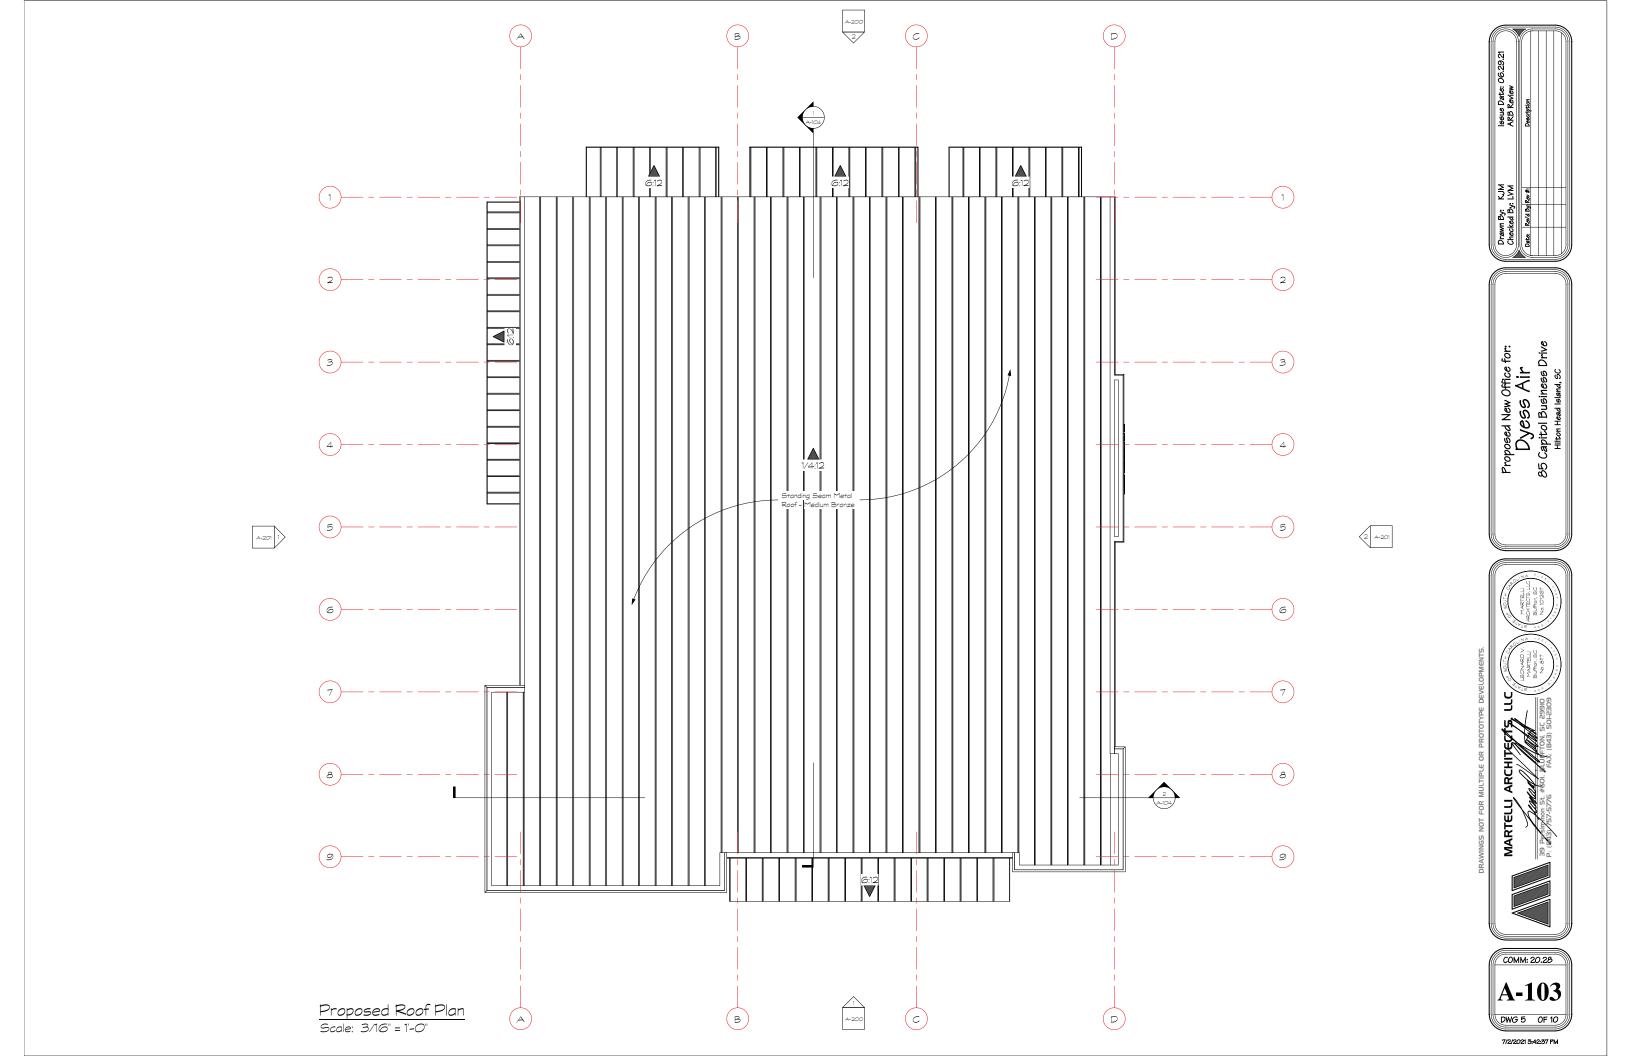

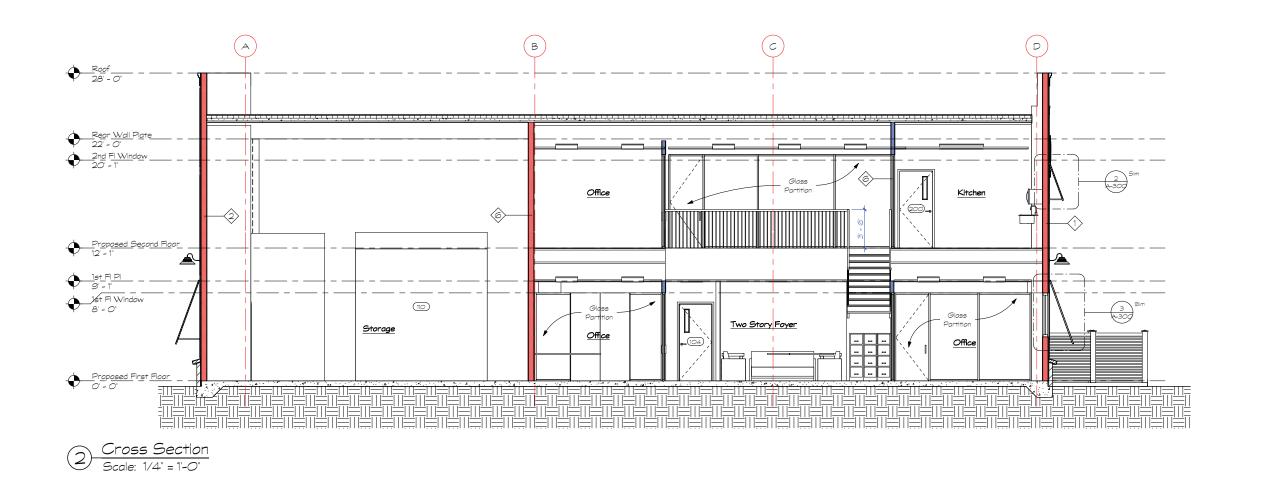

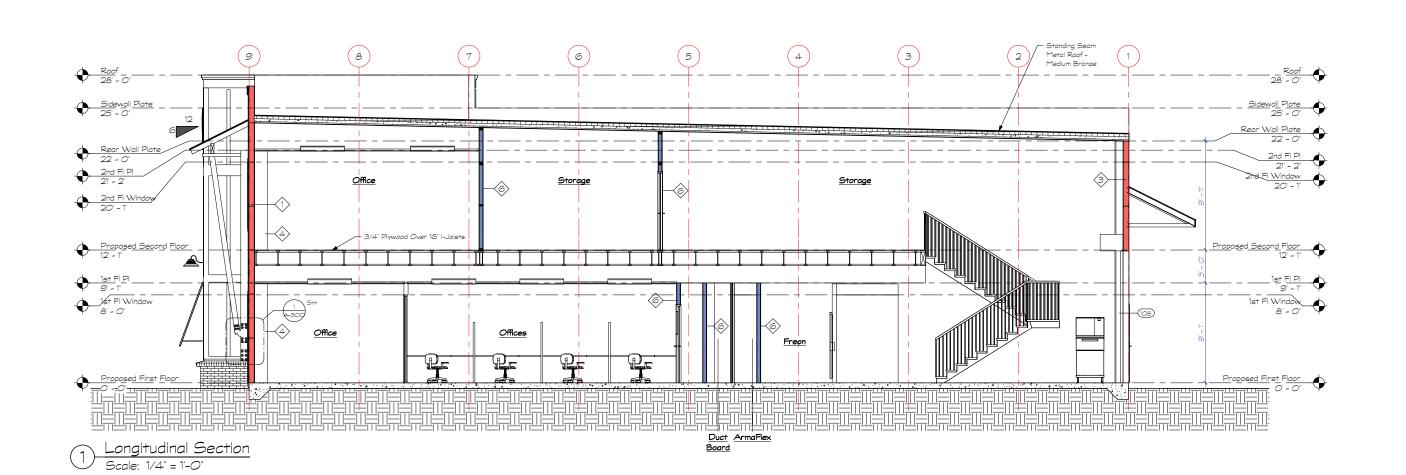

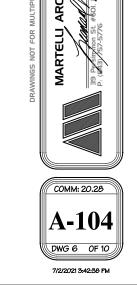


Proposed New Office for: Dyess Air 85 Capitol Business Drive Hilton Head Island, SC

leeue Date: (ARB Review Description


Drawn By: KJM Checked By: LVM Date: Reva By: Rev #:

MARTELLI ARCHITECT'S LLC (SOLING) (CHARTELL) ARCHITECT'S LLC (SOLING) (CHARTELL) ARCHITECT'S (CHARTELL) (CHART

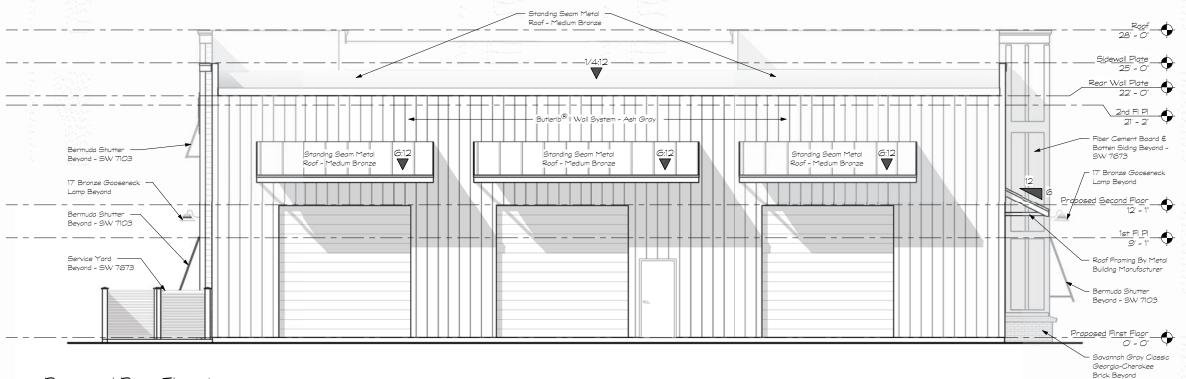


Proposed Rear Elevation

Scale: 1/4" = 1'-0"

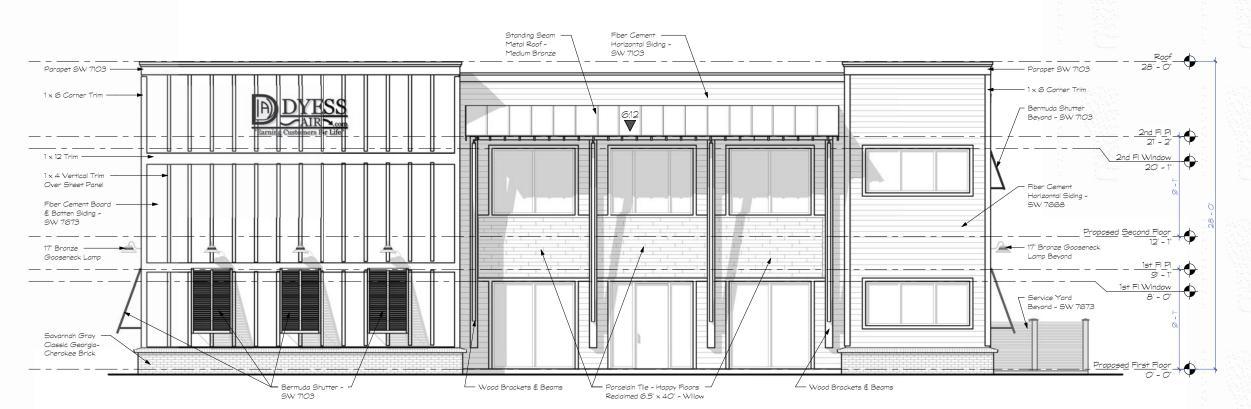

Proposed Front Elevation
Scale: 1/4" = 1-0"

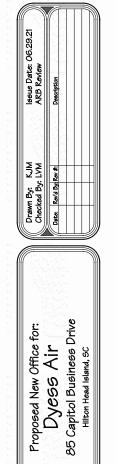




MARTELLI ARCHITECTS, LLC (CONTROLL) STATE STATE

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A-200


DWG 7 OF 10

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Proposed Right Side Elevation

Scale: 1/4" = 1'-0"

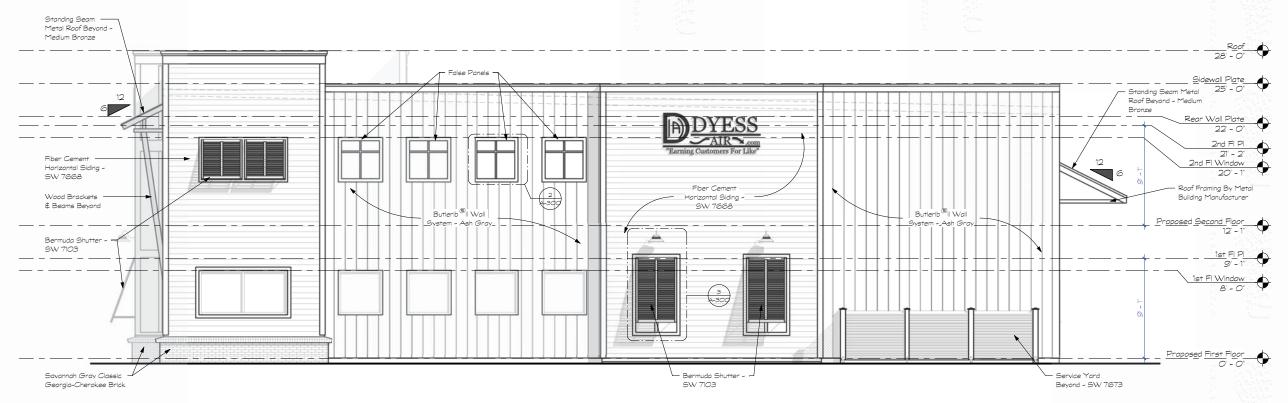

Proposed Left Side Elevation

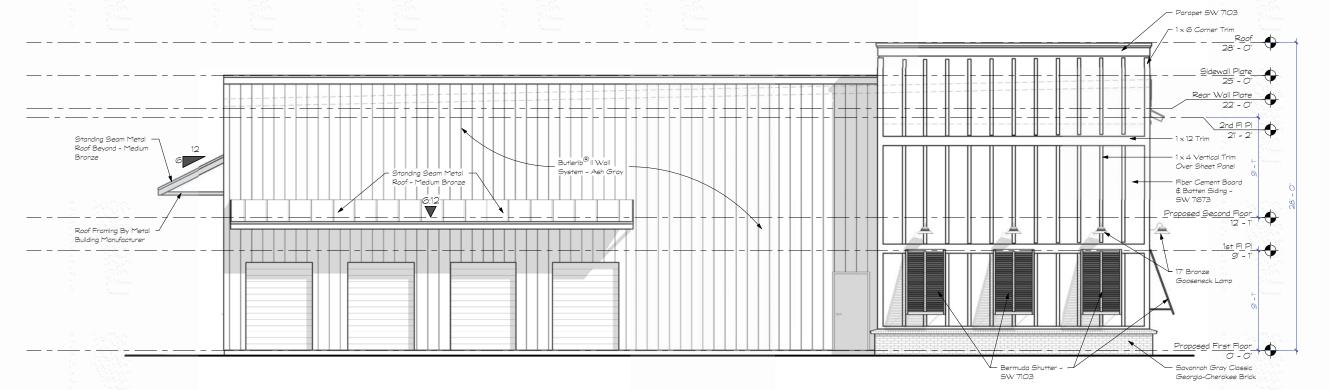Scale: 1/4" = 1'-0"



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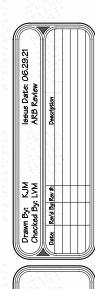
Issue Date: (ARB Review

Drawn By: KJM Checked By: LVM Date: Revi By: Rev #:





Perspective Leg-Of-Mutton Road





Proposed New Office for:
Dyess Air
85 Capitol Business Drive
Hilton Head Island, SC





100			1					Door Schedule	- 17	124				
								200. Scriedule						
	1	1	1	Door					- 51	1	Frame	Trees.		
Mark	Width	Height	Thickness	Material	Finish	Under Cut	Fire Rating	Hardware [Type	Material	Finish	Jamb	Head	Comments
100	3' - 0"	7 - 9 1/2"		Aluminum Storefront	Satin			ADA Lever Style						
101	2' - 8"	7 - 0"	0' - 13/4"	Wood	Satin			ADA Lever Style		Metal Knock Down	Painted			
102	3' - 0"	7 - 0"	0' - 13/4"	Wood	Satin			ADA Lever Style		Metal Knock Down	Painted			
103	3' - 0"	7 - 0"	0' - 13/4"	Wood	Satin	100	1100	ADA Lever Style	NA.	Metal Knock Down	Painted			
104	3' - 0"	7 - 0"	0' - 13/4"	Wood	Satin	1 1 1 1	25,000	ADA Lever Style	1976	Metal Knock Down	Painted	1200		1.0 1.0 1.0
105	3'-0"	7 - 0"	0' - 13/4"	Wood	Satin		900	ADA Lever Style		Metal Knock Down	Painted			
106	6-0	9' - 0"			Satin	1946	2.5.0	ADA Lever Style	1911 (4)		24.5			
107	12' - 0"	12' - 0"	0' - 3"	Metal	Satin	4 141	150	ADA Lever Style	7.15	-	14 141	5-13-		ti Maria
108	12' - 0"	12' - 0"	0' - 3"	Metal	Satin	240	100	ADA Lever Style	3.50		12 97			
109	3'-0"	7 - 0"	0' - 13/4"	Metal	Satin			ADA Lever Style	742	Metal Knock Down	Painted			1 70.5%
110	12' - 0"	12' - 0"	0' - 3"	Metal	Satin			ADA Lever Style	5.0		1 5			
111-	6' - 0"	10' - 0"	72		Satin	54 <u>1</u>		ADA Lever Style	1		2 3			5 A
112	6'-0"	10' - 0"			Satin			ADA Lever Style						
113	6'-0"	10' - 0"			Satin			ADA Lever Style						
14	6' - 0"	10' - 0"			Satin			ADA Lever Style						
115	6'-0"	8' - 0"	0' - 3'	Metal	Satin	n central		ADA Lever Style	2017 220		No. 2017 B	201		No. 1077 No. 11
116	6'-0"	8' - 0"	0' - 3'	Metal	Satin		177	ADA Lever Style	14.44		17.50			
117	6-0	8' - 0"	0' - 3'	Metal	Satin		200	ADA Lever Style	- 175	3 15		100		
118	6'-0"	8' - 0"	0' - 3"	Metal	Satin		100 kg	ADA Lever Style						
119	3'-0"	7 - 0"	0' - 13/4"	Metal	Satin	2,419	250	ADA Lever Style	100	Metal Knock Down	Painted	State of the State		A Thinks
200	3' - 0"	7'-0"	0' - 1 3/4"	Wood	Satin	9 32	1911	ADA Lever Style	1919	Metal Knock Down	Painted	5 55		5 515.55
201	3' - 0"	7 - 0"	0' - 13/4"	Wood	Satin	- 1		ADA Lever Style	31/6	Metal Knock Down	Painted			
202	3' - 0"	7'-0"	0' - 1.3/4"	Wood	Satin		100	ADA Lever Style	125	Metal Knock Down	Painted	5 86		1 1500
203	3'-0"	7 - 0"	0' - 1 3/4"	Wood	Satin	1"	Page 1	ADA Lever Style	- 51	Metal Knock Down	Painted	C Harrier		7.56
204	3' - 0"	7 - 0"	0' - 1'3/4"	Wood	Satin	F 5	inner(ADA Lever Style	- Anna	Metal Knock Down	Painted	· ·		Seminar
205	3' - 0"	7 - 0"	0' - 13/4"	Wood	Satin			ADA Lever Style		Metal Knock Down	Painted			

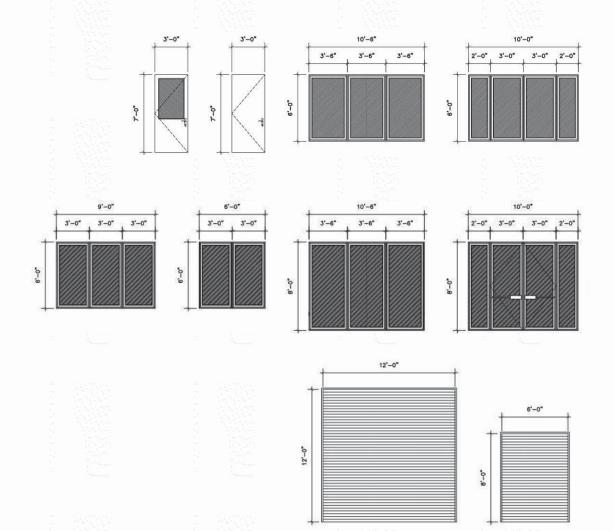

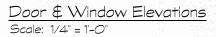


Section @ Service Yard

Scale: 3/4" = 1'-0"


- 4" Concrete Slab w/ 6x6 W1.4 x W1.4 WWF Pitch Slab Away From Building

 6' x 6' Treated Post In Simpson Post Bose PBS66 On 18' Ø 3,000 Psi Concrete Sonotube Footing. 2'-0' Minimum Below Grade - Typical of 8

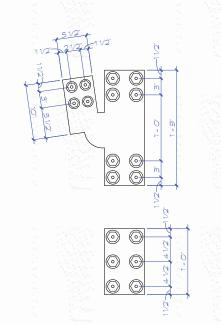


Detail @ Bracket


| Scale: 1 1/2" = 1'-0"

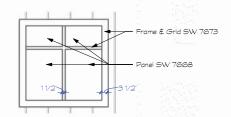

False Panel Detail
Scale: 1/2" = 1'-0"

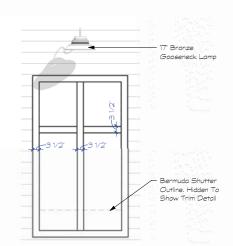

False Panel Detail @
Bermuda Shutter
Scale: 1/2" = 1'-0"

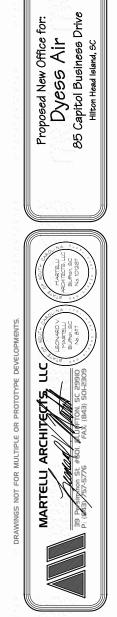


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lssue Date: (ARB Review Description

Proposed Plant	Material	Quantity	Size
	Sable Palm	14	12'-16'
	Live Oak	14	3-4" CAL.
	Dahoon Holly	23	45 GAL
	Silver Saw Palm	46	7 GAL
	Dwarf Podocarpus	26	7 GAL
0	Ligustrum 'Jack Frost'	20	7 GAL
*	Muhley Grass	23	7 GAL
0	African Iris	26	3 GAL
	Empire Zoysia	850 SQFT	
	Existing Live Oaks	16	
•	Existing Pecan	10	
•	Existing Pine	17	
8	Existing Wax Myrtle	12	
•	Existing Gum Tree	5	
9	Existing Red Oak	4	




| DESCRIPTION DATE
| ADD BUFFER PLANTS | 3/27/202 |
| ADJUST BUFFER PLANTS | 7/2/2021

Proposed LANDSCAPE PLANTING FOR:
LOT 10 CAPITAL BUSINESS PARK
TOWN OF HILTON HEAD

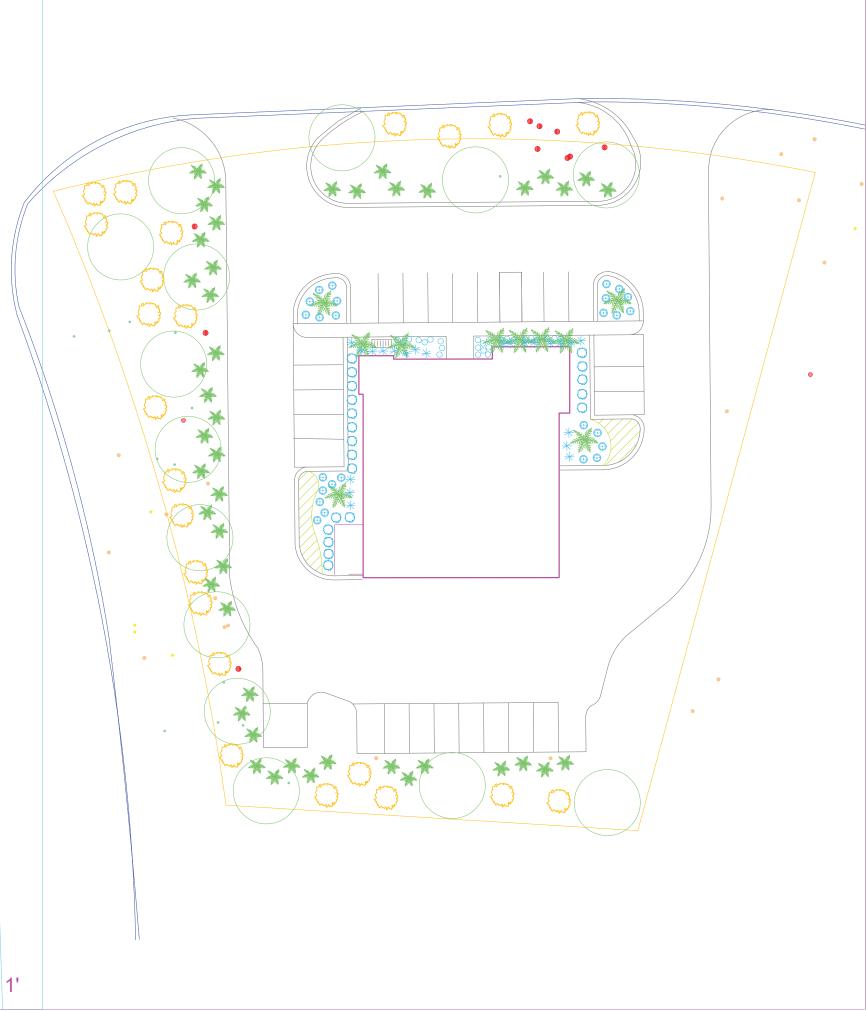TOUW OUTDOOR DESIGN, LLC
6 LONG LEAF COURT
BLUFFICN SOUTH CAROLINA, 29910
DIRECT: (843)-247-6416
MATT.TOUW@GMAIL.COM

DRAWN BY:
MDT
CHECKED BY:
MDT
DATE
1/13/2021
SCALE
1/8"= 1'
JOB NUMBER

SHEET L-1.0
OF X SHEETS

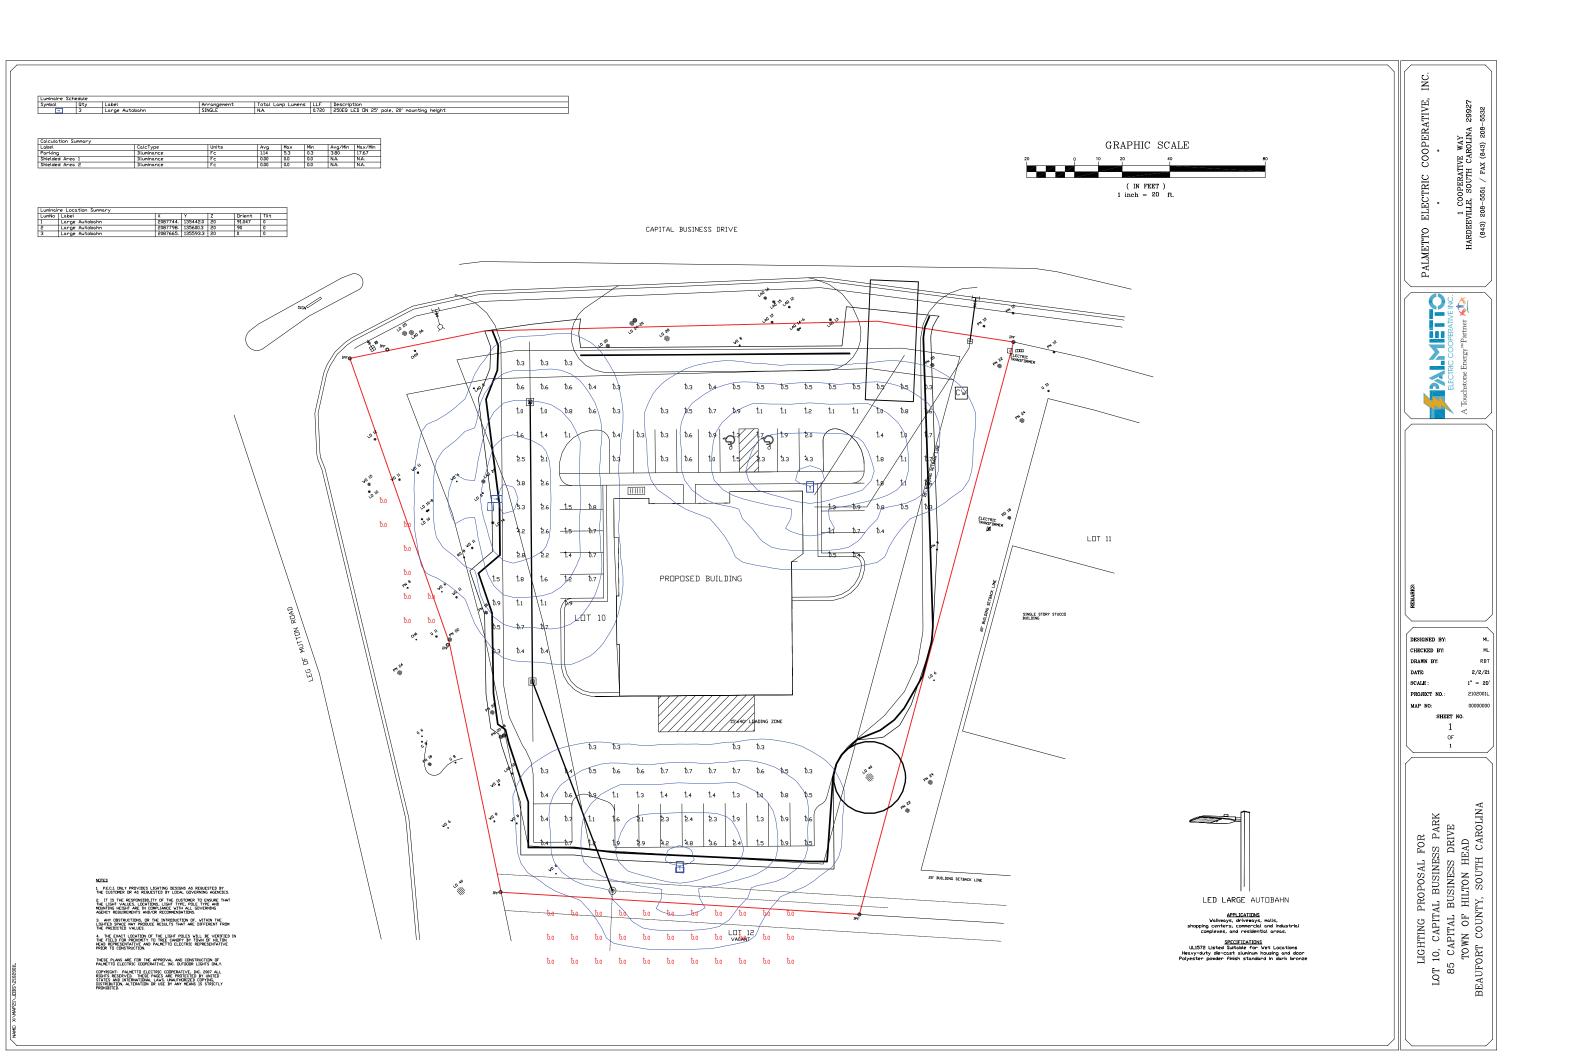

DESIGN TEAM/DRB COMMENT SHEET

The comments below are staff recommendations to the Design Review Board (DRB) and do NOT constitute DRB approval or denial.

PROJECT NAME: 85 Capital Drive				DRB#: DRB-001600-2021
DATE: 06/30/21 07/02/21				
RECOMMENDATION: Approval RECOMMENDED CONDITIONS: (For Staff 1. Provide a detail of the service yard fence) 2. Revise the Landscape Plan to: a. Show existing vegetation and tree b. Plant in a more natural layout. c. Add more groundcovers to the led. Eliminate the lawn in favor of ee. Specify height and caliper of Lit. 3. Provide a tree protection plan. Provide to	review and apperent of the Landscape island vergreen ground vergreen ground ve Oak and Da	dscape ds. ds. dcover hoon H	Plan. s. olly to be a minim	
ARCHITECTURAL DESIGN				
DESIGN GUIDE/LMO CRITERIA	Complies Yes	No	Not Applicable	Comments or Conditions
Utilities and equipment are concealed from view		\boxtimes		Please provide a detail of the service yard fence.
LANDSCAPE DESIGN				
DESIGN GUIDE/LMO CRITERIA	Complies Yes	No	Not Applicable	Comments or Conditions
Treats the Landscape as a major element of the project		\boxtimes		Where possible avoid planting a single row of a species. Instead plant in groups or masses.

				2. The proposed groundcovers in the landscape islands is too scarce.
Location of existing trees and new trees provides street buffers, mitigation for parking lots, and an architectural complement that visually mitigates between parking lots and building(s)		\boxtimes		Avoid planting trees in a row, spacing should be more natural.
The location of existing mature trees is taken into account in placement of shrubs so as not to damage tree roots		\boxtimes		No existing vegetation is shown on the landscape plan. Proposed planting should work with existing vegetation.
Large grassed lawn areas encompassing a major portion of the site are avoided		\boxtimes		Eliminate the lawn in favor of evergreen groundcover.
NATURAL RESOURCE PROTECTIO)N			
DESIGN GUIDE/LMO CRITERIA	Complies Yes	No	Not Applicable	Comments or Conditions
An effort has been made to preserve existing trees and				Provide a tree protection plan. There are several large
under story plants				trees on this site to be preserved in addition to the specimen oak.
1 0				
under story plants Supplemental and replacement trees meet LMO requirements for size, species and number				specimen oak. In the Plant Schedule specify the caliper and height of: 1. Dahoon Holly – min. 10' tall 2" caliper.
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Town of Hilton Head Island

Community Development Department One Town Center Court

Hilton Head Island, SC 29928 Phone: 843-341-4757 Fax: 843-842-8908

www.hiltonheadislandsc.gov

FOR OFFICIAL USE ONLY
Date Received:
Accepted by:
DRB #:
Meeting Date:

Mailing Address: 2948 Sidco Dr. City: Nashville State: TN Zip: 37204 Pelephone: 615-244-8170 Fax: E-mail: q, fisher@mimarch.com Project Name: Wei Food Hall facades Project Address: 95 Matthews Drive Parcel Number [PIN]: R 511 008 000 0192 0000 Poning District: LC Overlay District(s): *Submittal is being made be MJM on behalf of its client, and the tenant and their design team. CORRIDOR REVIEW, MAJOR DESIGN REVIEW BOARD (DRB) SUBMITTAL REQUIREMENTS Digital Submissions may be accepted via e-mail by calling 843-341-4757. Project Category: Concept Approval - Proposed Development Sign Submittal Requirements for All projects: Private Architectural Review Board (ARB) Notice of Action (if applicable): When a project is within the jurisdiction of an ARB, the applicant shall submit such ARB's written notice of action per LMO Section 16-2-103.14.biii.01. Submitting an application to the ARB to meet this requirement is the responsibility of the applicant. X Filing Fee: Concept Approval-Proposed Development \$175, Final Approval - Proposed Development X Alterations/Additions \$100. Signs \$25; cash or check made payable to the Town of Hilton Head Island. Additional Submittal Requirements: Concept Approval - Proposed Development X A survey (1"=30" minimum scale) of property lines, existing topography and the location of trees meeting the tree protection regulations of Sec. 16-6-104.C.2, and if applicable, location of bordering streets, marshes and beaches. X A site analysis study to include specimen trees, access, significant topography, wetlands, buffers, setbacks, views, orientation and other site features that may influence design. X A draft written narrative describing the design intent of the project, its goals and objectives and how it reflects the site analysis results. X Conceptual site plan (to scale) showing proposed location of new structures, parking areas and landscaping.	Applicant/Agent Name: Gretchen Fisher	Company: MJM Architects		
Project Name: Wei Food Hall facades Project Address: 95 Matthews Drive Parcel Number [PIN]: R_511 008 000 0192 0000				
Parcel Number [PIN]: R 511 008 000 0192 0000 Noverlay District(s):	Telephone: 615-244-8170 Fax: E-mail: g.fisher@mjmarch.com			
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1 V I Oncentilal exercise of primary exterior elevations anomina architectural character of the proposed				
X Conceptual sketches of primary exterior elevations showing architectural character of the proposed development, materials, colors, shadow lines and landscaping.				

Last Revised 01/21/15 1

review guidelines of Sec. 16-3-106.F.3. X Final site development plan meeting the X Final site lighting and landscaping plan X Final floor plans and elevation drawing colors with architectural sections and d A color board (11"x17" maximum) con elevations, and indicating the manufact Any additional information requested b	e requirements of Appendix D: D-6.F. s meeting the requirements of Appendix D: D-6.H and D-6.I. s (1/8"=1'-0" minimum scale) showing exterior building materials and etails to adequately describe the project. taining actual color samples of all exterior finishes, keyed to the
additional materials. X A survey (1"=30' minimum scale) of pr	operty lines, existing topography and the location of trees meeting the -104.C.2, and if applicable, location of bordering streets, marshes and
For freestanding signs: Site plan (1"=30' minimum scale) show and property lines Proposed landscaping plan. For wall signs:	ng dimensions, type of lettering, materials and actual color samples. ving location of sign in relation to buildings, parking, existing signs, depicting the proposed location of the sign. ny proposed lighting.
A representative for each agenda item is strongly end. Are there recorded private covenants and/ the proposed request? If yes, a copy of the this application. YES XNO To the best of my knowledge, the informat factual, and complete. I hereby agree to abid	eadline date in order to be reviewed by the DRB per LMO Appendix D: D-23. Fouraged to attend the meeting. For restrictions that are contrary to, conflict with, or prohibit private covenants and/or restrictions must be submitted with tion on this application and all additional documentation is true by all conditions of any approvals granted by the Town of Hiltonions shall apply to the subject property only and are a right of the subject property only are a right of
I further understand that in the event of a St set forth in the Land Management Ordinance Gretchen N Fisher Digitally signed by Gretchen N Fisher Digitally sign	ate of Emergency due to a Disaster, the review and approval times may be suspended. 06-29-21
SIGNATURE	

Last Revised 01/21/15 2



DATE: 06/29/21

TO: Hilton Head Island Community Development Center - Design Review Board

PROJECT: Wei Food Hall Facades

PROJECT ADDRESS: 95 Matthews Dr. - Port Royal Plaza

MJM PROJECT NUMBER: 21151

To Whom It May Concern,

The intent of this project is to modify the existing facades of the left vacant tenant space at 95 Matthews Dr. Currently there is a Planet Fitness occupying the central tenant space and a recently approved AutoZone occupying the right tenant space. This application looks to develop the north & east facing façades for a new Wei food hall concept that is to include 4 restaurants; Jinya Sushi, Kung Fu Tea, Angry Crab Shack & Paris Baguette.

The proposed modifications to the North facing façade are minimal in nature, a previous DRB submittal saw the approval of a small raised signage parapet that mirrors what has been provided for the AutoZone, as well as a central storefront door with a section of storefront window on either side. This submittal proposes to remove the previously approved storefront section to the left of the entrance door and replacing the section of storefront to the right of the entry with a section of Nana-wall.

The proposed modifications to the East facing façade are substantially different from what was approved previously and consists of a large, shared, glass fenced, patio running the length of the façade, with an awning structure supporting permanent louvers, lights, fans & heaters, and requiring the demolition of the existing gazebo structure on the site. Additionally a large amount of glazing is proposed along the façade to blur the line between indoor and outdoor dining spaces. Jinya Sushi would see its main entrance along the North façade, however the remaining spaces would be entered off of the East façade.

Since the last presentation of this revised design in April, the tenant and their design team have worked to respond to the previous comments related to detailing of the patio structure and the specific fixtures and finishes intended for the project.

All finishes are of a natural color palette and are intended to blend with the finishes currently in use on the remainder of the shopping center:

Paint Colors:

Glidden: Grey Mountain: 40YY 25/074 Glidden: Designer Grey: 50YY 63/041

Storefront & Metal Elements:

Bronze Anodized



Since our last submittal in April, the tenant and their design team are proposing a new wood grain aluminum panel cladding for both the front and side elevations.

Material Specifications and brochures have been included with this submittal for further visual clarity.

If you have any questions, please do not hesitate to contact me at 615-244-8170 or by email at g.fisher@mjmarch.com

Sincerely:

MJM Architects

Gretchen Fisher


Senior Project Manager



AN UNRIVALED REALISM

ALL TEXTURES ARE PRODUCED FROM PHOTOS OF ORIGINAL MATERIALS.

CHOOSE FROM A VAST ARRAY OF TEXTURES AND COLORS.
VISIT OUR WEBSITE AT WWW.DIZAL.COM.

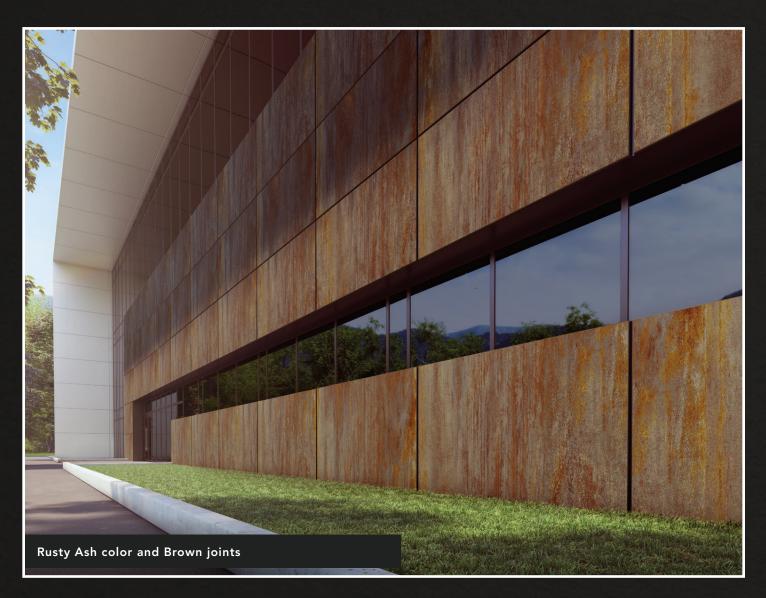

JOINTS AVAILABLE IN 3 TEXTURED COLORS.

« Pantone » colors conditionally available on demand.



Brown







Dizal offers the best warranty on the market, not only on the product but also on the discoloration, thanks to added layer of the \mathbb{Z} -CLEAR.


Please refer to our complete Warranty documentation on our website at www.dizal.com.





ALUMINUM ARCHITECTURAL PANELS




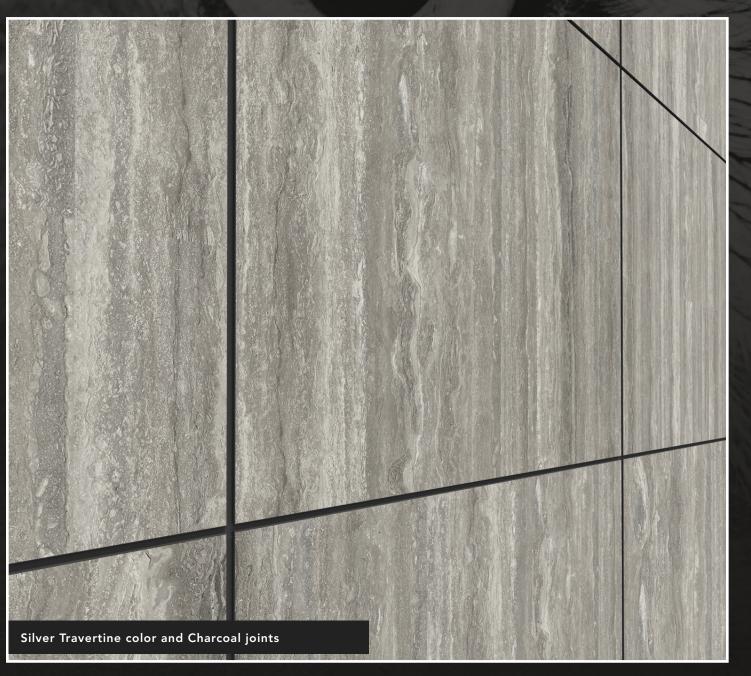

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DΙΖΛĽ



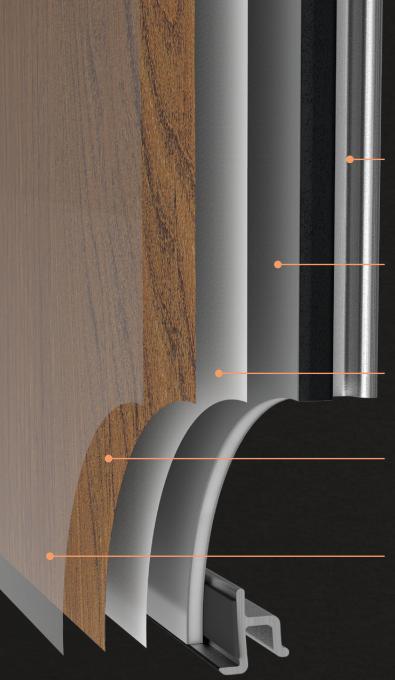

PANELS, PARTS AND ACCESSORIES

FRAME

Rigid aluminum extrusion, painted to match joint color, adhered to panel with industrial grade tape with 75 lb/in² tensile strength.

ACP

(Aluminum Composite Panel)

Panel 4 mm thick, without fold or apparent fasteners. Class A rated Fire Resistant Core.

PRIMER COAT

Specially formulated primer coat assures optimal adhesion between aluminum and ink.

HD PRINTING

High definition digital inkjet print reproducing a wide range of textures and outstanding color variations.

Z-CLEAR

A protective clear coat is applied to provide long term protection against fading.

SYSTEM

Dizal's system is made up of panels and rails allowing for a fast and easy installation.

Extrusions are prepainted in order to reproduce different joint colors.

These are installed to the wall first, then panels can be inserted into them.

The complete system includes 4 items:

PANELS

- The panel, with a depth of 0.75" (1.9 cm), is available at the specified dimension up to a maximum size of 4' x 8' (121.92 cm x 243.84 cm). *
- Spacing between panels is predetermined at 0.375" (0.95 cm).
- Panels are shipped with a protective film.
- * Other dimensions conditionally available.



STARTER STRIP _

 Aluminum extrusion with clippable screw cover strip, painted to match joint color.

HORIZONTAL AND VERTICAL DOUBLE FASTENING STRIP

 Two piece aluminum extrusion with screw cover strip for a horizontal and vertical installation of panels.


FINISHING STRIP -


 Aluminum extrusion with clippable screw cover strip, painted to match joint color, allows for on site cutting and installation of finishing panels.

TESTS & CERTIFICATIONS*

- . ASTM E84 Fire resistance
- . ASTM E283 Static air infiltration
- . ASTM E330 Structural performance
- . ASTM E331 Static water contacting AWB
- . ASTM G155 UV resistance
- . ASTM D6578 Graffiti resistance

- . ASTM D3359 B Adhesion testing
- . ASTM D6665 Boiling water testing
- . ASTM D2794 Impact resistance
- . ASTM E413 Sound insulation
- . AAMA 501.1 Dynamic water infiltration test
- . LEED V4

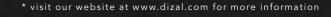

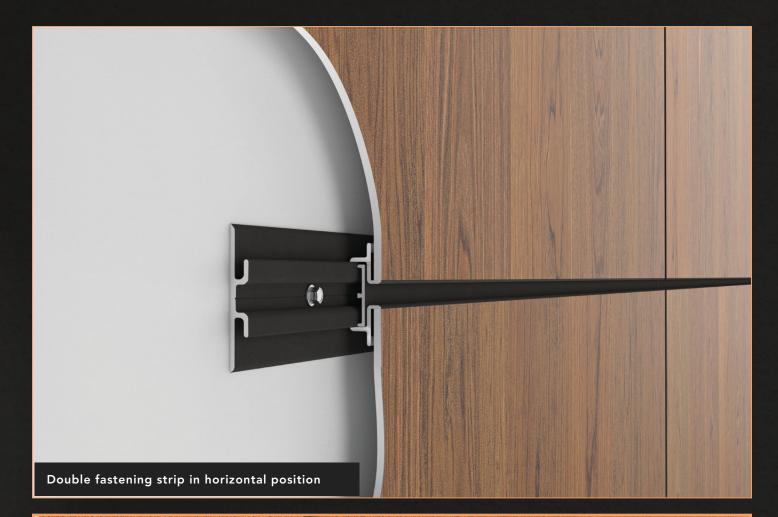





(800) 967-0991 info@pergolaroof.com pergolaroof.com 85 Broad street, Floor 18 New York, NY 10004





Ultimate Outdoor Solutions

ABOUT PERGOLA ROOF

Pergola Roof offers the best solutions to utilize your outdoor space all year round.

Our wide range of innovative products can be tailored to your specific needs to create an aesthetically pleasing landscape.

We lead by example through quality, design, and functionality.

"It's definitely unique. I've never seen anything like it before"

- Andy Spiler, Commack Fire Department


PERGOLA 1



LOUVER 15



SCREEN 35

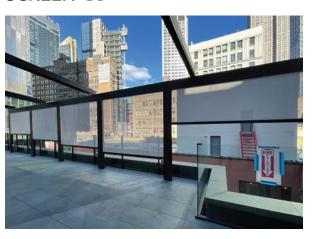

SUNROOM 41



GUILLOTINE 47



PERGOLA Retractable Awning | Motorized and Manual

We offer an aesthetic solution to outdoor problems with our retractable pergola systems. Our Pergolas allow you to have the freedom to create whatever environment you want when outside. Our systems come with every amenity you can think of so you don't have to. We use an aluminum structure that can withstand many different weather conditions, and doubles as a gutter and drainage pipe. We bring together the top materials and technology so we can help you make use of your outdoor space all year round. All of our pergolas are water-resistant, fire retardant, waterproof, remote-controlled and have custom finishes. They also come with optional dimmable LED lights built-in.







Resists bad weather



Fire retardant



Complete blackout



Watertight



Dimmable LED lights







Custom

Applications

Patio, Deck, Porch, Balcony, Terrace, Pool, Sukkah, Restaurant, Hotel, Rooftop

Available in freestanding or wall-mounted versions.













Design Specs

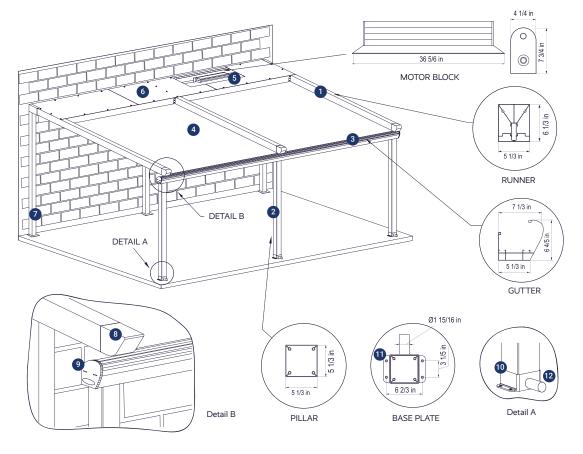

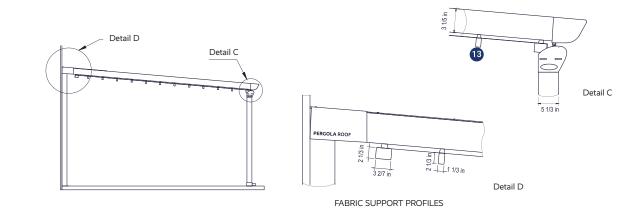


- 1. Unibody aluminum press casting runner beam
- 2. Aluminum column (3 mm thick)
- Double-skinned aluminum stream gutter
- 4. Fire retardant and waterproof retractable ceiling fabric with 3 layered complete blackout by Sergi Ferrari
- The opening / closing movement of the roof cover is motorized with remote control by Somfy
- 6. Motor and fabric cover panel
- Rear legs may be eliminated when directly installed to the wall
- B. Die cast aluminum beam end cap
- Plastic injected stream gutter side cap
- 10. Aluminum die casting attachment flange
- 11. M18 hex nut
- 12. Water dissent
- 13. Rail profile with integrated LED lighting








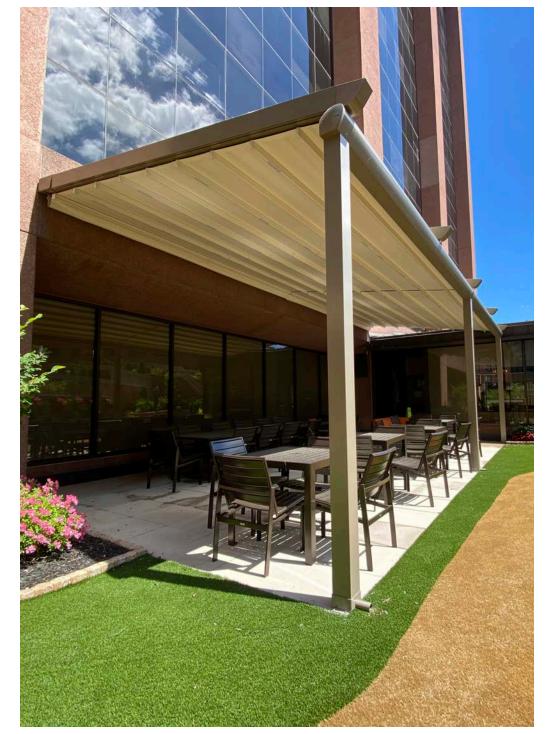





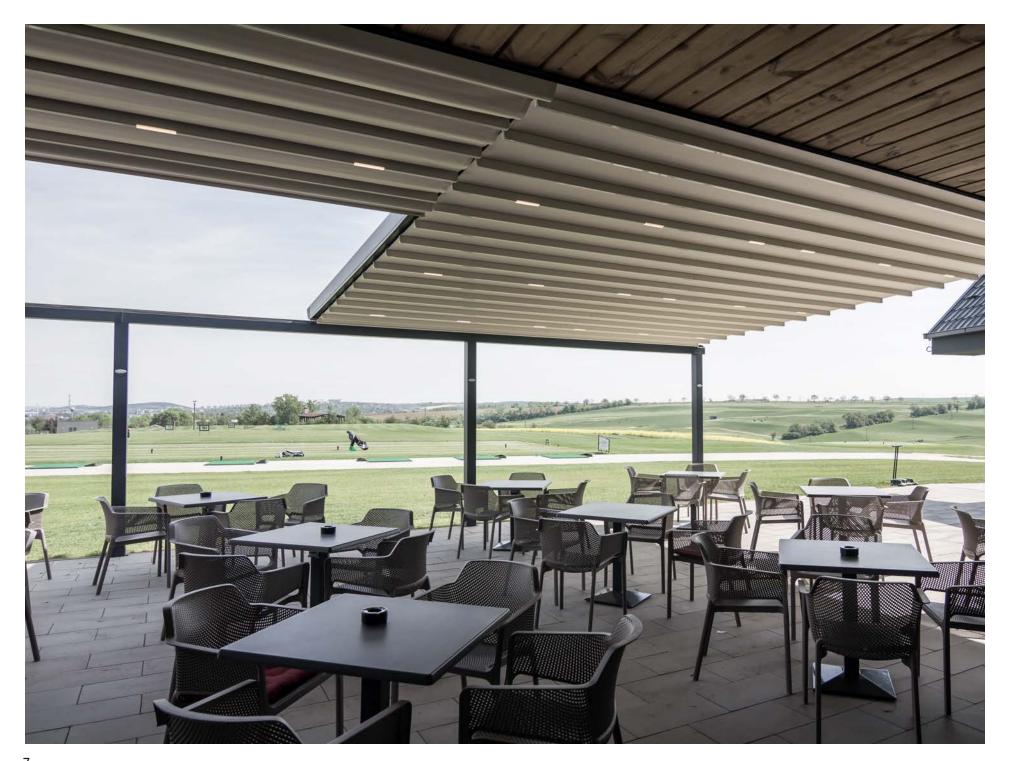







Materials

FABRIC / COMPOSITE


Soltis Flexlight 602 by Serge Ferrari is a highly durable, dimensionally stable material with a 5 year warranty.



	Flexlight 602			
	Technical properties			Standards
Yarn	1100 dtex PES HT	1100 dtex	PES HT	
Finish	Varnish both sides	Varnish bo	oth sides	
Weight	19.1 oz/yd2	22 oz/yd2		EN ISO 2286-2
Width	105.1	62 in: 109 98.4 & 109	.3 yds 5.1 in: 54.6/328 yds	
Standard length	54.6 yds/328 yds			
Tensile strength (warp/weft)	250/250 daN/5 cm			EN ISO 1421
Tear strength (warp/weft)	25/25 daN/5 cm			DIN 53.363
Adhesion	9/9 daN/5 cm			EN ISO 2411
Flame retardancy	Method 2/NFPA 701 • CSFM T19 • ASTM E 92-507 • Euroclass EN ISO 13501-1 • CAN			
Extreme working temperatures	-31°F / +158°F			In static position, internal test
White	Gray	Cream		

STRUCTURE

	Technical properties	Standards		
Metal	11 gauge aluminum			
Finish	PE58 Qualicoat approved thermosetting powder coatings			
Weight	4 psf			
Width	16' span max. (no limit on number of sections)			
Projection	32' max. (single runner beam)			
Wind resistance	130 mph (vinyl canopy retracted closed)			
Tensile strength Rm (N/mm2)	245 (min.)	TS EN ISO 6892-1		
Yield point Rp 0,2 (N/mm2)	200 (min.)	TS EN ISO 6892-1		
Elongation A (%)	10 (min.)	TS EN ISO 6892-1		

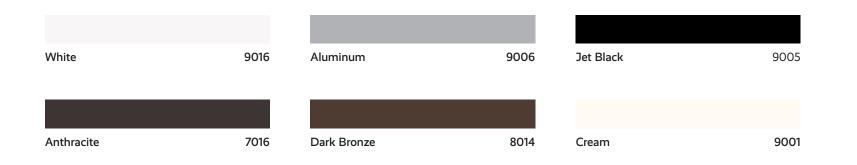




MOTOR

Altus® is suitable for pre- and postconstruction opportunities and can be controlled with any Radio Technology Somfy accessory.

LIGHTS

Dimenions

SCHILDR pergolas come with optional built-in LED spot or tube lighting

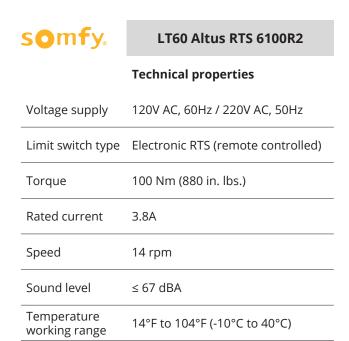




TELIS 4 and 16 RTS hand-held remote extends control up to 4 and 16 different channels within 65 feet of range.



DECOFLEX WIREFREE™ RTS is battery-powered and a completely wireless wall switch.

SAMSUNG	Samsung Tube LED		
	Technical properties		
Operating voltage	24V		
Color temperature	3,000K		
LED type	700 Lumen		
Protection class	IP 68		
Body color	Off-white		
Life	50,000 Hrs		
Operating temperature	-30°C to 85°C		

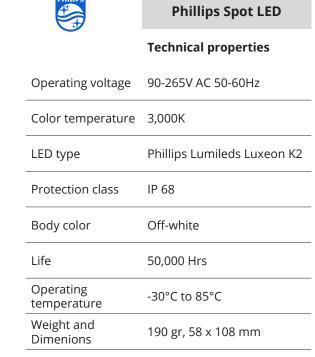



180 x 35 mm

Tube LED embeded into aluminum rail profile



Spot LED on aluminum rail profile

LOUVER Louvered Roof | Motorized

High-end motorized louvered roof, made of an aluminum structure with insulated aluminum panels. Our louvered structure offers outstanding comfort in the cold and hot seasons. This structure is built to handle whatever mother nature chooses to throw at it. Can handle a great deal of snow and wind load.







Resists bad weather



Fire retardant

to last



Complete



blackout



Watertight



Dimmable LED lights



Remote controlled




finishes







Design Specs

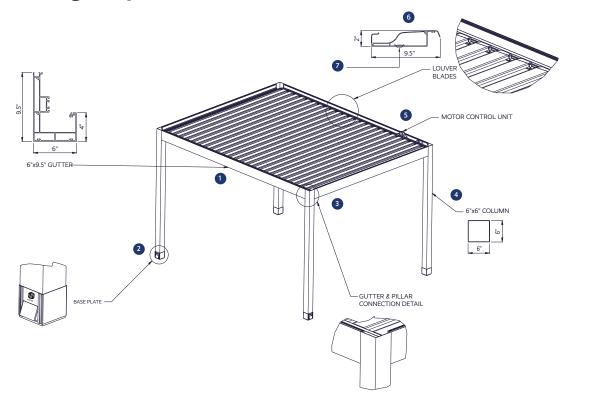

- 1. Built-in gutter aluminum side profiles
- 2. Unibody aluminum press casting base plate
- Gutter drainage through column
- . Aluminum column (3 mm thick)
- The pivoting open / close movement of the louver blades is motorized with remote control
- 6. Louver blades pivot up to 110°, they can be filled polyurethane foam for insulation
- 7. Optional integrated LED lights









Free standing - closed

Free standing - open

Wall mounted - closed

Wall mounted - open


























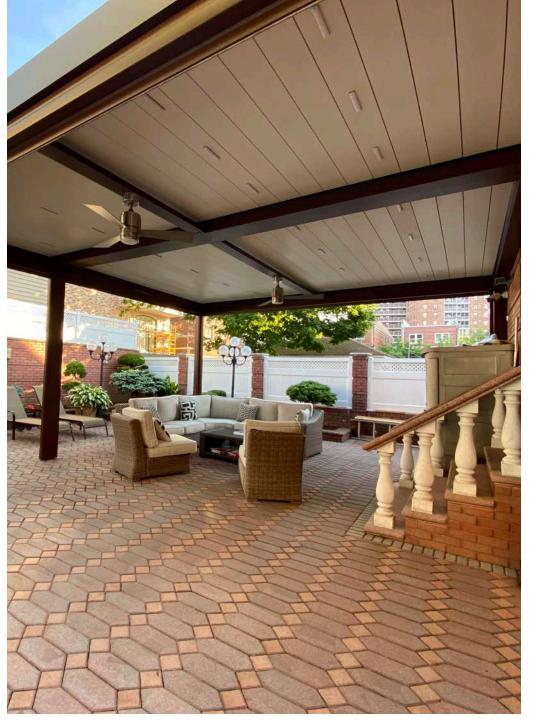





















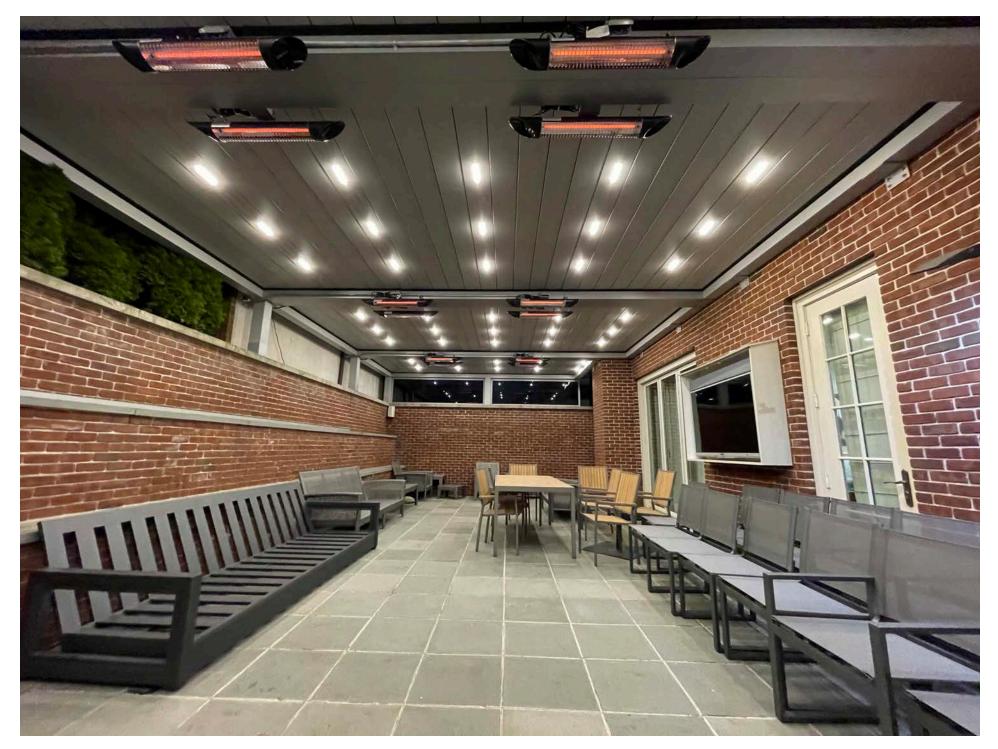

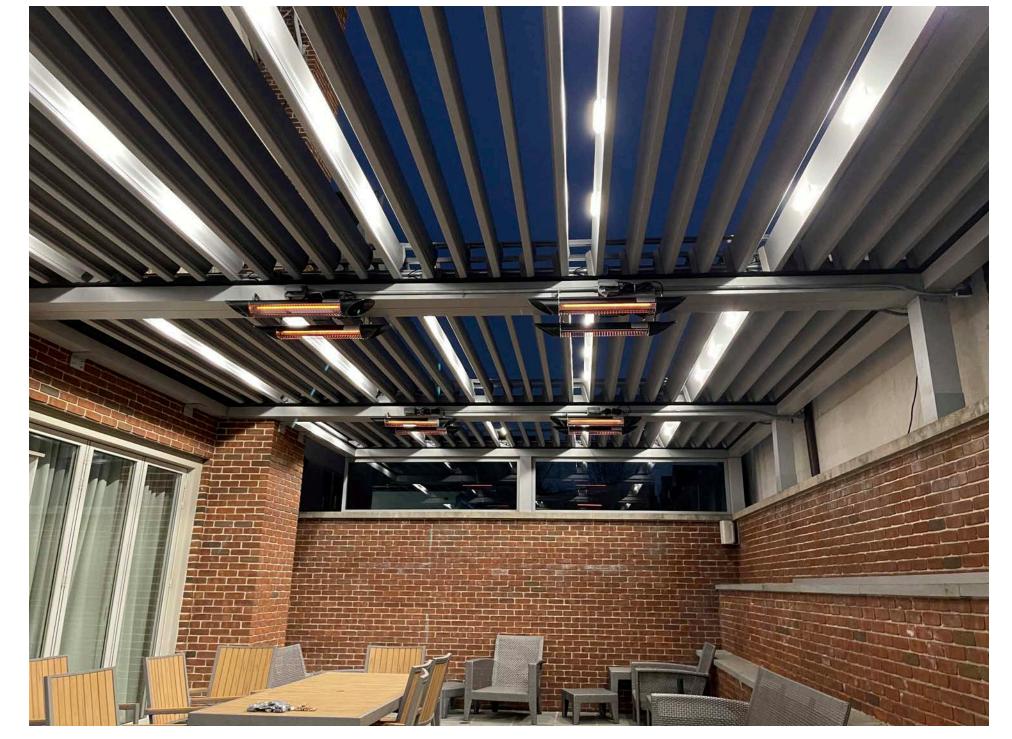

SCREEN Roll-up Shading | Motorized

We work to making your outdoor the best it can be. Without shades, you can create outdoor blinds that provide privacy and protection against sun, heat, wind, rain, and insects. This add on aesthetically complements Pergola Roof systems by fully enclosing your patio, balcony or terrace and retracts with remote control. It withstands strong winds, provides micro air circulation and water resistance. It is a wonderful addition to any of Pergola Roof outdoor systems.







Resists bad weather



retardant



translucent



repellent





Dimmable LED lights



circulation




Remote controlled



Custom finishes



Built to last

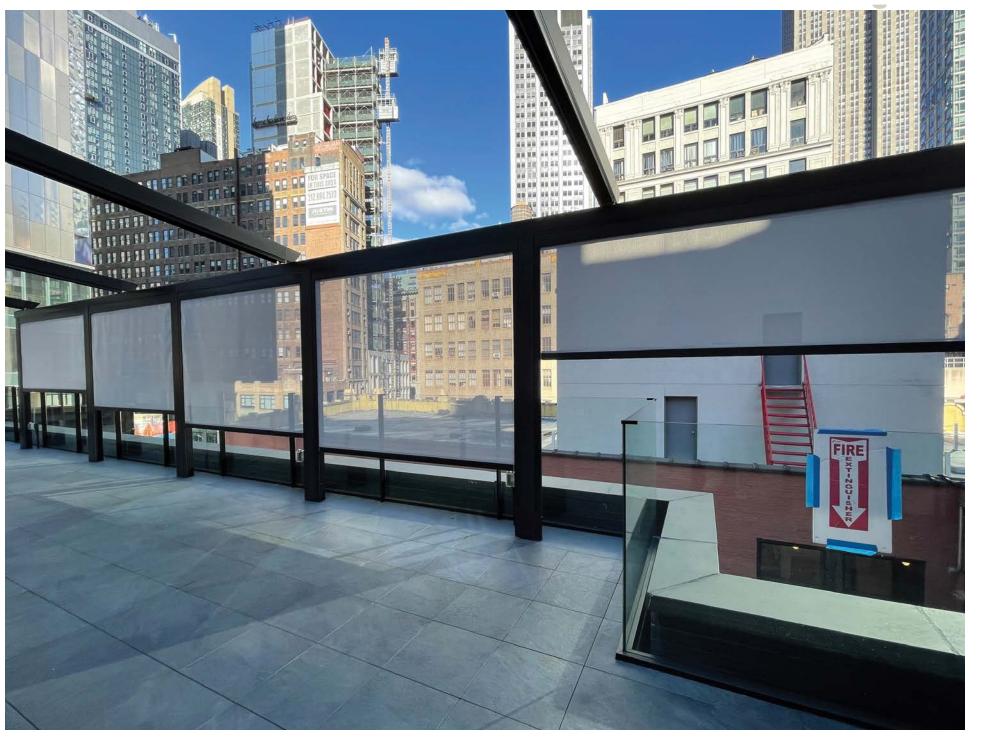

Screen





Screen 38

Materials

FABRIC / COMPOSITE

Thanks to Précontraint technology by Serge Ferrari, both Horizon 86 and Perform 92 have outstanding dimensional stability. They are environmentally friendly and recyclable.



Soltis Horizon 86 is a 14% open mesh composite that offers the best outward visibility with a level of up to 28% natural light transmission.

		So	ltis Horizon 86				
		Technical properties				Standard	S
Weight		11.2 oz/yd2			EN ISO 228	66-2	
Thickness		0.45 mm / 450 microns					
Width		69.7 in - 105.1 in EN ISO 2286-2			66-2		
Standard format length		69.7" width: 54.68 yds 105.1" width: 43.74 yds					
Tensile strength (warp/v	veft)	230/160 daN/ 5 cm EN ISO 1421			1		
Tear strength (warp/wef	ft)	45/20 daN DIN 53.363			1		
Flame retardancy		CSFM T19 • Method 1/NFPA 701 • Class A/ASTM E84					
Warranty		5 years					
White	86-2044	Champagne	86-2175	Boulder	86-2171	Anthracite	86-2047
Black	86-2053	Cocoa	86-2148	Beaten metal	86-2045	Bronze	86-2043

Soltis Perform 92 is a 4% open mesh and an advanced thermal shield. It blocks up to 97% of heat in external window applications.

This micro-perforated screen offers the best thermal performance while maintaining outward visibility.

Soltis Proof W96 protects against UV and bad weather, while preserving the level of natural light transmitted. This translucent, waterproof fabric is ideal for pergolas and shade canopies.

				Solti	s Horizon 9	92			
			Technical properties						
Weight			12.4 o	z/yd2					
Thickness			0.45 m	0.45 mm / 450 microns					
Width			69.7 in	- 105.1 ir	1				
Standard form	at length			vidth: 54.6 width: 43					
Tensile strengt	th (warp/w	eft)	310/210 daN/ 5 cm						
Tear strength ((warp/weft)	45/20	daN					
Flame retarda	ncy			d 1/ NFPA A/ ASTM	701 • CSFM E84	T19			
Warranty			5 years	5					
Vhite	92-2044	Champag	ne	92-2175	Boulder		92-2171		
Anthracite	92-2047	Black		92-2053	Cocoa		92-2148		
Beaten metal	92-2045	Bronze		92-2043					

		Soltis Proof W96					
			Technical properties				
Weight		620 g/m2 — 18.3 oz/sqyd					
Thickness		0.56	5 mm / 560 mio	rons			
Width		267	cm — 105.1 ir	1.			
Standard format length		35 lm — 38.27 yds					
Tensile strength (warp/weft)		220/220 daN/5 cm					
Tear strength (warp/weft)		25/20 daN					
Flame retardancy		M2					
Warranty		5 years					
The state of the s							
White	W96-810)2	Off white		W96-110		
Cloud	W96-21	71	Anthracite		W96-204		

Screen 40

OUR PRODUCTS


APPLICATIONS

WHY NANAWALL

CONTACT US

SL73

NanaWall

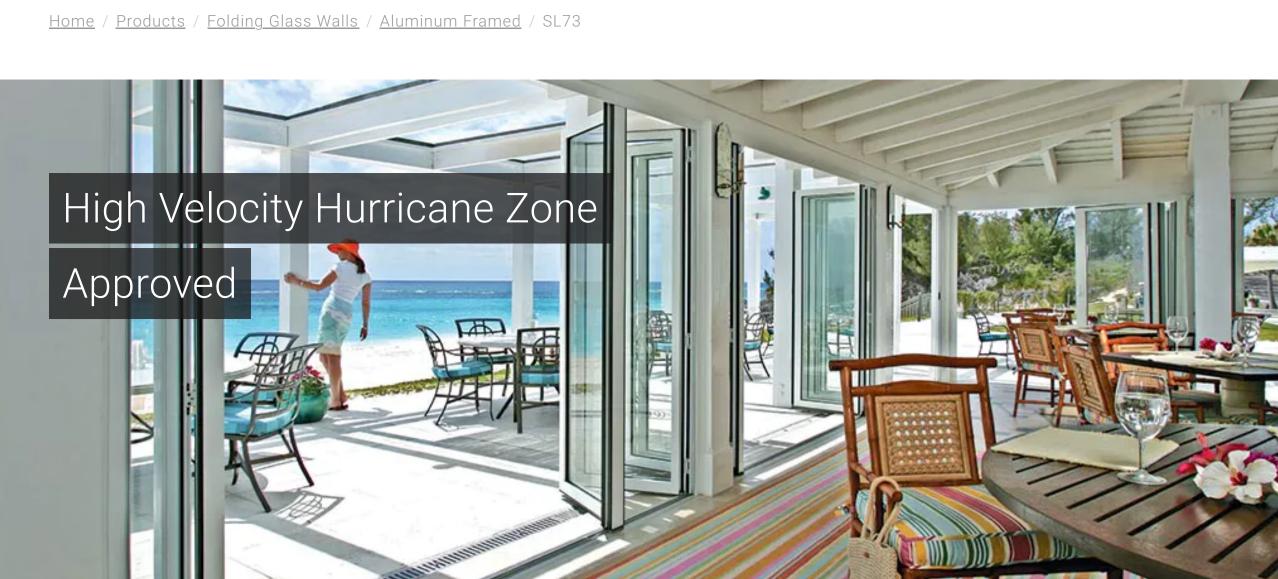

FEATURES PERFORMANCE OPTIONS ACCESSORIES RESOURCES

Features

Our bughest folding system, designed to face hurricanes and completely impact-rated

The NanaWall SL73 is perfect for securing common areas and in areas

exposed to heavy rain. Both forced entry

rated and passing a more difficult water

DYNAMIC WATER PERFORMANCE

FORCED ENTRY RATED AND

test, you can rely on the NanaWall SL73 when you need it most

The NanaWall SL73 has achieved design pressure performance making it acceptable for up to mid-rise level exposures. For specific sizes and capabilities, please refer to the performance chart. Learn more

COMPLETELY IMPACT RATED

REINFORCED FOR MID RISES



Areas that require protection from water penetration or are located in mid-rise buildings, the Nanawall SL73 is designed to perform.

designed for windows and doors to be used in hurricane zones.

The NanaWall SL73 has passed the most rigorous testing

MIAMI-DADE APPROVED





system, allowing both inward and outward opening systems to qualify, while also providing protection from water penetration. Macuil Charleston

1:20 PM ET

Many approved systems are limited to outward opening and are not approved for areas

that need protection from water. The NanaWall SL73 offers a complete impact rated



Outswing - FL20107 **MIAMI-DADE COUNTY APPROVAL:**

FLORIDA PRODUCT APPROVAL:

Inswing - FL20108

Inswing - NOA 17-0713.18*

Outswing - NOA 17-0713.17*


*Expiration date of 8/11/2020

If you plan on needing daily access, be sure **b** include a swing door. Take a look at your configuration options and choose

INCLUDE A SWING DOOR, OR TWO

one that works best for your design. Learn more



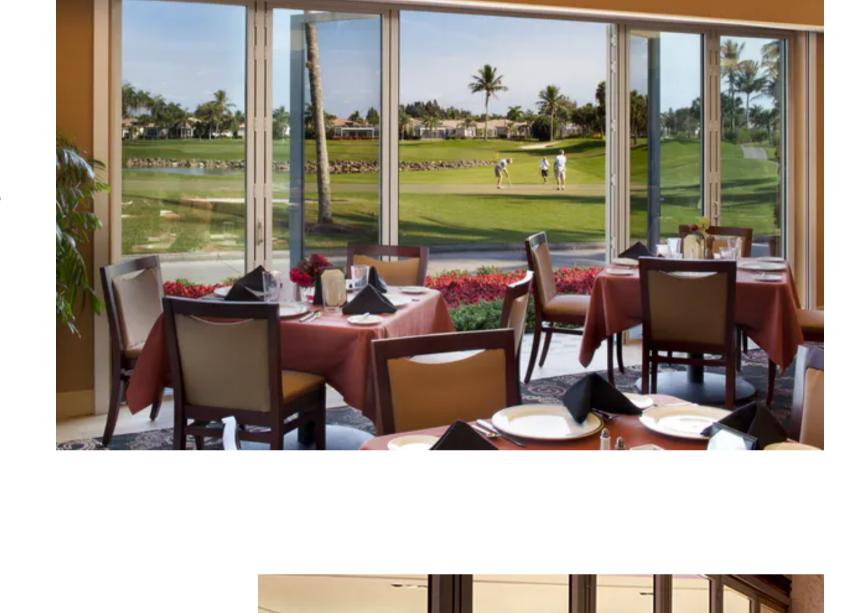

SOUND CONTROL

quiet.

Technology

The NanaWall SL73 featuring a 70mm panel depth and using

special laminated glass options, provides one of our best choices

for sound control. While delivering peace of mind as an impact

rated system, you get an additional benefit of both peace and






INSULATED ALUMINUM CORE

and excellent sound control.

driven rain.

The NanaWall SL73 features a door panel depth of 70mm utilizing

an advanced thermal strut that provides comfort for all climates

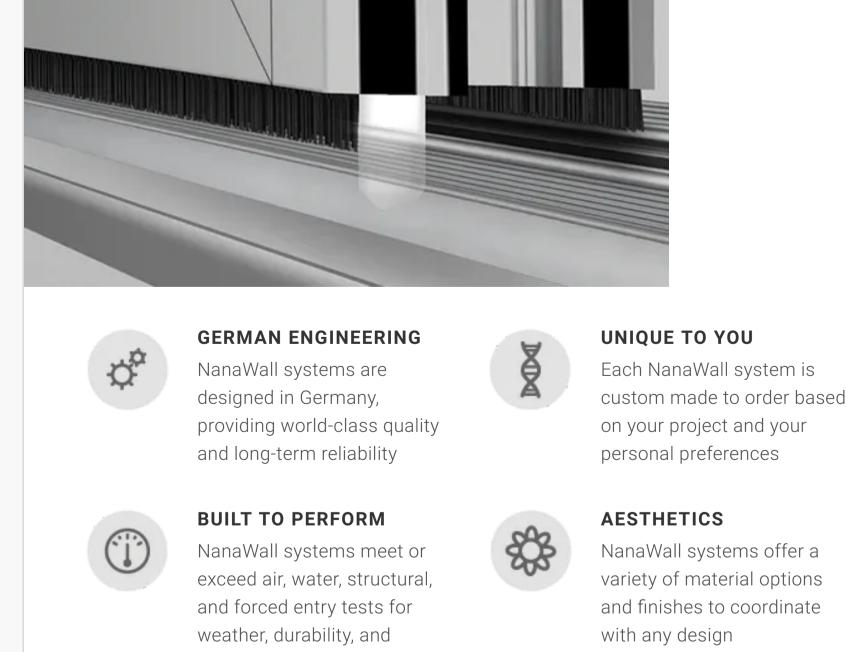

Learn more

FLOOR TRACK CHOICES

The NanaWall SL73 features two sill

low-profile saddle sill. Both sills help

provide security protection from wind

options, a high-performance sill, and the

WIDE OPENINGS NanaWall folding systems



Download our brochures or place an order for printed ones.

security

DOWNLOAD BROCHURES

can replace walls or doors up

to 39' wide, select systems

can go even wider if desired

EASE OF OPERATION

NanaWall systems offer

move smoothly with little

effort

single-handed operation and



GALLERY

WHY NANAWALL

Homeowners

Contractors & Builders

Back to top

BLOG

RESOURCES **BROCHURES** SUPPORT

SL60

HSW75

OUR PRODUCTS

Folding Glass Walls

Sliding Glass Walls

HSW60 | HSW66

Frameless Glass Walls

Business Owners

ABOUT US FAQ Rep Finder

APPLICATIONS Architects & Designers Residential

Commercial Interior

Commercial Exterior

PRESS & MEDIA

Shows & Events

Continuing Education

Awards

SL45 | SL70 | SL73 NW Aluminum 640 | NW Acoustical 645 | WD65 | WD66 WA67 | NW Wood 540

ClimaCLEAR

Houzz Blog

Privacy

FSW75

NW Aluminum 840

Minimal Sliding Glass Walls cero

PrivaSEE

NANA WALL SYSTEMS, INC. 100 Meadowcreek Drive #250, Corte Madera, CA 94925

Phone <u>866.208.5745</u> | <u>415.707.3209</u>

Fax 415.383.0312 info@nanawall.com | Contact Us

Facebook Twitter

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CSW75

Pinterest Sitemap | Solarlux | Legal

OUR PRODUCTS

APPLICATIONS

WHY NANAWALL

CONTACT US

SL73 Performance

NanaWall

Home / Products / Folding Glass Walls / Aluminum Framed / SL73 / SL73 Performance



 \Box \Box **FEATURES**

PERFORMANCE

OPTIONS

ACCESSORIES

RESOURCES

there are many options to choose from. When deciding on a product that best for your project, performance when


MATTERS MOST

PERFORMANCE WHEN CLOSED

Large openings are easy to design and

closed needs to be considered.



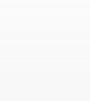


NanaWall products are NFRC rated and certified for true energy efficiency in all

ALL CLIMATE

PERFORMANCE


climates.

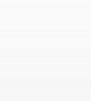

standards for air, water, structural, and forced entry.

the latest AAMA testing

LOW PROFILE SILL

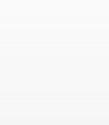

DESIGN WINDLOAD

Back to top

rating systems and

categories.

potentially several credit

Air, Water, Structural, Thermal, Forced Entry & Acoustical Results

INWARD OPENING UNITS Approved with Impact Glass in FL High

Higher Weather Performance (Raised) Sill - SL73

FLORIDA PRODUCT APPROVAL: Inswing - FL20108, Outswing - FL20107

HIGH PERFORMANCE SILL

Air Infiltration ①

Protocol TAS 202 and ASTM E-283, cfm/ft²

TYPE OF TEST

0.30 A1 to A3 2

No uncontrolled water entry

@ 9 psf

(440 Pa)

Velocity Hurricane Zone (HVHZ) FL

Product Approval #FL20107.1

@ 1.57 psf (75 Pa): 0.08 to

A1 to A3 ②

OUTWARD OPENING UNITS

Approved with Impact Glass in FL High

Velocity Hurricane Zone (HVHZ) FL

Product Approval #FL20107.2

@ 1.57 psf (75 Pa): 0.02 to

0.14

@ **6.24** psf (300 Pa): 0.20 to 0.30

0.07 to 0.30

No uncontrolled water entry

@ 9 psf

(440 Pa)

@ **6.24** psf (300 Pa):

Static Water Penetration ① Protocol TAS 202 and ASTM E-547 and

E-331

Dynamic Water Penetration

AMAA 520 & ASTM E-2268

Structural Load Deflection 1

TAS 202 & ASTM E-330: pass

Note that the structural test pressures

were 50% higher than the design

pressures.

Performance Level 2: No water entry above allowable @ 6-18 psf

(300-860 Pa)

DESIGN PRESSURE

Performance Level 1: No water entry above allowable @ **5-15** psf

(250-715 Pa)

Negative Positive @ 70 psf @ 100 psf (3350 Pa) (4785 Pa)

Class SP-PG70, Panel size - 3' x 8'

(915 mm x 2438 mm) ②

WITH EITHER 7/16" SINGLE IMPACT OR

1 1/8" INSULATED IMPACT GLASS*

DESIGN PRESSURE

Negative

In accordance with TAS 202, AAMA -1304

and ASTM F842 requirements +F1

DESIGN PRESSURE Negative Positive @70 psf @70 psf

Class SP-PG70, Panel size - 3' x 8'

(915 mm x 2438 mm) 2

WITH EITHER 7/16" SINGLE IMPACT OR

1 1/8" INSULATED IMPACT GLASS*

DESIGN PRESSURE

(3350 Pa)

(3350 Pa)

Missile Impact & Cycling 10

Protocols TAS 201 & 203: Pass

ASTM E 1886 &E1996

independent testing laboratory in October 2009.

Thermal Performance

(Floor Supported Units)

TYPE OF GLASS (1 LITE)

Double IG Impact

(air filled)

Double IG Impact Low E

(argon filled)

Double IG Impact Low E #2 & #4 surfaces (argon **CENTER OF**

FACTOR

.45

.24

.20

@ 90 psf @ 110 psf (4300 Pa) (5260 Pa)

1 Excerpts of results of 3 separate units of various panels and configurations tested by Architectural Testing, Inc., Fresno, CA, an

Positive

Positive Negative @ 90 psf @ 90 psf (4300 Pa) (4300 Pa)

OUTWARD OPENING UNITS

UNIT U-FACTOR

.50

.36

.34

SHGC (4)

.48

.19

.18

Forced Entry Resistance 1

channels).

laboratory in October 2009.

Rated, certified and labeled in accordance with NFRC 100 + 200

UNIT U-FACTOR

.49

.35

.32

INWARD OPENING UNITS

SHGC 4

.48

.19

.18

VT (5)

.51

.42

.40

2 For Canada, tested to NAFS-08 or equivalent and CSA A44051-09 (with weep holes in sills by others to drain standing water in sill ©Excerpts of results of 12'11" W x 8'3" H four panel units 1L3R tested by Architectural Testing, Inc., Fresno, CA, an independent testing

.42

VT (5)

.51

.40

Back to top

filled) Single Impact .94 .79 .57 .81 .57 .51 .51 Single Impact Low E .94 .79 .81 .25 .39 .24 .39 (SB70) **NOTES** 4 SHGC = Solar Heat Gain Coefficient (5) VT = Visible Transmittance Shown above are thermal values for select glass options only. Thermal values for many other glass options are available. These may be able to meet specific requirements, such as Energy Star values for other zones, CA Title 24 prescriptive values, other state and local energy codes, etc. Thermal values for glass with other Low E coatings and Suntuitive dynamic glass are available. Please contact NanaWall for more information. Back to top "We wanted the full length view of a glass wall in a conditioned

space, with the flexibility to open the doors to turn it into a patio.

NanaWall was the only product that was impact rated and could

meet the wind load requirements for these openings."

GALLERY RESOURCES BROCHURES SUPPORT BLOG WHY NANAWALL **APPLICATIONS OUR PRODUCTS** Residential Architects & Designers Folding Glass Walls Contractors & Builders Commercial Exterior SL45 SL70 SL73 NW Aluminum 840 NW Aluminum 640 NW Acoustical 645 WD65 WD66

Shows & Events Rep Finder Frameless Glass Walls Continuing Education HSW75 PrivaSEE

Commercial Interior

PRESS & MEDIA

Awards

Minimal Sliding Glass Walls cero

ClimaCLEAR

FSW75

Blog

CSW75

Instagram

NW Wood 540

WA67

Sliding Glass Walls

HSW60 | HSW66

NANA WALL SYSTEMS, INC. Houzz Twitter Pinterest Facebook 100 Meadowcreek Drive #250, Corte Madera, CA 94925 Sitemap | Solarlux | Legal Privacy **COOKIES SETTINGS**

Phone <u>866.579.7632</u> | <u>415.480.3479</u> Fax <u>415.383.0312</u> info@nanawall.com |Contact Us


Homeowners

ABOUT US


FAQ

Business Owners

- Bill Gaston, Lexington Country Club

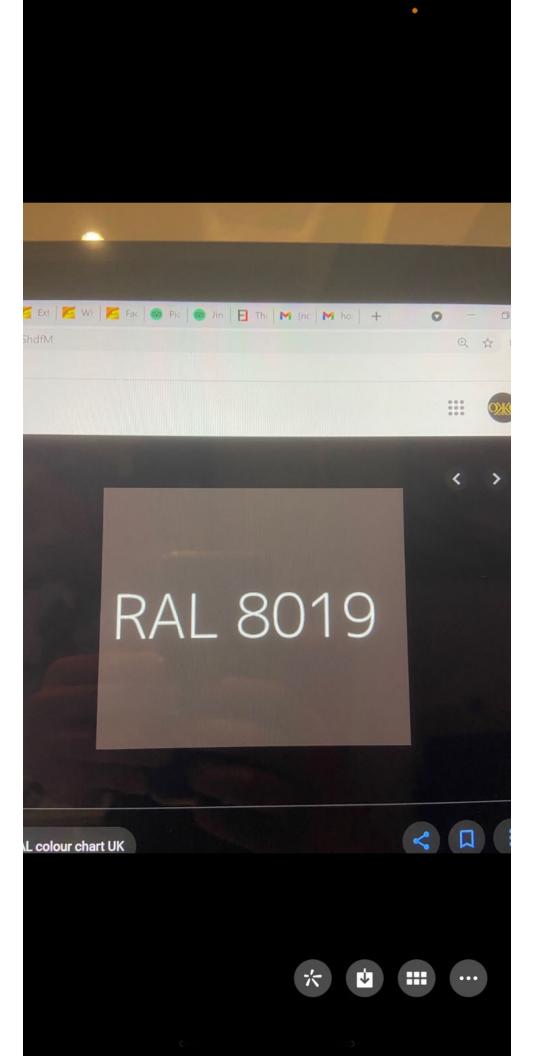



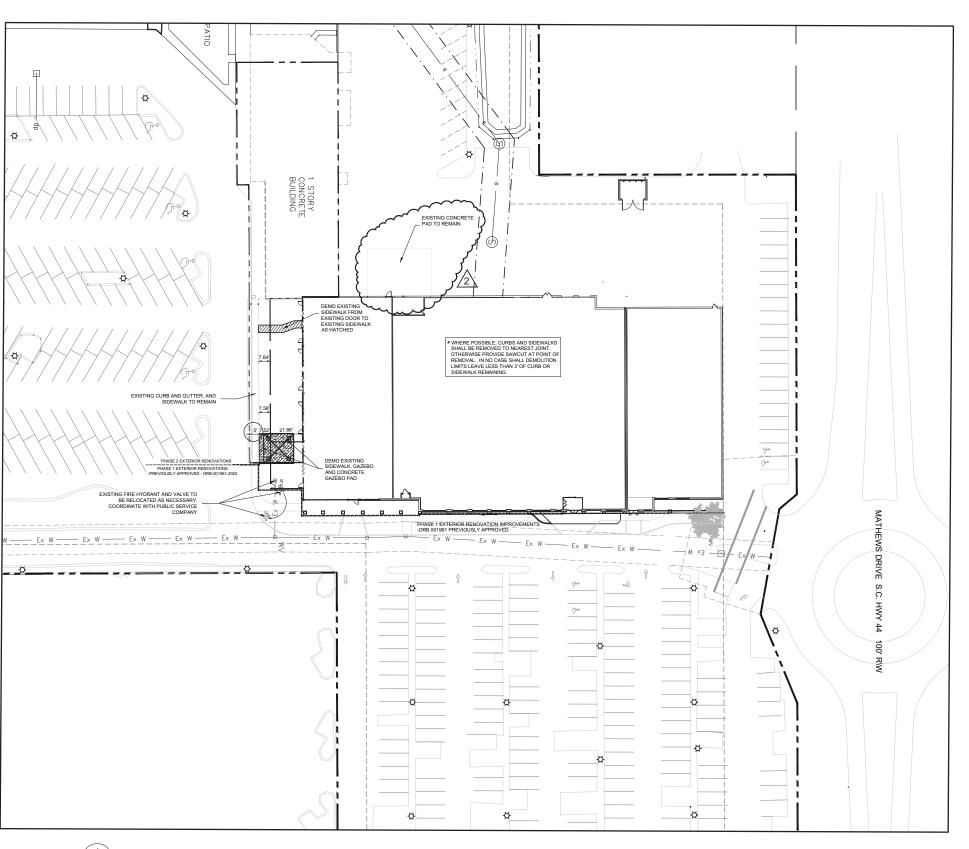

DEMOLITION NOTES:

- UTILITY LOCATIONS TO BE FIELD VERIFIED BY PROPER AGENCIES BEFORE BEGINNING CONSTRUCTION.
 UNDERGROUND UTILITIES ARE NOT FIELD LOCATED NOR ARE ALL PURPORTED TO BE SHOWN.
 INFORMATION SHOWN SHOULD BE CONSIDERED APPROXIMATE. CONTRACTOR SHALL DETERMINE THE
 EXACT LOCATION BEFORE COMMENCING WORK AND ACREES TO BE FULLY RESPONSIBLE FOR ANY AND
 ALL DAMAGES WHICH MIGHT BE OCCASIONED BY THE CONTRACTORS FAILURE TO EXACTLY LOCATE AND
 PRESERVE ANY AND ALL UNDERGROUND OR OVERHEAD UTILITIES.
- 2. CONTRACTOR SHALL BE RESPONSIBLE FOR CONTACTING UTILITY PROVIDERS AND REMOVING EXISTING BUILDING UTILITIES TO A POINT TO ACCOMMODATE THE NEW BUILDING. CONTRACTOR SHALL BE RESPONSIBLE FOR COORDINATING WITH THE OWNER/BUILDING CONTRACTOR FOR RECONNECTION OF BUILDING UTILITIES.
- 3. ALL WORK AND MATERIALS SHALL COMPLY WITH THE CITY, STATE, FEDERAL, O.S.H.A. REGULATIONS, CODES AND STANDARDS. CONTRACTOR SHALL OBTAIN ALL PERMITS BEFORE CONSTRUCTION BEGINS.
- 4. NECESSARY AND SUFFICIENT BARRICADES, LIGHTS, SIGNS, AND OTHER TRAFFIC CONTROL MEASURES AS MAY BE NECESSARY FOR THE PROTECTION AND SAFETY OF THE PUBLIC SHALL BE PROVIDED AND MAINTAINED THROUGHOUT THE CONSTRUCTION PERIOD.
- 5. NOTIFY THE CITY INSPECTIONS DEPARTMENT 24 HOURS PRIOR TO COMMENCEMENT OF CONSTRUCTION.
- 6. NO WORK SHALL OCCUR OFFSITE ON PROPERTY OWNED BY OTHERS WITHOUT THE OWNER AND CONTRACTOR OBTAINING WRITTEN PERMISSION AND THE REQUIRED PERMITS TO DO SO.
- 7. THE CONTRACTOR SHALL REPAIR OR REPLACE IN-KIND ANY DAMAGE THAT OCCURS AS A RESULT OF HIS WORK.
- 8. THE CONTRACTOR SHALL IMMEDIATELY NOTIFY THE ENGINEER/ARCHITECT OF ANY CONFLICTING INFORMATION OR DISCREPANCIES THAT EXISTS ON THE CONTRACT DOCUMENTS OR DRAWINGS.
- IN THE EVENT THAT THERE IS CONFLICTING INFORMATION ON THE DRAWING OR SPECIFICATIONS THE MORE STRINGENT REQUIREMENT WILL APPLY.

copyright @ 2021

PORT ROYAL PLAZA RENOVATION PHASE 2 95 Matthews Drive Hilton Head Island, SC

537 Market Street, Suite 400 Chattanooga, TN 37402 (423) 752-0107 for enciates, LLC

GFB Ass

D Engineering 11 E. 4th Street, Suite 40 nattanooga, TN 37403 3.266.3501 engineering.us



4/26/2021 DRAWN BY TJF

CHECKED BY JWW/DAS


SCALE AS SHOWN JOB NUMBER 18210


SIDEWALK DEMOLITION PLAN

DRAWING NUMBER C1.00

1 inch = 30 ft.

1 DEMOLITION PLAN C1.00 SCALE: 1" = 30'

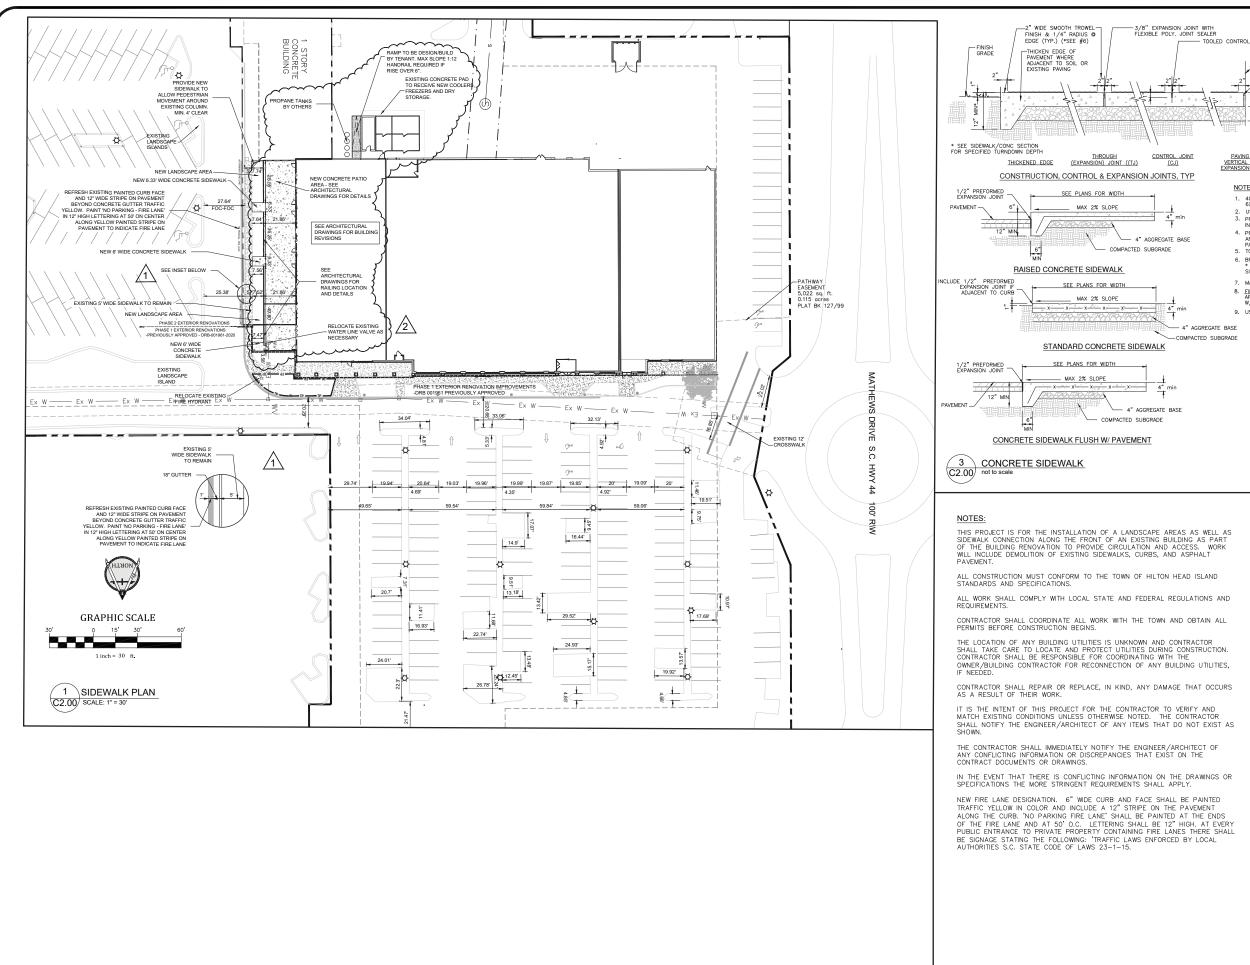

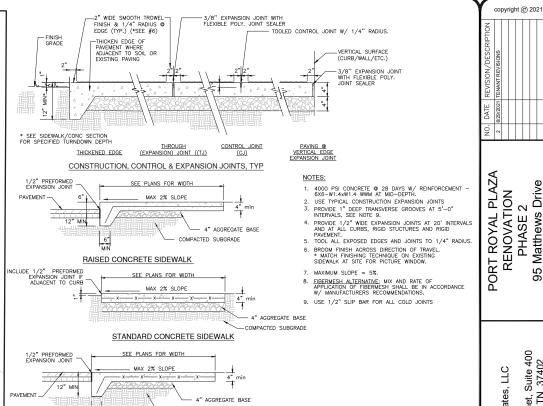



PORT ROYAL PLAZA RENOVATION PHASE 2 95 Matthews Drive Hilton Head Island, SC

537 Market Street, Suite 400 Chattanooga, TN 37402 (423) 752-0107 ates, LLC for it GFB,





4/26/2021 RAWN BY


CHECKED BY JWW/DAS

SCALE AS SHOWN

JOB NUMBER 18210

SIDEWALK **IMPROVEMENTS** PLAN

DRAWING NUMBER C2.00

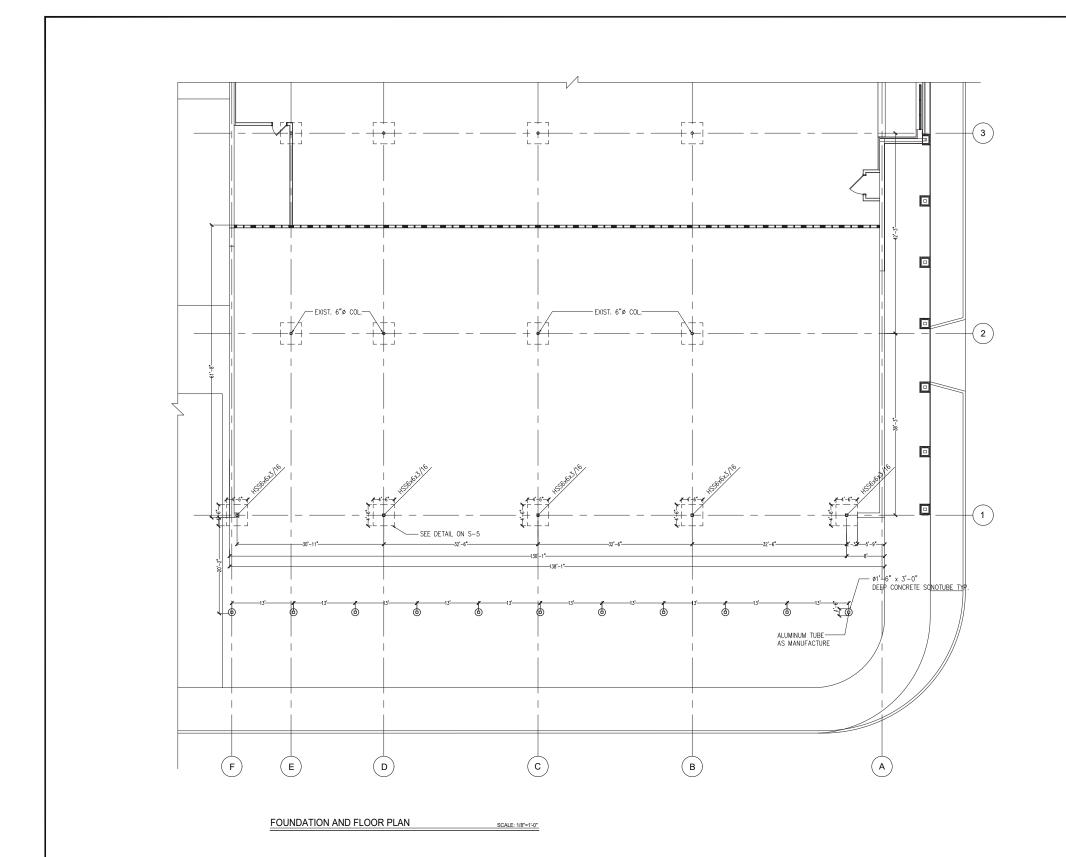

FOUNDATION PLAN NOTES

- 1. ELEVATIONS GIVEN ARE SET FROM REFERENCE ELEVATION. REFERENCE ELEVATION (+0'-0') IS SET AT FINISHED FLOOR ELEV.

 1. TYPICAL SLAB-0N-GRADE IS 4" NORMAL WEIGHT CONCRETE REINFORCED W/ 6x6 -WI-1.4xW1-4 WWP OVER 10 MIL WAPOR BARRIER, OVER APPROVED SUBGRADE.

 1. LOCATE ENENFORCING 1 1/2" CUE FROM YI-SLAB.

 3. PROVIDE (2) \$3x 2"-6" IN TOP 0F SLAB @ ALL RE-ENTRANT CORNERS NOT INTERSECTION & SLAB JOINT.

 4. LOCATE SLAB JOINTS @ 20'-0" O.C. MAX. SLAB JOINTS SHALL BE LOCATED TO MANTAIN A MAXIMUM PAREL ASPECT RATIO OF 1.5 TO 1.0 SLAB JOINTS SHALL BE CONSTRUCTED.

 5. WHERE SLAB LEAWE-OUT IS INDICATED, COORDINATE FUTURE SLAB REQUIREMENTS W/ TENANT. PROVIDE DOWELS, AROUND PERMETER OF LEAWE OUT FOR FUTURE SLAB LEAVE-OUT IS INDICATED, COORDINATE W/ PLANS TO MAINTAIN MINIMUM 1'-0" COVER TO TYPOTOTING.

 6. FOOTING STEPS (IF APPLICABLE) ARE SHOWN A PROXIMATE LOCATIONS ON PLAN. CONTRACTOR SHALL FIELD VERIFY LOCATIONS & COORDINATE W/ PLANS TO MAINTAIN MINIMUM 1'-0" COVER TO TYFOOTING.

 7. REFER TO ARCHITECTURAL, MECHANICAL, ELECTRICAL, PLUMBING, AND DRAWNOS OF OTHER DISCIPLINES FOR LOCATIONS AND DIMENSIONS OF OPENINGS, DEPRESSIONS, AND OTHER NON-STRUCTURAL ITEMS.

 8. SEE FOR GENERAL NOTES.

 8. SEE FOR GENERAL NOTES.

 9. VAPOR BARRIER LINDER SLAB SHOULD BE CONTINUOUS THROUGHOUT EXTENT OF SLAB LEAVE-OUTS INDICATED.

 10. 2"-0" WERE X-2" O" SEEP X FOOTING WIDTH SHEAR KEYS SHOULD BE PROVIDED AT ALL BRACED BAY AND MOMENT FRAME COLUMNS SHOULD BE AS SHOWN.



FRANK D. MILETO A.I.A.

BEAVER BROOK DRIVE, LONG VALLEY, N.J. 0786
FINGERS FROM THE FROM THE FROM THE FINGERS FROM THE FINGERS FROM THE FROM THE FROM THE FROM THE FROM THE FROM




FOD SERVICE CONSULTANT
11 EAST BEODDWAY, UNIT ILO, NEWYORK, NY
TEL: 212740-480

PROPOSED RESTAURANT
PORT ROYAL PLAZA
SEMATHEWS DRVE
HILTON HEAD ISLAND, SC 29926

REVISIONS DATED:

DATE: 05/01/2021 SCALE: AS DRAWING DRAWN: JG JOB NO. B21-013

S-2

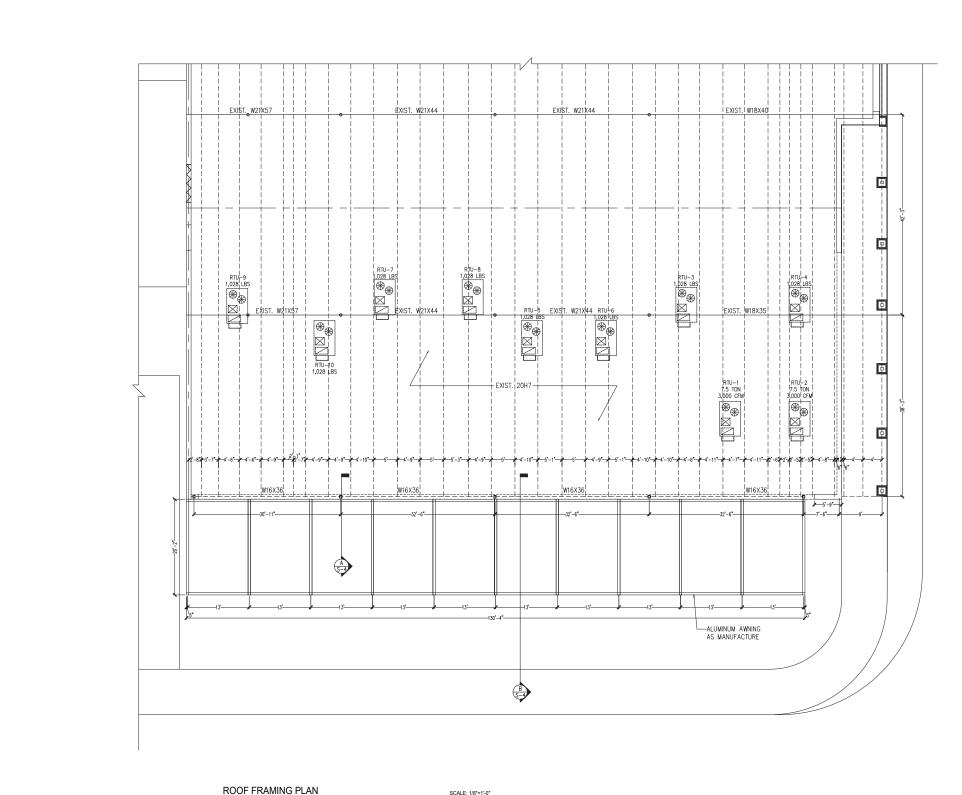

ROOF FRAMING PLAN NOTES

- 1. SEE SHEET S-1 FOR GENERAL NOTES.
 2. T/STEEL IS TYPICALLY AT JOIST BEARING ELEV. U.N.O. AS (+X") OR (-X") FROM JOIST BEARING.
 3. U.N.O. KCS JOISTS HAVE BEEN SIZED FOR RTU LOADS INDICATED.
 4. HORIZONTAL JOIST BRIDGING LOCATIONS ARE INDICATED BY --, PROWDE L1 1/4x1
 1/4 x 7/64 WELLED HORIZONTAL BRIDGING © LOCATIONS INDICATED ON PLAN.
 TERMINIATE HORIZONTAL BRIDGING VIA WELDING TO PERMIETER BEAMS. IF NO BEAM PRESENT PROVIDE DIAGONAL "X" BRIDGING BETWEEN LAST TWO JOISTS ADJACENT TO WALL.

- PRESENT PROVIDE DIAGONAL "X" BRIDGING BETWEEN LAST TWO JOISTS ADJACENT TO WALL

 5. JOIST MANUFACTURER TO PROVIDE UPUFF BRIDGING AS REQUIRED. REFER TO JOIST NOTES FOR ADDITIONAL INFORMATION.

 6. RTU LOCATIONS ARE APPROXIMATE AND SHALL BE COORDINATED W/ MECH DRAWINGS. WEIGHTS & LOCATIONS SHOWN ARE BASED ON LATEST MECHANICAL INFORMATION AT TIME OF SUBMITHAL REPORT ANY DISCREPANCES TO ARCHITECT AND ENGINEER FOR REVIEW PRIOR TO CONSTRUCTION.

 7. REFER TO ARCHITECTURAL, MECHANICAL, ELECTRICAL, PLUMBING, AND DRAWINGS OF OPENINGS. DEPRESSIONS, OND OTHER NON-STRUCTURAL TEMS. SEE DEFAILS S—5 FOR TYPICAL FRAMING ® ROOF OPENINGS.

 8. PROVIDE L44+41/4 ANGLE BOTTOM FLANGE BRACES ® 3RD POINTS OF ALL BRACED BAY BEAMS, TYP.



FRANK D. MILETO A.I.A.
14 BEAVER BROOK DRIVE, LONG VALLEY, N.J. 07853
Tel;(20)875-0405 | English)876-945
Tel:(20)876-0405 | English)876-945
ARCHITECT-PROFESSIONAL PLANNER

4

FOOD SERVICE CONSILTANT
LAM § ASSOCIATES CONSULTING,
11 EAST BROADWAY, MITTLIC, NEW YORK, NY 1
TEL 2127323450 FAX: 212732945


PROPOSED RESTAURANT PORT ROYAL PLAZA 98 MATHEWS DRIVE HILTON HEAD ISLAND, SC 29926


REVISIONS DATED:

DATE: 05/01/2021 SCALE: AS DRAWING DRAWN: JG JOB NO. B21-013

S-3

SCALE: 1/8"=1'-0"

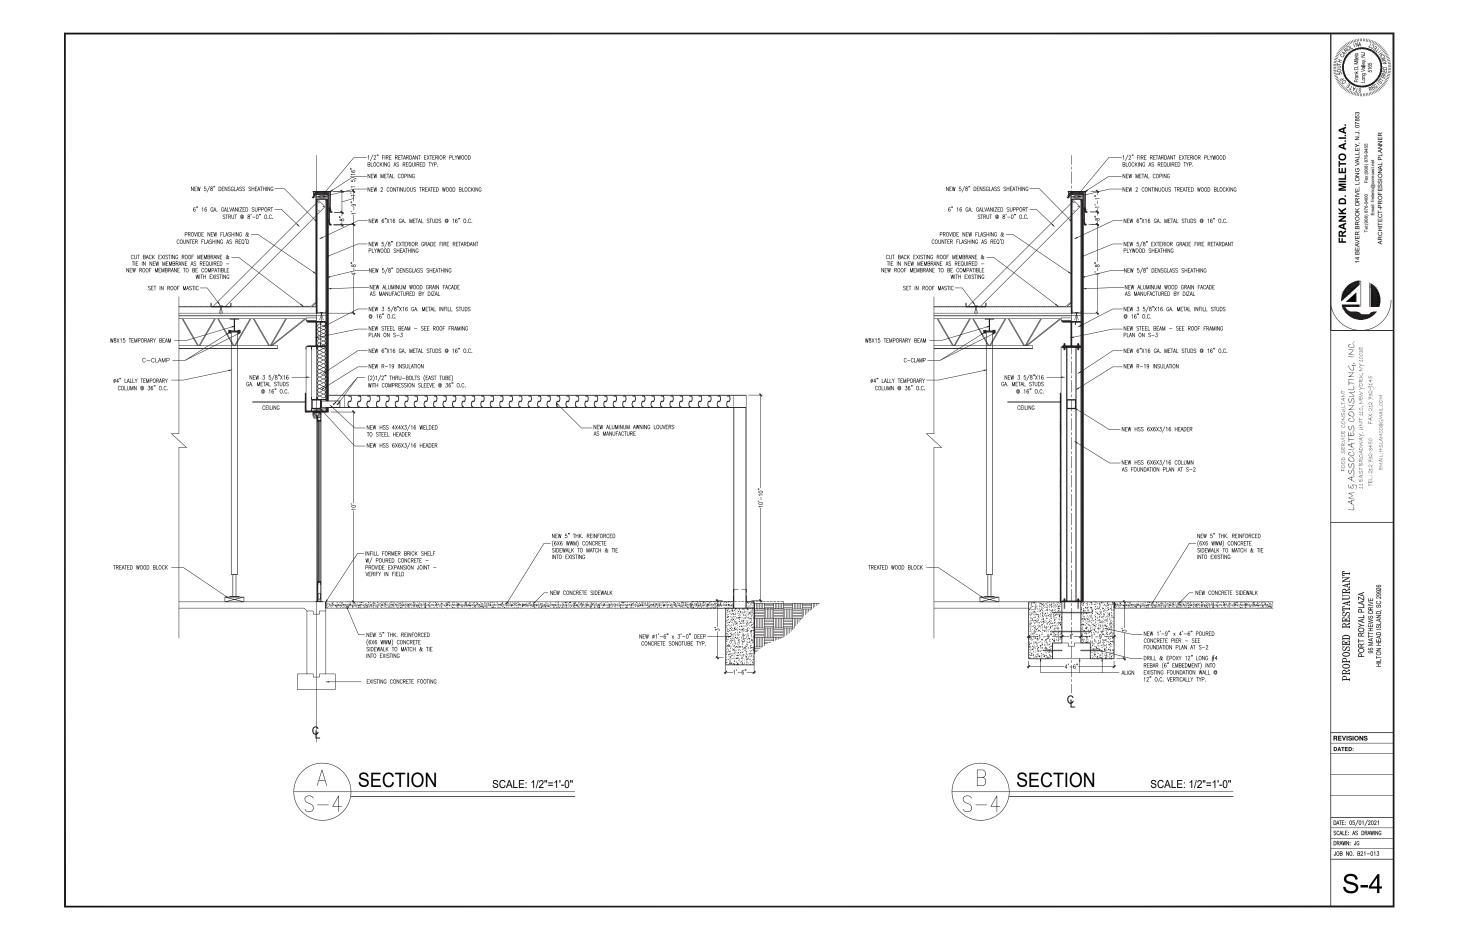

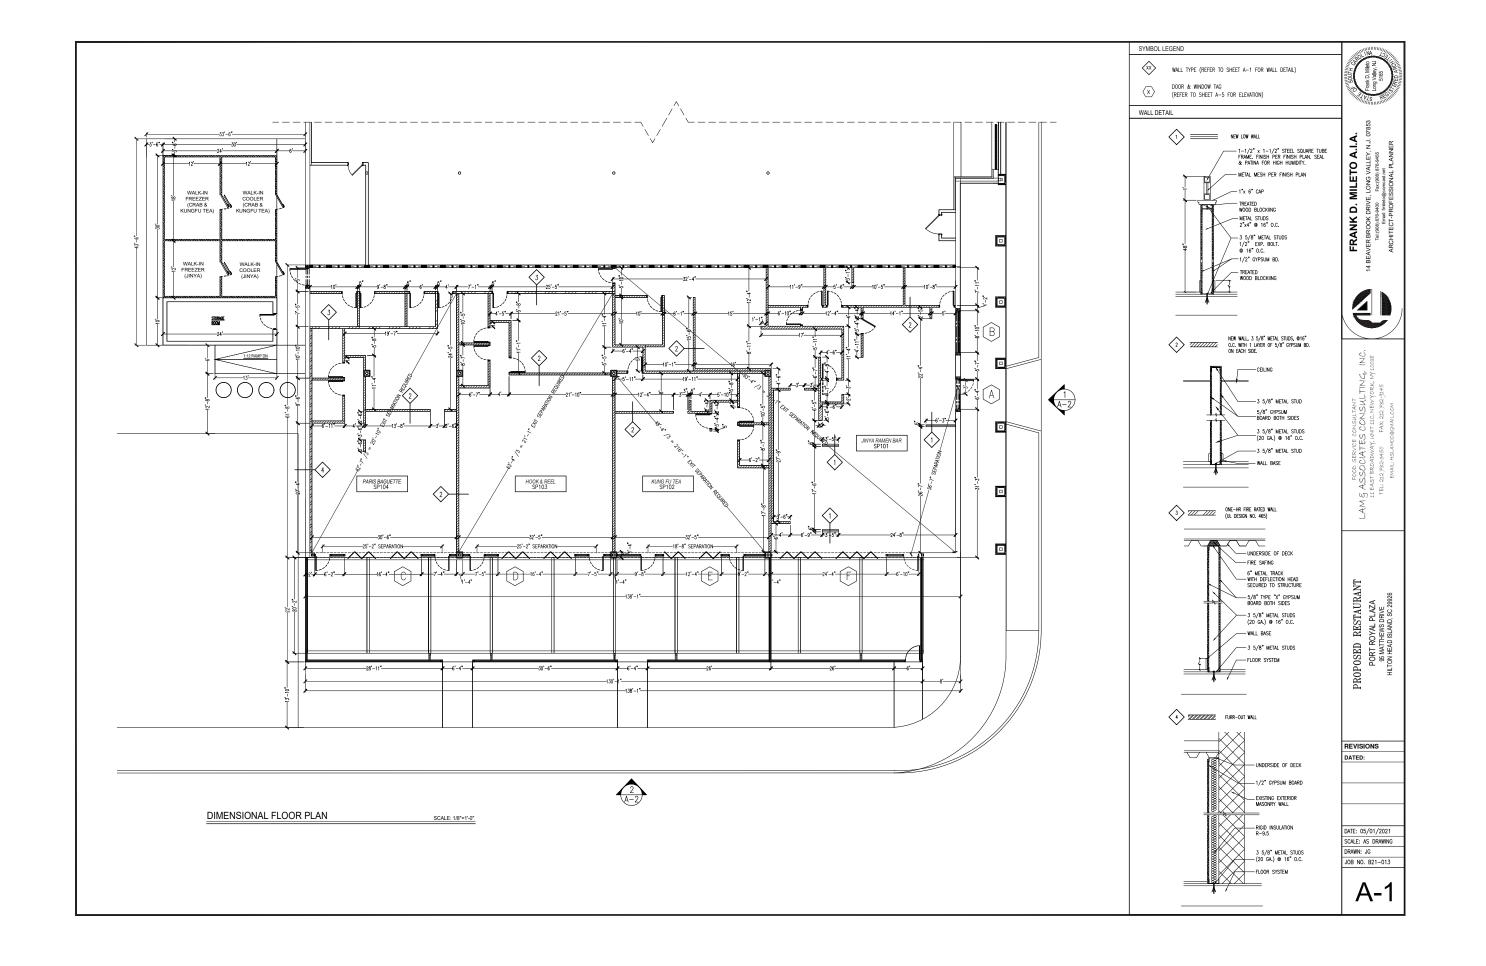


THE SIGN IS TO BE INSTALLED IN ACCORDANCE WITH THE REQUIREMENTS OF INTERNATIONAL BUILDING CODE SC MODIFICATIONS.

PHYSICAL COLOR SAMPLES SHALL BE PROVIDED BY OWNER FOR APPROVAL.

NOTE:


SIGN APPLICATION WILL BE FILED UNDER A SEPARATE APPLICATION FOR APPROVAL AND PERMIT.

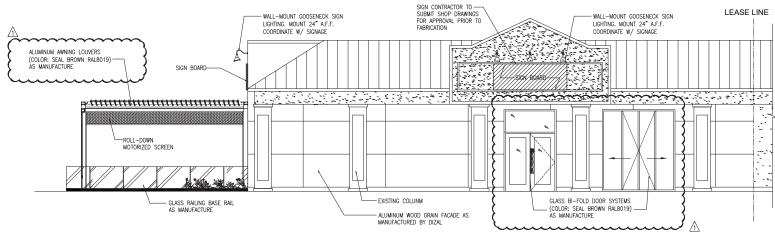



STORE LEFT ELEVATION

SCALE: 3/16"=1'-0"

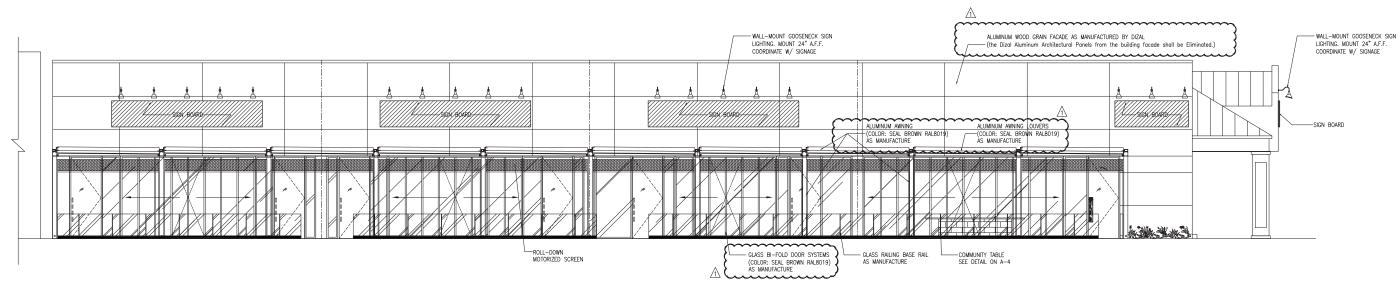

STORE FRONT ELEVATION

SCALE: 3/16"=1'-0"

FRANK D. MILETO A.1.A.
SEAVER BROOK DRIVE, LONG VALLEY, N.J. 0785
Taijobi 1782-4009 (Tex-2455)
Tail Thind (Regenants) real
ARCHITECT-PROFESSIONAL PLANNER

FOOD SERVICE CONSULTANT
11 EAST BEODAWAY, WITH 11C, NEW YORK, NY
TEL: 223 920.2450

PROPOSED RESTAURANT PORT ROYAL PLAZA 95 MATTHEWS DRIVE HILTON HEAD ISLAND, SC 2992%

REVISIONS DATED:

↑ 07/01/2021 DRB REVIEW

DATE: 05/01/2021 SCALE: AS DRAWING DRAWN: JG

JOB NO. B21-013



FRANK D. MILETO A.I.A.
14 BEAVER BROOK DRIVE, LONG VALLEY, N.J. 07853
Tatigog 878-900 Excesso 1976-905
Email fraile obgrommatated
ARCHITECT-PROFESSIONAL PLANNER

FOOD SERVEE CONSULTANT
11 GASSOCIATES CONSULTING,
11 GAST BEDADWAY, LIVITIEG, NEW YORK, NY 1
TEL: 212752-3450 EAN-TITIE


PROPOSED RESTAURANT
PORT ROYAL PLAZA
95 MATTHEWS DRIVE
HILTON HEAD ISLAND, SC 29926

REVISIONS DATED:

↑ 07/01/2021 DRB REVIEW

DATE: 05/01/2021 SCALE: AS DRAWING

DRAWN: JG JOB NO. B21-013

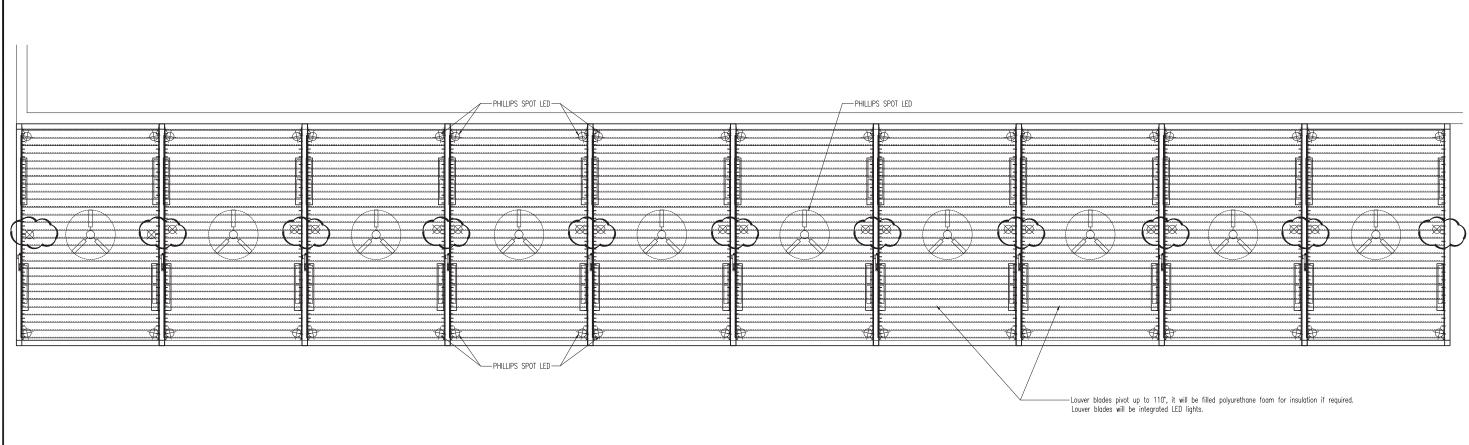

REFLECTED CEILING PLAN

SCALE: 1/4"=1'-0"

NOTE:

- 1. A LIGHTING PLAN COMPLIANT WITH LMO REQUIREMENTS SHALL BE PROVIDED BY OWNER FOR APPROVAL ..
- 2. ANY COLOR LIGHT FIXTURES SHALL BE ELIMINATED.

LEGEND

 \bowtie PHILLIPS SPOT LED


56" CEILING FAN WITH EXTENSION ROD



LOUVER BLADES AS MANUFACTURE



OUTDOOR INFRARED HEATER

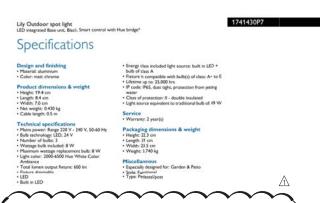

LIGHT BULBS COLOR: SOFT WHITE (3000K)



○ Dimplex

Construction Stainless Steel (304)

DIMENSIONS (DIR30A10GR)

Installation Surface-mount brackets included for wall

Version: 8.2.1

DIR Series

OUTDOOR HEATEROSPEODERCATAIONSPECIFICATIONS

Call Us 877.445.4486 INDOOR/OUTDOOR INFRARED HEATER The Dimplex DIR series heaters are perfect for homeowners, business owners, landlords, designers or builders looking to enhance an outdoor entertaining space with a premium comfort product that is Product Options complimentary to modern design. Fan Blade Finish: Barn Wood , Brushod Nickel , Gloss White , Gray Ash , Old Oak , Matte Black , Walnut Fan Body Finish: Brushod Nickel , Gloss White , Matte Black BENEFITS · IP65 rating for indoor and outdoor applications Nextrema Sch\u00e4tt glass ensures even heat distribution and minimizes light emissions Details Designed by Stephen Katz Energy Efficient, Silvers, Speed, Reversible DC Motor with New, Reliable Energy Efficient, Silvers, Speed, Reversible DC Motor with New, Reliable Energy Efficient, Silvers, Speed, Reversible DC Motor with New, Reliable Telephone Stephen 3 temperature settings - 1000W [low], 2000W [med], 3000W[high] Details • 1, 2 and 3 hourdelay timer 8 hour auto shitoff safety mechanism 6 second maximum heat up time Corrosion resistant anodized aluminum and 304 stainless steel makes this product suitable for all climates Programmable timer and remote control for ease of operation 240V hard-wired installation provides up to 3000 (3 kw) of powerful heating Each heater comes with the element(s) pre-installed, which eases in installation and reduces the risk of damaged, broken or misplaced elements upon delivery APPLICATIONS Patios | Balconies | Outdoor Living Spaces | Sunroom | Gazebos | Common Areas SPECIFICATIONS ORDERING GUIDE Cat. No. Installation Watts Volts Weight (kg/lbs.) DIR3QA10GR Wall-mounting only 3000 240 6.8 / 15.0 Voltage 240V Color Stainless Steel Class - Nextrema Schott Heating Element Ruby halogen heating element(s)

Dimensions

Additional Details


Blade: Width 2*, Diameter 56* Canopy: Diameter 8* Fixture: Height 9*, Blade Diameter 56*, Weight 17Lbs Motor: Diameter 8* Stem: Length 10*, Diameter 1*

AirFlow Efficiency: 164 cfm/watt Energy Use: 33 watts Product URL: https://www.lumens.com/eliza-h-flushmount-ceiling-fan-by-atlas-fan-company-ATLP10404.html Rating: UL Listed Damp

Eliza-H Flushmount Ceiling Fan

WALL-MOUNT GOOSENECK SIGN LIGHTING SPECIFICATIONS

LUMENS

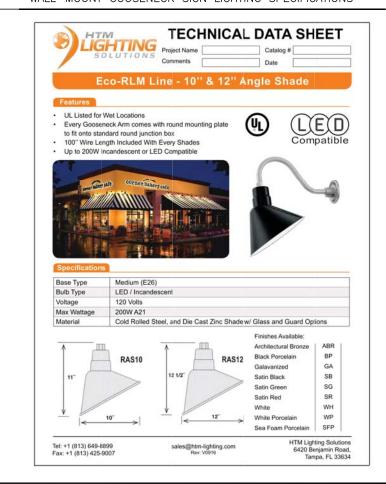

K D. MILETO A.I.A.
K DRIVE, LONG VALLEY, N.J. 0788
THIRE THIRE OF THE CONTROL PROPERTY OF THE CONTROL PLANNER
-PROFESSIONAL PLANNER FRANK



GASSOCIATES CONSULTING, 11 EAST BROADWAY, UNTILC, NEW YORK, NY


PROPOSED RESTAURANT
PORT ROYAL PLAZA
95 MATTHEWS DRIVE
HILTON HEAD ISLAND; SC 29926


REVISIONS DATED:


↑ 07/01/2021 DRB REVIEW

DATE: 05/01/2021 SCALE: AS DRAWING DRAWN: JG JOB NO. B21-013

A-3.1

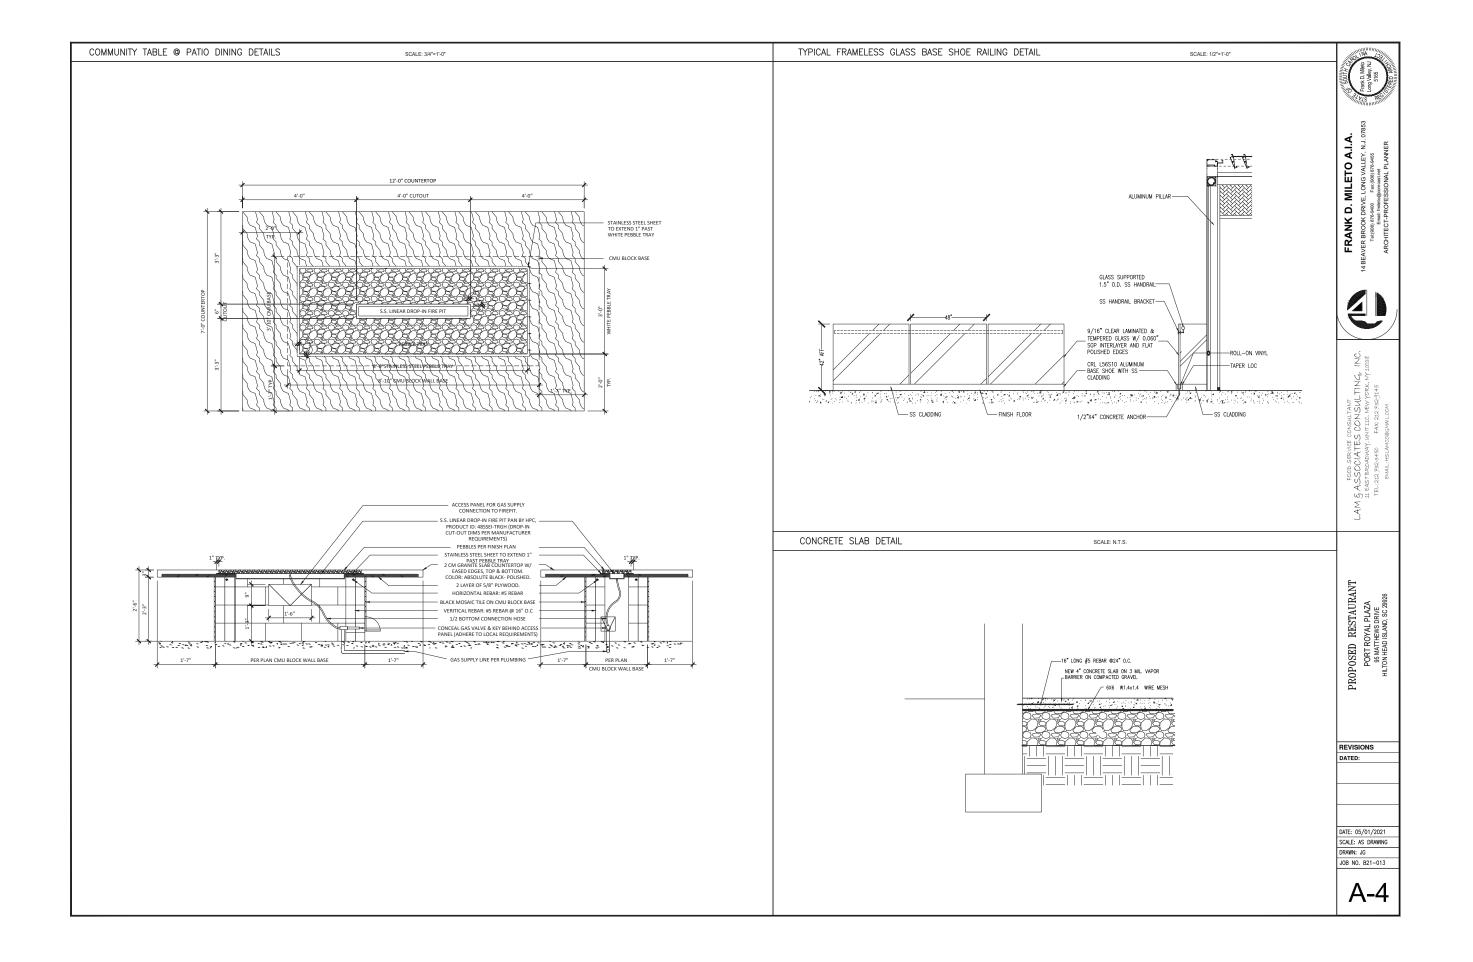

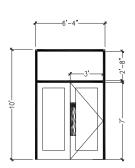

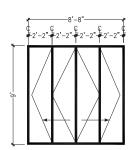

TYP. ELEVATION STOREFRONT A


SCALE: 1/4"=1'-0"


TYP. ELEVATION STOREFRONT B


SCALE: 1/4"=1'-0"

TYP. ELEVATION STOREFRONT C

SCALE: 1/4"=1'-0"

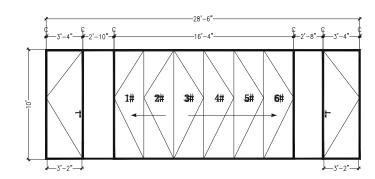

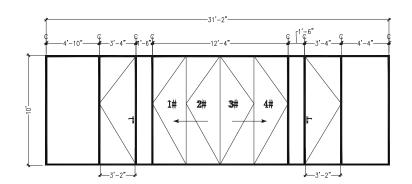

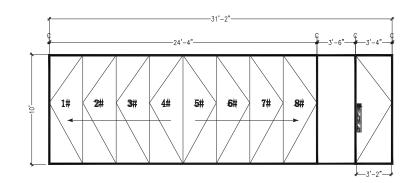

TYP. ELEVATION STOREFRONT D

SCALE: 1/4"=1'-0"


TYP. ELEVATION STOREFRONT E


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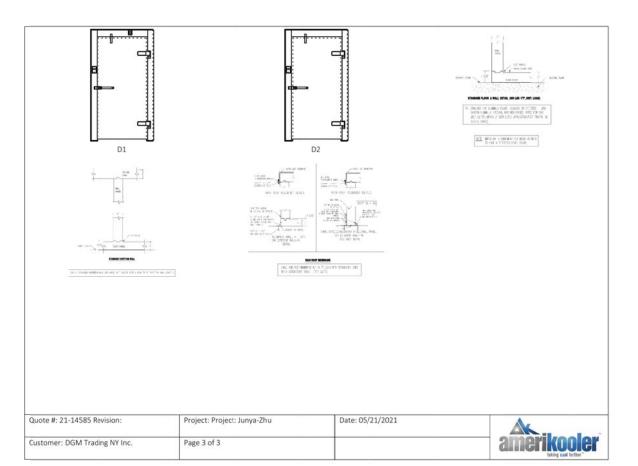
TYP. ELEVATION STOREFRONT F


SCALE: 1/4"=1'-0"

JOB NO. B21-013



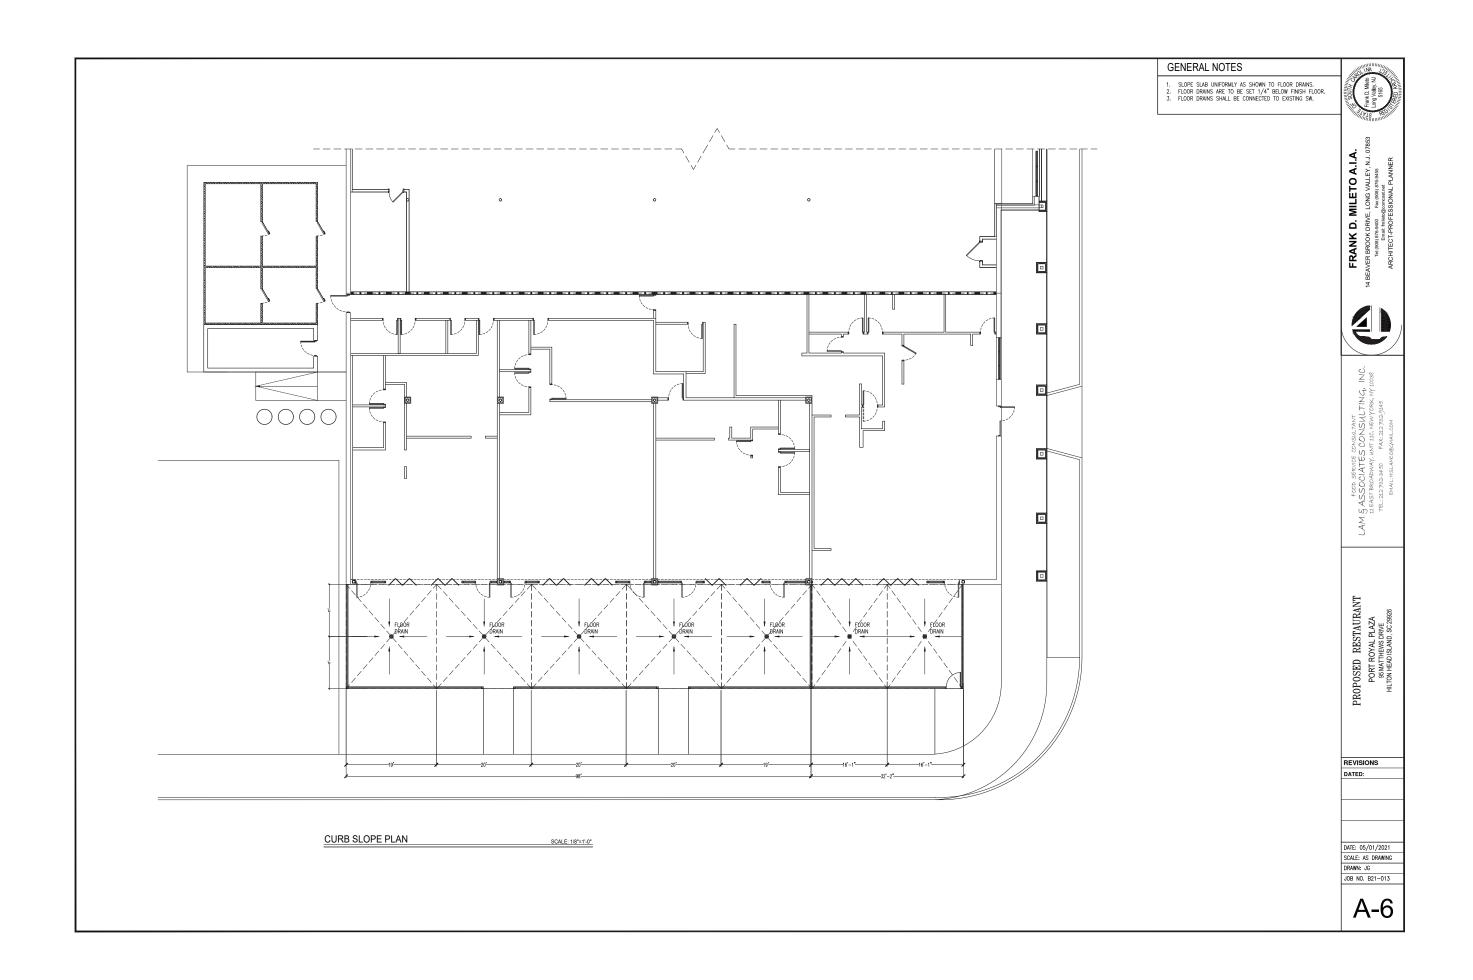

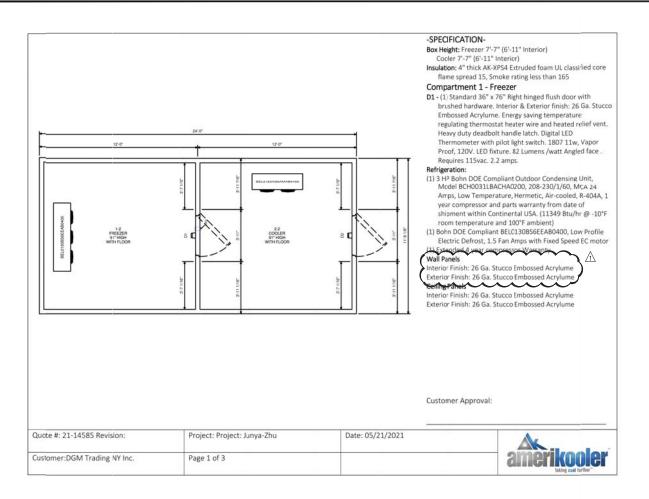

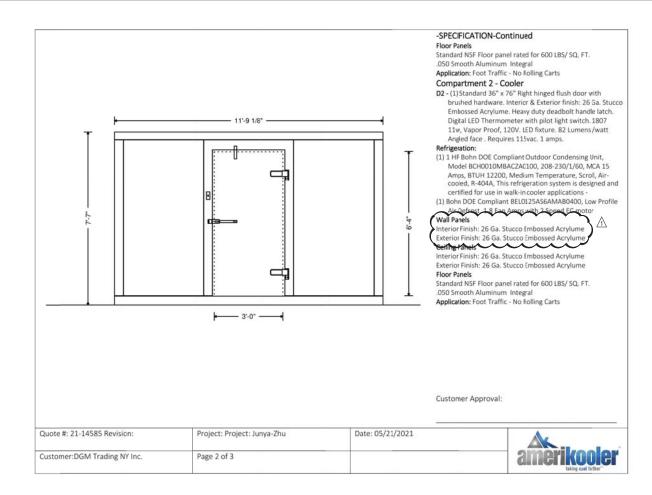





FRANK D. MILETO A.I.A.
EAVER BROOK DRIVE, LONG VALLEY, N.J. 07855
TRIEDED BTR-BADD TEXTORDS BTR-BASES
TENTE THING PROPESSIONAL PLANNER

FOOD SERVICE CONSULTANT LAM & ASSOCIATES CONSULTING, 11 EAST BROADWAY, WINT 110, NEW YORK, NY 1


PROPOSED RESTAURANT

REVISIONS DATED:

↑ 07/01/2021 DRB REVIEW

DATE: 05/01/2021 SCALE: AS DRAWING

DRAWN: JG JOB NO. B21-013

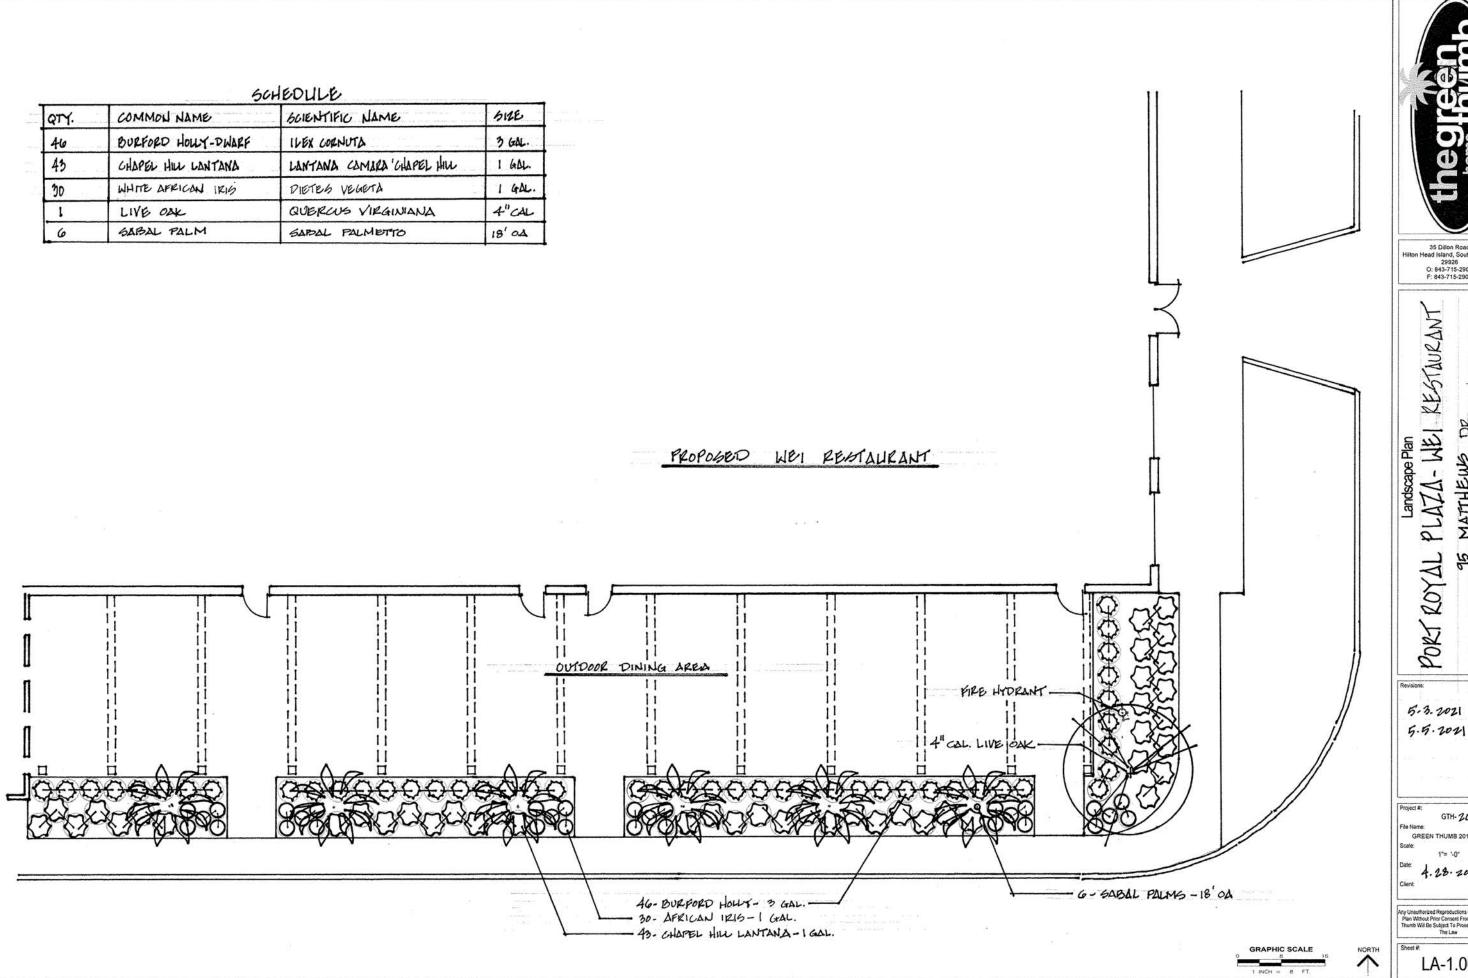

35 Dillon Road Head Island, South Ca 29926 O: 843-715-2908 F: 843-715-2909

PLAZA- WEI RESTAURANT

5-3-2021

GTH- 20492

GREEN THUMB 2018.dwg

4.28.2021

LA-1.00

DESIGN TEAM/DRB COMMENT SHEET

The comments below are staff recommendations to the Design Review Board (DRB) and do NOT constitute DRB approval or denial.

PROJECT NAME: Wei Food Hall DRB#: DRB-001598-2021
DATE: 06/30/21 07/02/21
RECOMMENDATION: Approval Approval with Conditions Denial RECOMMENDED CONDITIONS: (submit revised drawings for review and approval by Staff) 1. Eliminate the Dizal Aluminum Architectural Panels from the building facade. 2. Raise the top of the proposed bi-fold door in detail 1/A-2 'Store Left Elevation' to match the top of the transom over the
 adjacent door. 3. Specify the exterior color of the proposed coolers at the back of the building or provide a plan and detail to screen them. 4. Provide a lighting plan compliant with LMO requirements. 5. Eliminate any color light fixtures.
6. Specify the location of the proposed Gooseneck fixture. Given the number of fixtures per sign, please provide lighting levels on the sign that meet LMO requirements and confirm these fixtures do not exceed 3000K.
7. Specify on the drawings: a. The color of the awning structure, b. The color of the awning material, c. The new storefront window and door frame color.
8. Provide physical color samples for approval at the meeting.
9. Provide a detail or plan on how the patio surface will be drained.
ARCHITECTURAL DESIGN

No

 \boxtimes

Not Applicable

Comments or Conditions

The way the Dizal Aluminum Architectural Panels are

used on the building façade is inconsistent with the

rest of the building and shopping center.

Complies

Yes

DESIGN GUIDE/LMO CRITERIA

Avoids monotonous planes or unrelieved repetition

Windows are in proportion to the facade				The top of the proposed bi-fold door in detail 1/A-2 'Store Left Elevation' should match the top of the transom over the adjacent door.			
Utilities and equipment are concealed from view				Specify the color of the proposed coolers at the back of the building or screen them. Provide specification or detail for review and approval.			
Decorative lighting is limited and low wattage and adds to the visual character		\boxtimes		Please provide a lighting plan.			
MISC COMMENTS/QUESTIONS							
1. The application does not include a lighting plan. Per the LMO, the lighting plan should indicate an average of .75 foot-candles not exceeding 8 foot-candles. The 3000K specified is compliant with the Design Guide.							
2. It appears with the Philips Spot fixtures different colored lighting is possible. Color lighting is not in keeping with the spirit of the LMO sec 16-5-114. 13.(B) and not in keeping with Island Character as described by the Design Guide.							
3. Please clarify where the Gooseneck Sign Lighting is proposed to be installed. Please note signs are approved under a separate permit.							
4. Specify on the drawings:							
a. The color of the awning structure,							
b. The color of the awning material,							
c. The new storefront window and door fr	c. The new storefront window and door frame color.						
5. Community Table							
a. Please specify the location of this structure.							
b. Reconsider the color of the black tile. Per the Design Guide, page 16, "the use of black, white or off-white is typically avoided". Consider an							
alternate color scheme that includes dark bronze.							
	6. Please provide physical color samples for review at the meeting.						
7. While not a requirement, you may want to consider ornamental grasses like Fakahatchee to replace the hollies. They may be more in keeping with the							
concept of the awning structure.							

8. Provide a detail or plan on how the patio surface will be drained.