

Town of Hilton Head Island

Design Review Board Meeting Tuesday, March 8, 2022 – 1:15 p.m.

This meeting will be conducted virtually and can be viewed on the <u>Town of Hilton Head Island Public Meetings Facebook Page</u>. A Facebook account is not required to access the meeting livestream.

AGENDA

- 1. Call to Order
- 2. FOIA Compliance Public notification of this meeting has been published, posted, and distributed in compliance with the South Carolina Freedom of Information Act and the requirements of the Town of Hilton Head Island.
- 3. Roll Call
- 4. Approval of Agenda
- 5. Approval of Minutes
 - a. Meeting of February 22, 2022

6. Appearance by Citizens

Citizens who wish to address the Board concerning items on the agenda may do so by contacting the Board Secretary at 843-341-4691 no later than 12:15 p.m. the day of the meeting. Citizens may also submit written comments via the Town's Open Town Hall Portal. The portal will close at 12:15 p.m. the day of the meeting. Comments submitted through the portal will be provided to the Board and made part of the official record.

7. Old Business

- a. Alteration/Addition
 - i. Spinnaker Building, DRB-000384-2022 (Staff Report)

8. New Business

- a. New Development Final
 - i. Spanish Wells Office Warehouse, DRB-000497-2022
- **b.** Alteration/Addition
 - i. Northridge Plaza Walkway Canopy, DRB-000485-2022
 - ii. Lucky Beach Bar + Kitchen, DRB-000498-2022

9. Board Business

10. Staff Report

a. Minor Corridor Report

11. Adjournment

Please note that a quorum of Town Council may result if four (4) or more of their members attend this meeting.



Town of Hilton Head Island

Design Review Board Meeting

February 22, 2022, at 1:15 p.m. Virtual Meeting

MEETING MINUTES

Present from the Board: Chair Cathy Foss, Annette Lippert, Judd Carstens, Ryan Bassett,

Ben Brown

Absent from the Board: Vice Chairman John Moleski (excused)

Present from Town Council: Tamara Becker

Present from Town Staff: Teri Lewis, Deputy Community Development Director; Chris Darnell, Urban Designer; Teresa Haley, Senior Administrative Assistant; Vicki

Pfannenschmidt, Temporary Administrative Assistant

1. Call to Order

Chair Foss called the meeting to order at 1:15 p.m.

- 2. FOIA Compliance Public notification of this meeting has been published, posted, and distributed in compliance with the South Carolina Freedom of Information Act and the requirements of the Town of Hilton Head Island.
- 3. Roll Call See as noted above.

4. Approval of Agenda

Chair Foss asked if there were any changes to the agenda. There being none, Ms. Lippert moved to approve. Mr. Brown seconded. By show of hands, the motion passed with a vote of 5-0-0.

5. Approval of Minutes

a. Regular Meeting of February 8, 2022

Chair Foss asked for a motion to approve the minutes of the February 8, 2022, regular meeting. Mr. Bassett moved to approve. Mr. Carstens seconded. By show of hands, the motion passed with a vote of 4-0-1. (Chair Foss abstained as she was not present at the subject meeting.)

6. Appearance by Citizens

Public comments concerning agenda items were to be submitted electronically via the Open Town Hall HHI portal. Those comments were provided to the Board for review and made part of the official record. In addition, citizens were provided the option to sign up for public comment participation during the meeting by phone. One citizen signed up to speak regarding Item 8.a.i. and will address the Board at that time.

- 7. Unfinished Business None
- 8. New Business

a. Alteration/Addition

i. Spinnaker Building, DRB-000384-2022

Mr. Darnell presented the application as described in the Board's agenda package and stated Staff recommends denial. He noted that if the railings are permitted to remain removed, window stops would have to be installed to prevent the window from opening more than four inches. Mr. Darnell informed the Board of a letter received regarding this matter that details a potential conflict in the Master Deed with the removal of the railing. He stated Staff would like to obtain legal determination and recommended the item be tabled until the next scheduled meeting.

Chair Foss asked for comment from the applicant. Ms. Carolyn Nebbia, President of Village West Association explained the reasoning for the removal. Chair Foss then asked for public comment on the item. Mr. Chet Williams, the author of the letter written on behalf of Mary Ann Griffin, referenced items of concern and objections regarding the removal of the railing.

After comments, Chair Foss moved to table DRB-000384-2022 until the letter received is reviewed by the Town Attorney and a legal determination is made. Ms. Lippert seconded. By way of roll call, the motion was approved by a vote of 5-0-0.

9. Board Business - None

10. Staff Report

a. Minor Corridor Report – None

11. Adjournment

The meeting adjourned at 1:32 p.m.

Submitted by: Vicki Pfannenschmidt, Secretary

Approved: [DATE]



Town of Hilton Head Island

Community Development Department

One Town Center Court Hilton Head Island, SC 29928

Phone: 843-341-4757 Fax: 843-842-8908

www.hiltonheadislandsc.gov

FOR OFFICIAL USE ONL	Y
Date Received:	
Accepted by:	
DRB #:	
Meeting Date:	

Applicant/Agent Name: JAMES ATKINS Company: COURT ATKINS GROUP Mailing Address: P.O. BOX 3978 City: BLUFFTON State: SC Zip: 29910 Telephone: 843-815-2557 Fax: E-mail: jason. broenea) court atkins. com Project Name: Spanish Wells Office Warehove B Project Address: 296 SPANISH WELLS POAD Parcel Number [PIN]: R51000700001550000 Zoning District: LIGHT INDUSTRIAL (LL) Overlay District(s): CORRIDATE OVERLAY DISTRIC
CORRIDOR REVIEW, MAJOR DESIGN REVIEW BOARD (DRB) SUBMITTAL REQUIREMENTS
Digital Submissions may be accepted via e-mail by calling 843-341-4757.
Project Category: Concept Approval – Proposed Development Alteration/Addition Sign
Submittal Requirements for <i>All</i> projects: Private Architectural Review Board (ARB) Notice of Action (if applicable): When a project is within the jurisdiction of an ARB, the applicant shall submit such ARB's written notice of action per LMO Section 16-2-103.I.4.b.iii.01. Submitting an application to the ARB to meet this requirement is the responsibility of the applicant.
Filing Fee: Concept Approval-Proposed Development \$175 Final Approval – Proposed Development \$175, Alterations/Additions \$100, Signs \$25; cash or check made payable to the Town of Hilton Head Island.
Additional Submittal Requirements: Concept Approval – Proposed Development A survey (1"=30' minimum scale) of property lines, existing topography and the location of trees meeting the tree protection regulations of Sec. 16-6-104.C.2, and if applicable, location of bordering streets, marshes and beaches. A site analysis study to include specimen trees, access, significant topography, wetlands, buffers, setbacks, views, orientation and other site features that may influence design. A draft written narrative describing the design intent of the project, its goals and objectives and how it reflects the site analysis results. Context photographs of neighboring uses and architectural styles. Conceptual site plan (to scale) showing proposed location of new structures, parking areas and landscaping. Conceptual sketches of primary exterior elevations showing architectural character of the proposed development, materials, colors, shadow lines and landscaping.

Additional Submittal Requirements: Final Approval – Proposed Development A final written narrative describing how the project conforms with the conceptual approval and design review guidelines of Sec. 16-3-106.F.3. Final site development plan meeting the requirements of Appendix D: D-6.F. Final site lighting and landscaping plans meeting the requirements of Appendix D: D-6.H and D-6.I. Final floor plans and elevation drawings (1/8"=1'-0" minimum scale) showing exterior building materials and colors with architectural sections and details to adequately describe the project. A color board (11"x17" maximum) containing actual color samples of all exterior finishes, keyed to the elevations, and indicating the manufacturer's name and color designation. Any additional information requested by the Design Review Board at the time of concept approval, such as scale model or color renderings, that the Board finds necessary in order to act on a final application.
Additional Submittal Requirements: Alterations/Additions All of the materials required for final approval of proposed development as listed above, plus the following additional materials. A survey (1"=30' minimum scale) of property lines, existing topography and the location of trees meeting the tree protection regulations of Sec. 16-6-104.C.2, and if applicable, location of bordering streets, marshes and beaches. Photographs of existing structure.
Additional Submittal Requirements: Signs Accurate color rendering of sign showing dimensions, type of lettering, materials and actual color samples. For freestanding signs: Site plan (1"=30" minimum scale) showing location of sign in relation to buildings, parking, existing signs, and property lines. Proposed landscaping plan. For wall signs: Photograph or drawing of the building depicting the proposed location of the sign. Location, fixture type, and wattage of any proposed lighting.
Note: All application items must be received by the deadline date in order to be reviewed by the DRB per LMO Appendix D: D-23. A representative for each agenda item is strongly encouraged to attend the meeting. Are there recorded private covenants and/or restrictions that are contrary to, conflict with, or prohibit the proposed request? If yes, a copy of the private covenants and/or restrictions must be submitted with this application. YES NO
To the best of my knowledge, the information on this application and all additional documentation is tru factual, and complete. I hereby agree to abide by all conditions of any approvals granted by the Town of Hilto Head Island. I understand that such conditions shall apply to the subject property only and are a right obligation transferable by sale.
I further understand that in the event of a State of Emergency due to a Disaster, the review and approval time set forth in the Land Management Ordinance may be suspended. SIGNATURE DATE

SIGNATURE Last Revised 01/21/15

PROJECT NARRATIVE FOR DESIGN REVIEW BOARD FINAL DESIGN REVIEW BOARD SUBMITTAL TOWN OF HILTON HEAD ISLAND, SOUTH CAROLINA

Project: Spanish Wells Office and Warehouse Building

Date: February 22, 2022

Applicant: Court Atkins Architects on behalf of Hilton Head Church Investors I, LLC

Agent: Court Atkins Architects, Inc.

Contact: Jason Broene, Studio Manager

P.O. Box 3978 Bluffton, SC 29910 Tel: (843) 815-2557 Fax: (843) 815-2547

Parcel: R510 007 000 0155 0000

Zoning: Light Industrial (LI)

Property Owner: Hilton Head Church Investors I, LLC

Approval sought: Final Review with comments

ARCHITECTURE NARRATIVE Description

The Spanish Wells Office and Warehouse project is a new building being proposed at 296 Spanish Wells Road adjacent to the existing Resurrection Church. . The building consists of the following characteristics:

- 1. The building is a single story 6,593 sqft. pre-engineering metal building shell for the potential of up to (6) office and/or warehouse tenant spaces. The building material and forms are in keeping the Town's design guidelines featuring sloped roof forms, wood bracketed awnings, decorative louvers, aluminum storefront doors and windows and stucco veneer with trim.
- 2. The building will utilize a pre-engineered metal building frame, sloped roof forms with gutters and downspouts, and stucco veneer on the front and two sides of the building.
- 3. The north elevation, which faces the parking lot, will feature sloped roof forms, aluminum storefront doors and windows, and overhead roll-up doors for each tenant, designated location for tenant signage, bracketed metal awnings, and stucco veneer with trim.
- 4. The east elevation, which faces Spanish Wells Road will feature sloped roof forms, stucco veneer and trim, bracketed metal awning, and decorative metal louvers.
- 5. The south / rear elevation which faces the existing tree line and power line easement, will house the building's services. This elevation will feature sloped roof forms, stucco veneer, painted hollow metal egress doors and gutters with downspouts, screened HVAC units.

- 6. The west elevation, which faces the power line easement, will feature stucco veneer with trim, overhead roll-up door, sloped roof forms, and screened HVAC units.
- 7. A color board has been submitted and the colors will be harmonious with the surrounding buildings and landscape and meet the intent of the LMO.
- 8. Should you have any questions or need any additional information please do not hesitate to ask.

Response to Conceptual Review Comments

- 1. Revise the rear elevation to include more architectural detail.
 - a. Rear elevation has been changed to stucco veneer with trim to match remainder of building. Gutter and downspouts have also been added to the elevation.
- 2. Revise landscape plan to include more evergreen species in the street buffer.
 - a. Additional evergreen species have been added, see landscape plan.
- 3. Clarify how the rain garden will be treated (planted).
 - a. Rain garden to be treated with sod, mulch and plant material. See "Rain Gardens" note on landscape plan.
- 4. Connect the sidewalk in front of the building to the pathway along Spanish Wells Road.
 - a. A sidewalk path has been provided for connectivity.
- 5. Restudy roof overhangs
 - a. The gable end roof overhangs were extended to an 2'-0" overhang and the rake overhang was extended to an 1'-0".
- 6. Clarify dumpster location on the site plan and provide a screen.
 - a. Dumpster is located adjacent to Raingarden #1 and screening details are shown on site development drawings.

END



Project:

Fixture Type:



Image

RLM RS12 GNA22 H: 15 W: 12 E: 28 MC: 7

Description

12" RLM, 22" Gooseneck arm

Specifications

Housing Spun aluminum shade with extruded arm and cast canopy

Diffuser/Optics • Bare lamp (no diffuser) for Dry locations only

• Clear glass cylinder

· Clear prismatic glass cylinder

• FR - Frosted Glass

Light Source **GUL MBL** Medium Base

Max Watts 15 100 11

Electrical MB - Accepts Medium base 120V incandescent, CFL or LED lamps (by others) rated for use in fully enclosed fixtures.

- Includes Medium base 120V HPF Triac dimmable OmniLED A lamp rated for use in fully enclosed fixtures.

FINISH

- Includes GU24 base 120V HPF Triac dimmable 25,000 Hr OmniLED A lamp with integrated driver. GUL

Mounting Mounts over 4" recessed outlet box.

Certification Manufactured in accordance with U.L. standard 1598 - Suitable for wet locations (with diffuser only)







Ordering Guide: Choose from each category, using designated code to specify.

RS12 GNA22

MODEL **DIFFUSER** LIGHT SOURCE

Diffuser/Optics

- Bare-lamp (no diffuser) CL - Clear glass CPR - Clear prismatic glass FR - Frosted glass

Light Source

MBL6A - 5.5W/30K 470 Lm OmniLED MBL9.8A - 9.8W/30K 800 Lm OmniLED

MBL10A JA8 - 10W/30K 800 Lm 90+ CRI OmniLED GUL11A - 11W/27K 1100 Lm GU24 OmniLED MBL11A - 11W/30K 1100 Lm OmniLED

MBL13A JA8 - 13W/30K 1100 Lm 90+ CRI OmniLED MBL15A - 15./30K 1600 Lm OmniLED

MB - 100W Max Incand A (by others)

EXTRAS Finish

Standard

BL - Black **DB** - Dura-Bronze WH - White

Upgraded*

RAL - Specify Color # UPG - Select Color from <u>Luraline Pallette</u>

Premium*

CCM - Custom Color CIC - Inner Color CTC - Clear Top Coat * Subject to Surcharge Extras (Order Separately)

DWG12 12" Drop Wire Guard







SLIM WALL PACK

LED ADJUSTABLE WALL PACK



FEATURES

- Low profile die-cast aluminum housing
- Bronze polyester powder coat finish (std.)
- Custom and factory select colors available¹
- Isolated optical compartment with tempered glass lens and silicone gaskets
- 90° adjustable Type IV distribution or Optional IDA fixed model²
- Quick mount bracket standard for easy surface mount installation
- Three ½" coin plugs on sides for conduit or electronic photocell
- 120-277V Universal Voltage or 347V-480V High Voltage³
- · Achieve code compliance with a fixed down PIR sensor with fully adjustable distribution aiming
- 0-10V Dimmable Driver (std.)
- Deep box 10W CEC Title 20 compliant battery backup & cold weather battery¹
- Optional Field Adjustable Output device (FAO) allows individual luminaire lumen
- 3000K, 4000K & 5000K CCT Selectable via Integral selector
- >70 Color Rendering Index (CRI)
- Calculated L₇₀ >100,000 hrs @ 25°C per TM-21-11
- IP65 Rated Luminaire
- 5 Year Warranty (std); 10 Year Warranty Optional
- ETL Listed for Wet Locations
- DesignLights Consortium® Premium Qualified Luminaire

¹Contact factory for pricing and availability ²Fixed 3000K CCT model only 3347-480V available in 5L, 8L, 10L Lumen Packages Only





Shown with Sensor Box



















• Parking Lots



SUITABLE APPLICATIONS

- Pedestrian Walkways
- Building Entrances

• Institutions

- Multi-use Facilities
- Industrial Facilities

• Storage Facilities

- Schools
- Loading Docks

ORDERING GUIDE:

SERIES	LUMENS	DRIVER	ССТ	FINISH	WARRANTY
SWP Slim Wall Pack	2L	U 120-277V	CCTS Selectable CCT	BRZ Bronze	BLANK 5 Year
	3L	HV 1 347-480V	(5000K, 4000K, 3000K)	BLK ⁴ Black	10YR ^{7,8} 10 Year
	5L		30 ³	WHT⁴ White	
	8L			SLV ⁴ Silver	
	101				

SP12,6 10kA Max Univolt Surge Protection SWP-FAO10V Field Adjustable Output via 0-10V Wires SP2 2,6 22kA Max 120-277V Surge Protector SWP-ARM3-xxx Pole Mount Arm Kit, 3" long (xxx=BRZ, BLK, WHT, SLV) IDA³ Dark Sky IDA Fixture Seal of Approval SWP-BPS-xxx 18x9 Beauty Plate Kit, Small (xxx=BRZ, BLK, WHT, SLV) LEDBB 1,2 SWP-BPL-xxx 18x9 Beauty Plate Kit, Large (xxx=BRZ, BLK, WHT, SLV) 10W UNIV Battery Backup (32°-100°F)

LEDBBCT1,2 20W UNIV CT Battery Backup (-4°-122°F)

USBD/Lx9 Bluetooth User Select Bi-Level Dim Occ. Sensor; (x= Mounting height; 2=8', 3=20')

¹5L, 8L, 10L Lumen Packages Only

PCU²

Contact Factory for pricing and availablity

Contact Factory for more details

²Not available with HV option 5 Does not qualify for DLC

Electronic UNIV Photocell (120-277V)

Requires additional surge protection (SP1,SP2, SP480V2); ⁶SP1/SP2 specified in combination with battery backups,

³Fixed to 3000K CCT and no angle adjustability for

IDA Compliance. Must choose 30 CCT and IDA option to qualify separate surge protectors are required per electrical line

For additional details see general terms and conditions

Requires bluetooth enabled device for programming (provided by others)



SERIES	LUMENS	DRIVER	COLOR	FINISH
SWP Slim Wall Pack	2L	U 120-277V	CCTS Selectable CCT	BRZ Bronze
	3L		(5000K, 4000K, 3000K)	
	5L			
	8L			
	10L			

LED SYSTEMS INFO1	3000K			4000K				5000K			
Part Numbers	Lumens	Efficacy	Bug Rating	Lumens	Efficacy	Bug Rating	Lumens	Efficacy	Bug Rating	Watts ²	Replaces
SWP-2L-U-CCTS	2,465 lm	122 lm/W	B1-U0-G0	2,649 lm	139 lm/W	B1-U0-G0	2,493 lm	125 lm/W	B1-U0-G0	20 W	100W MH
SWP-3L-U-CCTS	3,160 lm	134 lm/W	B2-U0-G0	3,310 lm	145 lm/W	B2-U0-G0	3,226 lm	136 lm/W	B2-U0-G0	24 W	150W MH
SWP-5L-U-CCTS	5,396 lm	135 lm/W	B2-U0-G0	5,669 lm	147 lm/W	B2-U0-G0	5,515 lm	137 lm/W	B2-U0-G0	40 W	175W MH
SWP-8L-U-CCTS	8,254 lm	138 lm/W	B3-U0-G1	8,678 lm	150 lm/W	B3-U0-G1	8,455 lm	141 lm/W	B3-U0-G1	60 W	250W MH
SWP-10L-U-CCTS	10,141 lm	136 lm/W	B3-U0-G1	10,581 lm	147 lm/W	B3-U0-G1	10,335 lm	138 lm/W	B3-U0-G1	75 W	320W MH

LED Chips are frequently updated therefore values are nominal ²Electrical data at 25C (77F). Actual wattage may differ by +/-10%.

SPECIFICATIONS

CONSTRUCTION

Slim Wall Pack luminaire features a sleek low-profile die-cast aluminum housing with matching housing styles for both a small and medium size housings. Slim Wall Pack is protected with a durable Bronze polyester powder coat finish to withstand extreme weather changes without cracking or peeling (Consult factory for availability of alternate finishes). The Adjustable head pivots up to 90° to allow for more forward throw illumination (IDA option eliminates the adjustability). Universal quick mount bracket eliminates the need to drill through the luminaire housing ensuring reliable IP65 ingress protection and fast hands-free mounting via hanging mechanism. One-piece silicone gasket seals door and back box.

ELECTRICAL

High-performance driver features over-voltage, under-voltage, short circuit and over temperature protection. 0-10V dimming (10% - 100%) standard. Standard Universal Voltage (120-277 Vac) Input 50/60 Hz or optional High Voltage (347-480 Vac). L70 >100,000 hrs. in accordance of IESNA TM-21-11 Projected values at 25°C Ambient temperature. Total harmonic distortion: <20%. Power factor: >0.90. Input power stays constant over life. Minimum 2.5kV surge rating. Optional Field Adjustable Output (FAO) accessory allows for individual lumen output control with 7 adjustable light levels per lumen package. 10W CEC Title 20 compliant battery backup & cold weather battery option available. 120-277V 10W CEC Title 20 compliant battery backup & cold weather battery options provide 90 minutes of constant power to the LED system, ensuring code compliance.

INSTALLATION

The Slim Wall Pack features a universal quick mount bracket, allowing for effortless installation to standard 3½" to 4" round/octagonal, 4" square, single gang, masonry junction boxes or vertical surface mounting (secured by four lag bolts (supplied by others)). ½" NPT conduit entry points allow for surface-conduit or thru-branch wiring. Back box is an authorized electrical wiring compartment. Fixture leads exit the back of the casting through a poke-in water-tight grommet. Integral CCT selector allows for toolless CCT tuning at installation.

OPTICS

The isolated silicone sealed optical chamber utilizes a proprietary high-reflective white molded baffle. Optical assembly features an impact-resistant tempered glass lens and meets IESNA requirements for full cutoff compliance. Available in five lumen packages and CCT selectable via an integral CCT selector switch (3000K, 4000K, & 5000K). The Adjustable head pivots up to 90° to allow for more forward throw illumination. IDA option is fixed 3000K and does not allow for head pivoting (full-cutoff).

THERMAL

The Slim Wall Pack features an array of High-efficacy mid-power LED's on a metal core circuit board. The LED board is mounted directly to a cast aluminum housing with heat dissipating fins to provide excellent thermal performance extending the life of electronic components. Operating Ambient Temperature: -40°C to +40°C (-40°F to 104°F) Operating temperature for standard battery backup: 0°C to +50°C (+32°F to +122°F), Cold Weather battery backup: -20°C to +50°C (-4°F to +122°F).

CONTROLS

Three ½" NPT apertures allow for field or factory installed 120-277V universal electronic photocell. Optional PIR sensors available installed in added sensor housing (see page 3 for more details). Sensors provide optional on/off control, photocell capability, bi-level dimming, and bluetooth configuration allows for on-site modifications. (See page 4 for more information)

CERTIFICATIONS

UL Listed for wet locations. Tested in accordance with IESNA LM-79 and I M-80 standards

WARRANTY

5 Year Warranty Standard; 10 Year Warranty Optional (<u>Terms and Conditions apply</u>).

ADDITIONAL FEATURES & OPTIONS

Quick Mount Bracket



90° Adjustable Type IV **Distribution**



Optional Beauty Plate



Optional Battery Pack



CONTROLS OPTIONS



USBD
Optional Bluetooth Programmable PIR sensor allows for Continuous Dimming, Motion and/or daylight harvesting, Fully adjustable high/low dimmed light levels, and Adjustable time delay/cutoff delay. The sensor is programmed via a free iOS® or Android® Sensor Configuration App (compatible device provided by others). Available (compatible device provided by others). Available in 8' or 20' mounting lenses. See coverage patterns below.


- Default settings:
 High Mode: 100% Output
 Low Mode: 10% Output


- Time Delay: 5 mins Cutoff: 1 hr Sensitivity: High Photocell: Disabled Continuous Dimming: Disabled

Three 1/2" apertures allow for field or factory installed 120-277V universal electronic pencil photocell.


COVERAGE PATTERN


USBD/L2

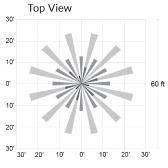

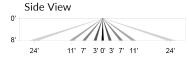


USBD/L3

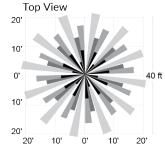

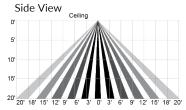


LINE DRAWINGS


2L & 3L Small Housing

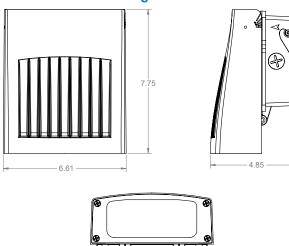


5L, 8L & 10L Large Housing

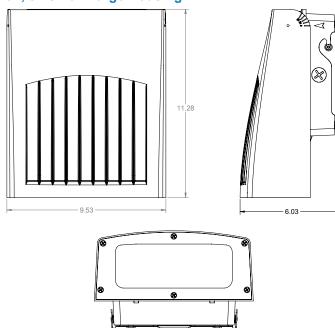

Large with Deep Box Cold Temp Battery Backup

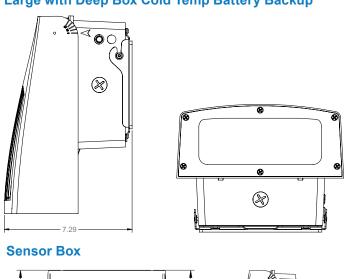

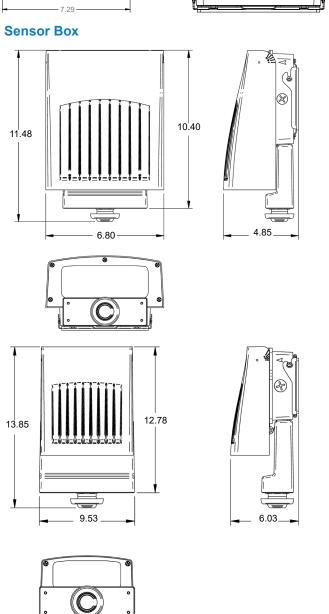

STUCCO BODY Sto - Sandstone, Medium Texture

ALUMINUM STOREFRONT WINDOWS
YKK - Dark Bronze Anodized




OVERHEAD DOORS



HOLLOW METAL DOORS
To Match Clopay - Brown

ROOFING, GUTTERS, DOWNSPOUTS & FASCIA Olympia Steel Buildings - Medium Bronze

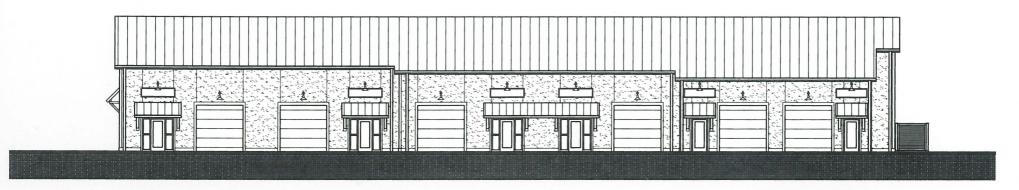


SPANISH WELLS OFFICE & WAREHOUSE BUILDING

PARCEL R510 007 000 0155 0000 SPANISH WELLS ROAD, HILTON HEAD ISLAND, SC 29926

PROPOSED EXTERIOR MATERIALS & COLORS February 22, 2022



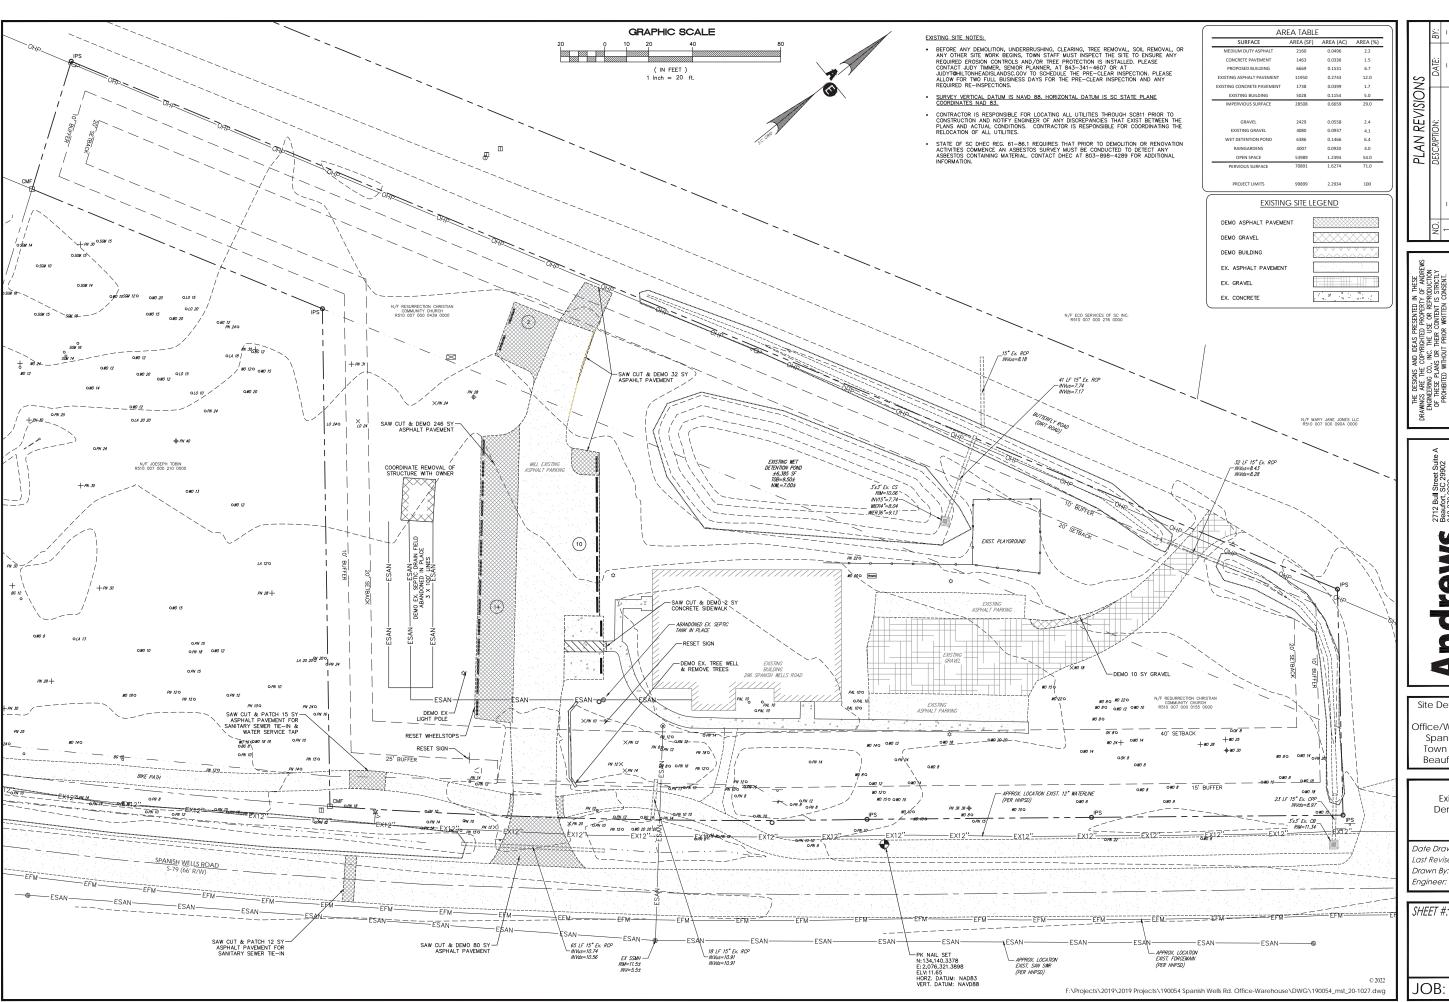





Andrews gassigner Sulpharent Sulpharent Sulpharent Sulpharent Scr 29902

Andrews gassigner Scr 29902

Example Find

Example Refind

Example Scr 29902

Example Scr 29


Site Development Plan for Office/Warehouse Space Spanish Wells Road Town of Hilton Head Beaufort County, SC

> Existing Site & Demolition Plan

Date Drawn: 01/30/20
Last Revised: 02/11/22

Drawn By: L. Wilen
Engineer: A. Klosterman

SHEET #: **1**JOB: 190054

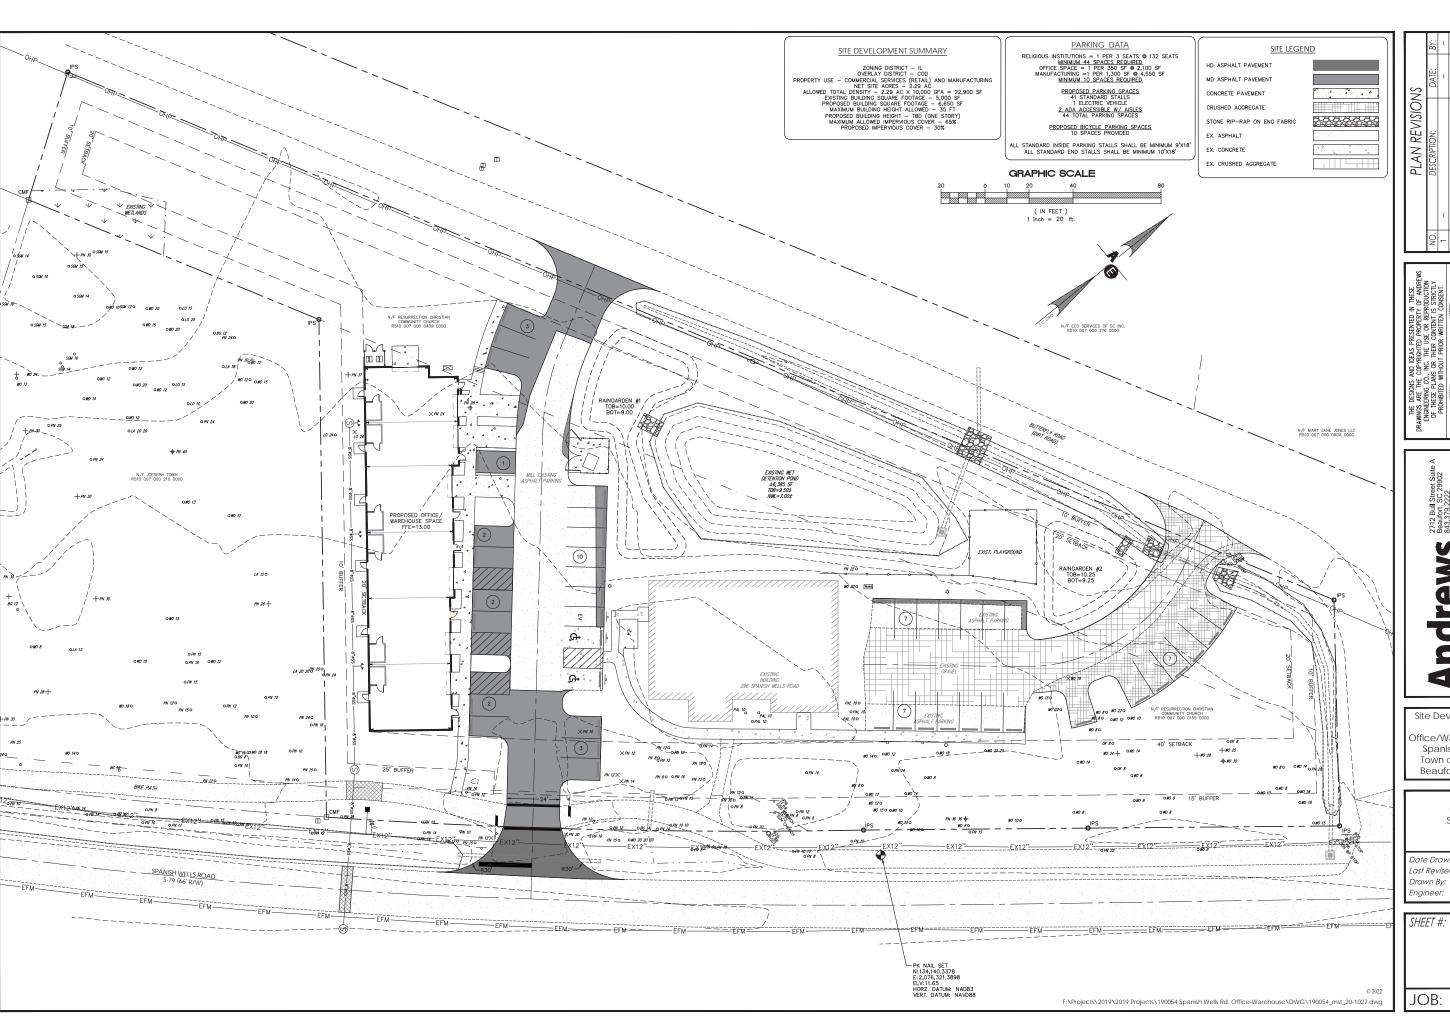





0 idrews Beauth SC 29902 843.379,2223 Mgineering & Surveying


Site Development Plan for Office/Warehouse Space Spanish Wells Road Town of Hilton Head Beaufort County, SC

> Overall Site Plan

Date Drawn: 01/30/20

Last Revised: 02/11/22 L. Wilen A. Klosterman

JOB: 190054

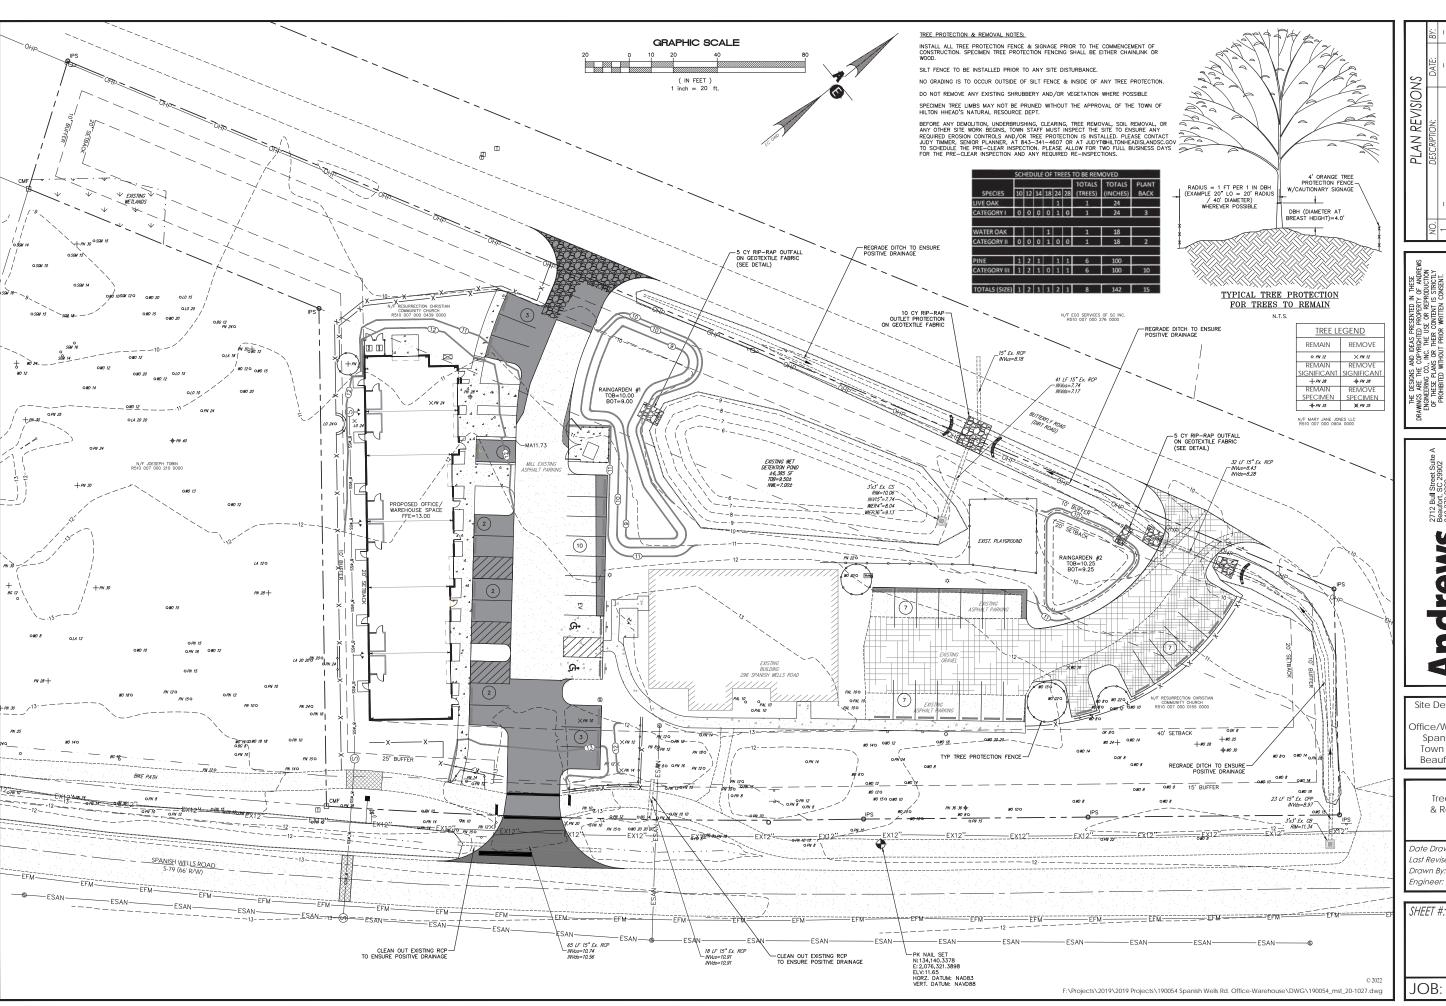





0 gineering


Site Development Plan for Office/Warehouse Space Spanish Wells Road Town of Hilton Head Beaufort County, SC

> Tree Protection & Removal Plan

Date Drawn: 01/30/20 Last Revised: 02/11/22 Drawn By: L. Wilen A. Klosterman

SHEET #:

JOB: 190054

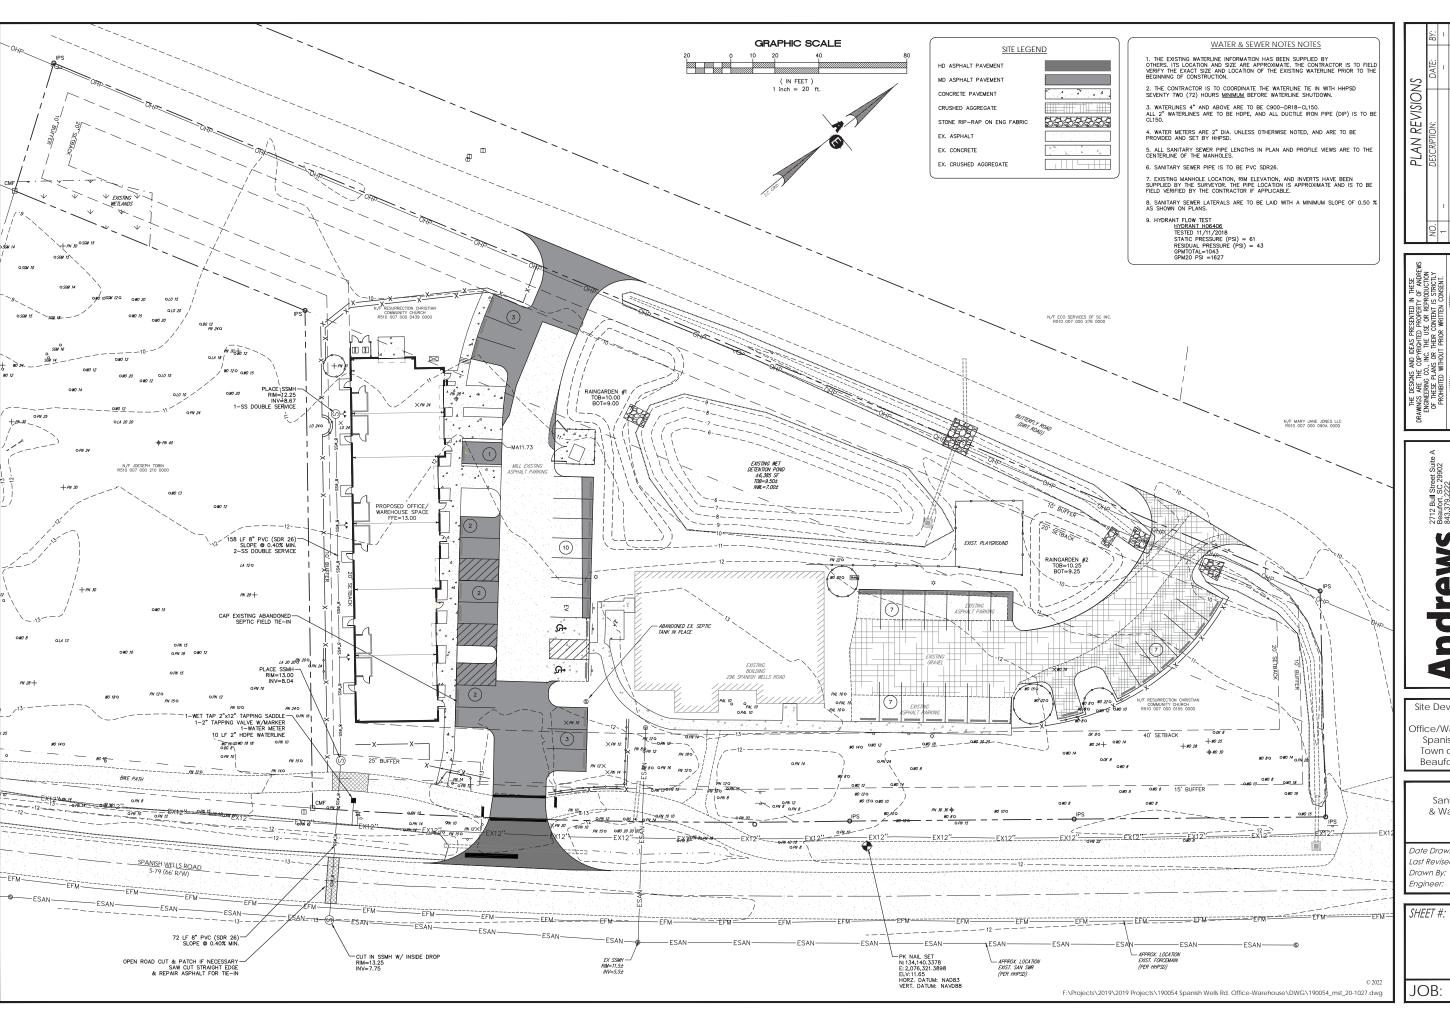





Andrews Beauty SC 29902
813.379,2223
Fax 843.379,2223

S Bandineering
8 Surveying

Site Development Plan for Office/Warehouse Space Spanish Wells Road Town of Hilton Head Beaufort County, SC

> Sanitary Sewer & Waterline Plan

 Date Drawn:
 01/30/20


 Last Revised:
 02/11/22

 Drawn By:
 L. Wilen

vn By: L. Wilen neer: A. Klosterman

7

3: 190054

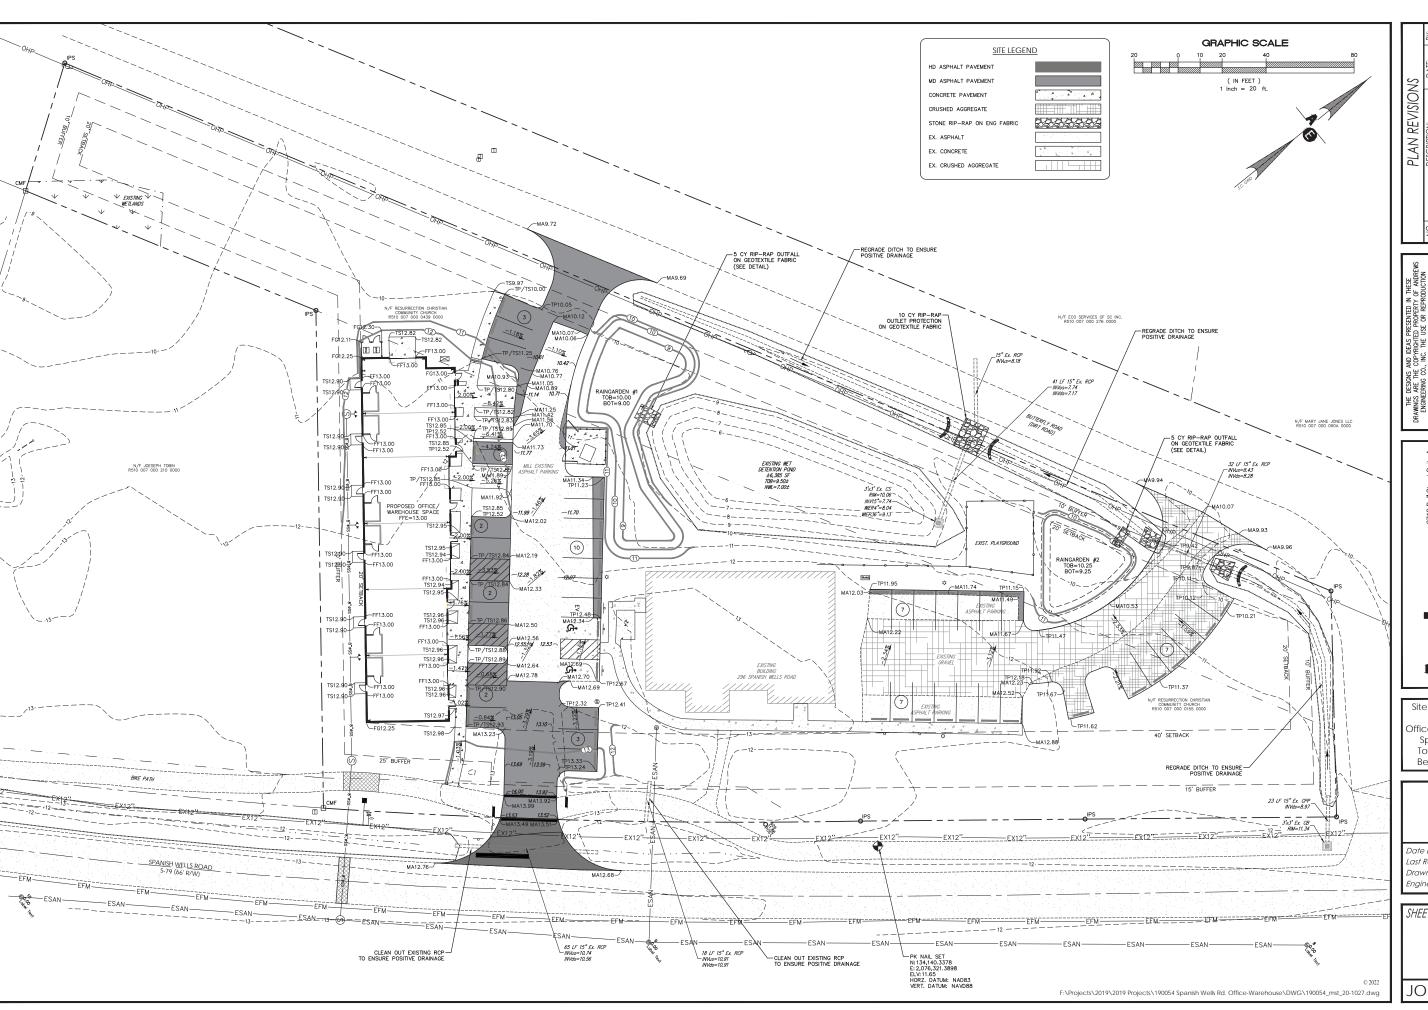






Site Development Plan for Office/Warehouse Space Spanish Wells Road Town of Hilton Head Beaufort County, SC

Grading Plan

Date Drawn: 01/30/20 Last Revised: 02/11/22

Drawn By: L. Wilen
Engineer: A. Klosterman

SHEET #: **8**JOB: 190054

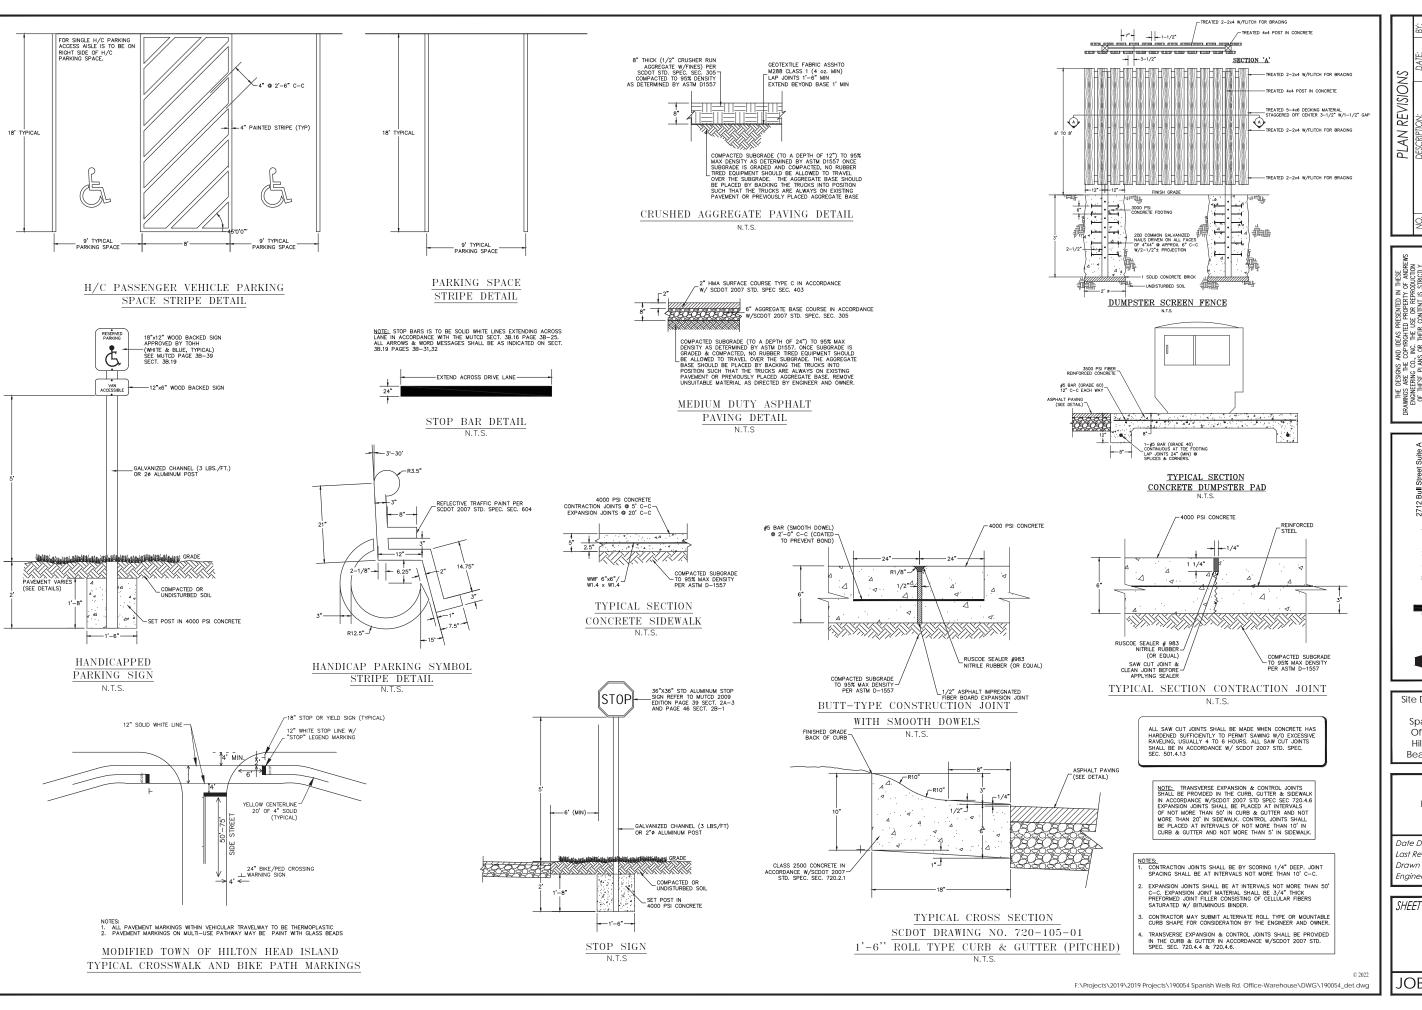



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Site Development Plan for


Spanish Wells Road Office/Warehouse Hilton Head Island Beaufort County, SC

Paving Details

Date Drawn: 01/30/20 Last Revised: 02/11/22 Drawn Bv: L. Wilen A. Klostermar Enaineer:

SHEET #:

JOB: 190054

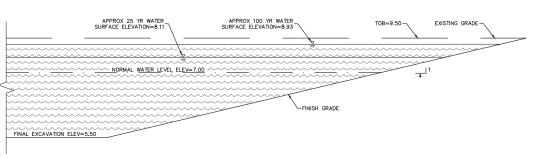

EXISTING WET DETENTION POND (TYPICAL CROSS SECTION)

-EXISTING GRADE

SIDE SLOPE

-STABILIZE W/RIP-RAP


-SPILLWAY ELEV=9.50

RAINGARDEN #1 RIP-RAP OVERFLOW SPILLWAY (TYPICAL SECTION)


N.T.S.

WET DETENTION POND MAINTENANCE PLAN:

- A. THE SIDE SLOPES OF THE POND SHALL BE MOWED MONTHLY.
- SINCE DECOMPOSING VEGETATION CAPTURED IN THE POND CAN RELEASE POLLUTANTS, ESPECIALLY NUTRIENTS, IT MAY BE NECESSARY TO HARVEST DEAD VEGETATION ANNUALLY. OTHERWISE THE DECAYING VEGETATION CAN EXPORT POLLUTANTS OUT OF THE POND AND ALSO CAN CAUSE NUISANCE CONDITIONS TO OCCUR.
- C. DEBRIS SHALL BE CLEARED FROM ALL INLET AND OUTLET STRUCTURES MONTHLY.
- D. ALL ERODED OR UNDERCUT AREAS SHALL BE REPAIRED AS NEEDED.
- E. A SEDIMENT MARKER SHALL BE PLACED IN THE FOREBAY(S) TO DETERMINE WHEN SEDIMENT REMOVAL IS REQUIRED.

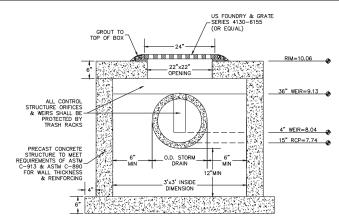

EXISTING CONTROL STRUCTURE (TYPICAL SECTION) N.T.S.

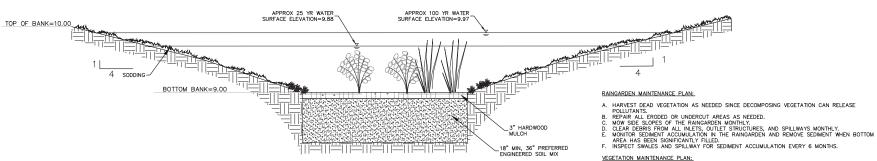

RAINGARDEN #1 (TYPICAL SECTION)


N.T.S.

A. HARVEST DEAD VEGETATION AS NEEDED SINCE DECOMPOSING VEGETATION CAN RELEASE

- A. INSPECT PLANTS AS NEEDED UNTIL THEY ARE ESTABLISHED. PROVIDE WATER DURING HOT, DRY SPELLS, ESPECIALLY DURING THE FIRST TWO YEARS.

 B. PRUNE, WEED, AND REMOVE ACCUMULATED TRASH MONTHLY. REPLACE MULCH AS NEEDED.

 C. INSPECT DETERNION AREA AND RIP—RAP SPILLWAY EVERY 6 MONTHS AND REMOVE ACCUMULATED SEDIMENT BUILD—UP AS NECESSARY. ADD VECETATION IN HEAVILY ERODED
- AREAS.
 D. REMOVE AND REPLACE MULCH EVERY TWO YEARS.

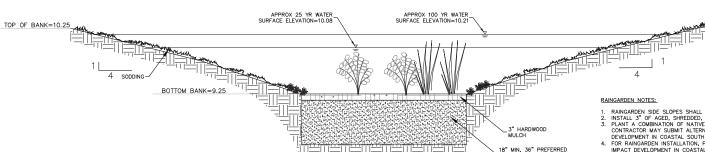

RAINGARDEN #2 (TYPICAL SECTION)

N.T.S.

SIDE SLOPE

- RAINGARDEN SIDE SLOPES SHALL NOT EXCEED 3:1.
 INSTALL 3" OF AGED, SHREDDED, HARDWOOD BARK MULCH ON BIGRETENTION BOTTOMS,
 PLANT A COMMENTATION OF NATIVE GRASSES AND SHRUBS. SEE PROJECT PLANTING PLAN.
 CONTRACTOR MAY SUBMIT ALTERNATE PLAN. SEE THE CLEMSON EXTENSION'S "LOW IMPACT
 DEVELOPMENT IN COASTAL SOUTH CARGUINA": A PLANNING AND DESIGN GUIDE" CHAPTER 4.2.
 FOR RAINGARDEN INSTALLATION, PLANTING, AND MAINTENANCE GUIDANCE, PLEASE SEE THE" LOW
 IMPACT DEVELOPMENT IN COASTAL SOUTH CARGUINA": A PLANNING AND DESIGN GUIDE" CHAPTER
 4.2.

-STABILIZE W/RIP-RAP

EXISTING GRADE

SIDE SLOPE

- 5. ENGINEERED SOIL MIX WILL ADHERE TO THE FOLLOWING:
 0. 40% SAND, 30% TOPSOIL, AND 30% COMPOST
 b. ORGANIC CONTENT MATTER FROM 8-10% BY WEIGHT
 C. LESS THAN 5% MINERAL FINES CONTENT (CLAY)
 d. 1.5 FOOT MINIMUM THICKNESS
 e. COMPACT TO 85% MAXIMUM DENSITY PER ASTM D 1557
 f. MINIMUM LONG—TERM HYDRAULIC CONDUCTIVITY OF 0.5 INCH/HOUR PER ASTM D2434.
 g. MAXIMUM IMMEDIATE HYDRAULIC CONDUCTIVITY OF 12 INCHES/HOUR.

SPILLWAY ELEV=10.00

RAINGARDEN #2 RIP-RAP OVERFLOW SPILLWAY (TYPICAL SECTION)

N.T.S.

6. ENGINEERED SOIL MAY BE OBTAINED OFF SITE OR CREATED BY TESTING NATIVE SOILS AND MIXING WITH IMPORTED MATERIALS AS NEEDED TO ACHIEVE SPECIFICATIONS. C. ENGINEERED SOIL SHOULD BE MIXED UNIFORMLY AND ITS CHARACTERISTICS SHOULD BE VERIFIED BY MATERIALS TESTING PRIOR TO PLACEMENT.

1. PLACE UNSATURATED SOIL IN 6 INCH LIFTS DO NOT PLACE IF SATURATED.

1. TO PRESERVE INFILITATION CAPACITY OF NATIVE SOIL, KEEP MACHINERY OUTSIDE OF GREEN OF ATTER PLACEMENT, COMPACT EACH LIFT OF SST MAXIMUM DENSITY USING WATER UNTIL JUST SATURATED OR BY WALKING ON THE SURFACE. DO NOT USE A VIBRATORY COMPACTOR.



GRASS SWALE (TYPICAL SECTION)


SIDE SLOPE

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F:\Projects\2019\2019 Projects\190054 Spanish Wells Rd. Office-Warehouse\DWG\190054_det.dwg

SIDE SLOPE

S R PLAN

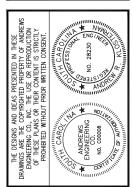

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Site Development Plan Spanish Wells Road Office/Warehouse Hilton Head Island Beaufort County, SC


Drainage Details

Date Drawn: 01/30/20 Last Revised: 02/11/22 Drawn Bv: L. Wilen A. Klostermar Enaineer:

SHEET #:

JOB: 190054

TOTAL THROUGH THE PROPERTY HAVE IN THE PROPERTY HAV

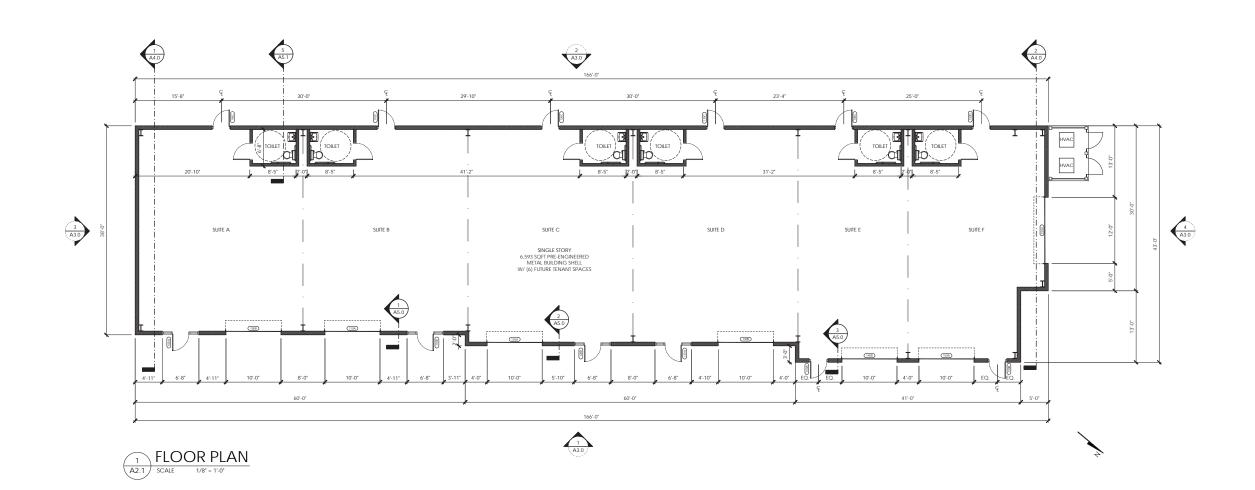



SPANISH WELLS OFFICE AND WAREHOUSE BUILDING

PARCEL R510 007 000 0155 0000 SPANISH WELLS RD. HILTON HEAD ISLAND, SC






ISSUE DATE DESCRIPTION

02/22/2022

FLOOR

PLAN

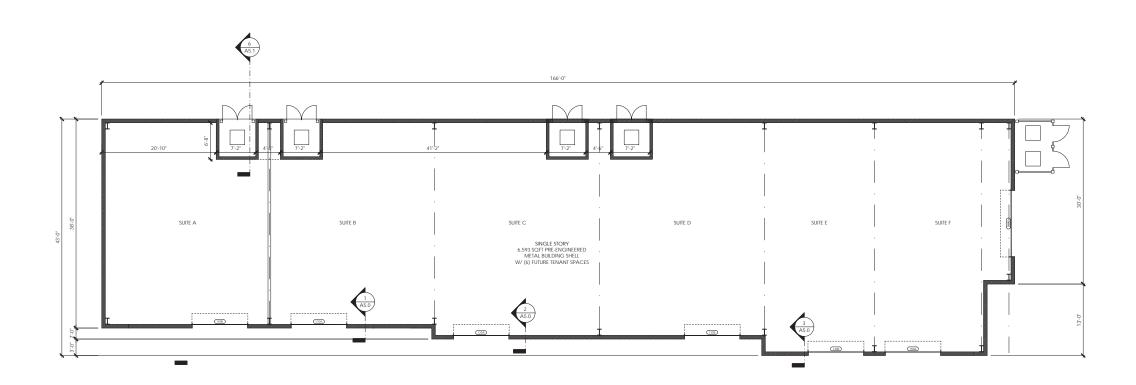





PARCEL R510 007 000 0155 0000 SPANISH WELLS RD. HILTON HEAD ISLAND, SC SPANISH WELLS OFFICE AND WAREHOUSE BUILDING




ISSUE DATE DESCRIPTION

PROJECT CONTACT :

HVAC PLAN

02/22/2022

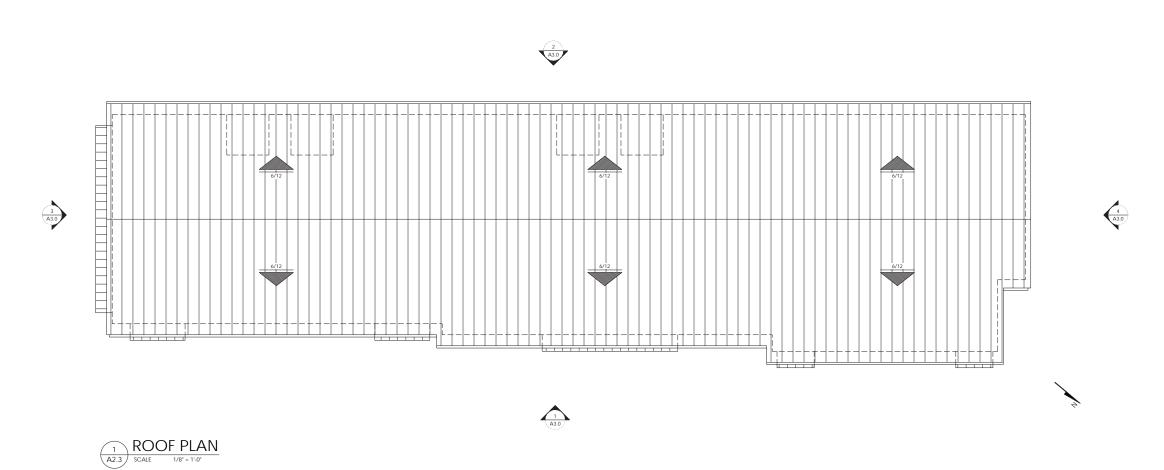




PARCEL R510 007 000 0155 0000 SPANISH WELLS RD. HILTON HEAD ISLAND, SC SPANISH WELLS OFFICE AND WAREHOUSE BUILDING




ISSUE DATE DESCRIPTION

PROJECT CONTACT : 02/22/2022

ROOF PLAN

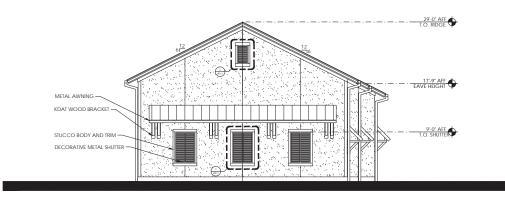

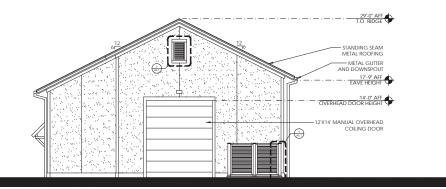

SPANISH WELLS ROAD ELEVATION (EAST) A3.0 SCALE 1/8" - 1'-0"

BUTTERFLY ROAD ELEVATION (WEST)

A3.0 SCALE 1/8" = 1'-0"



REAR ELEVATION (SOUTH) SCALE 1/8" = 1'-0"



PARKING LOT ELEVATION (NORTH) 1 A3.0 SCALE 1/8* = 1'-0*



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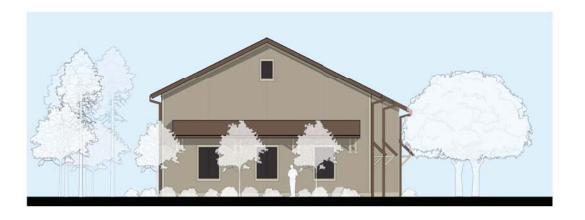
PARCEL R510 007 000 0155 0000 SPANISH WELLS RD. HILTON HEAD ISLAND, SC SPANISH WELLS OFFICE AND WAREHOUSE BUILDING




ISSUE DATE DESCRIPTION

PROJECT CONTACT : 02/22/2022

EXTERIOR ELEVATIONS



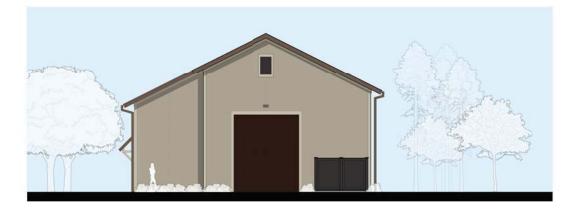

















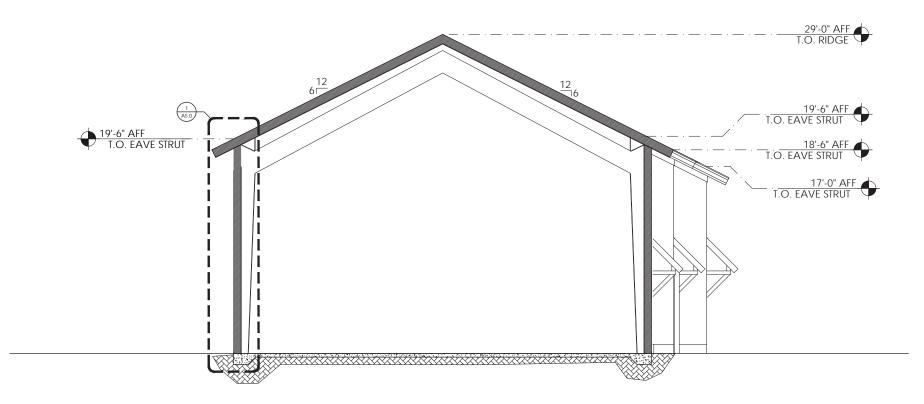



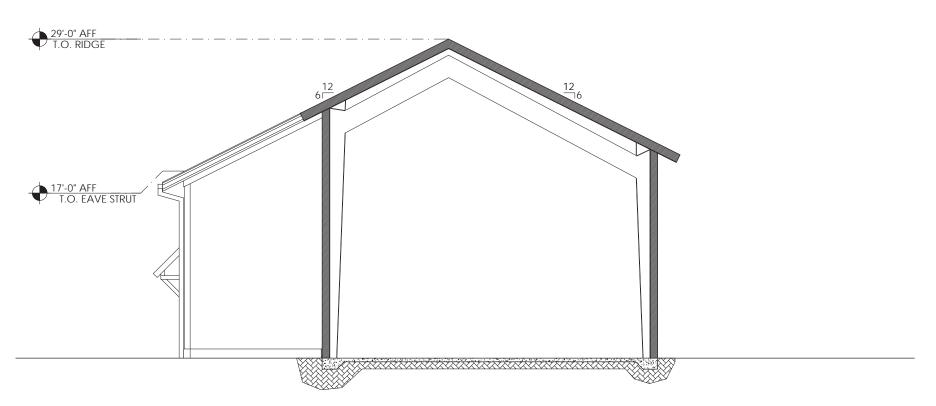





SPANISH WELLS OFFICE AND WAREHOUSE BUILDING

PARCEL R510 007 000 0155 0000 SPANISH WELLS RD. HILTON HEAD ISLAND, SC






ISSUE DATE DESCRIPTION

PROJECT CONTACT : 02/22/2022

BUILDING SECTIONS

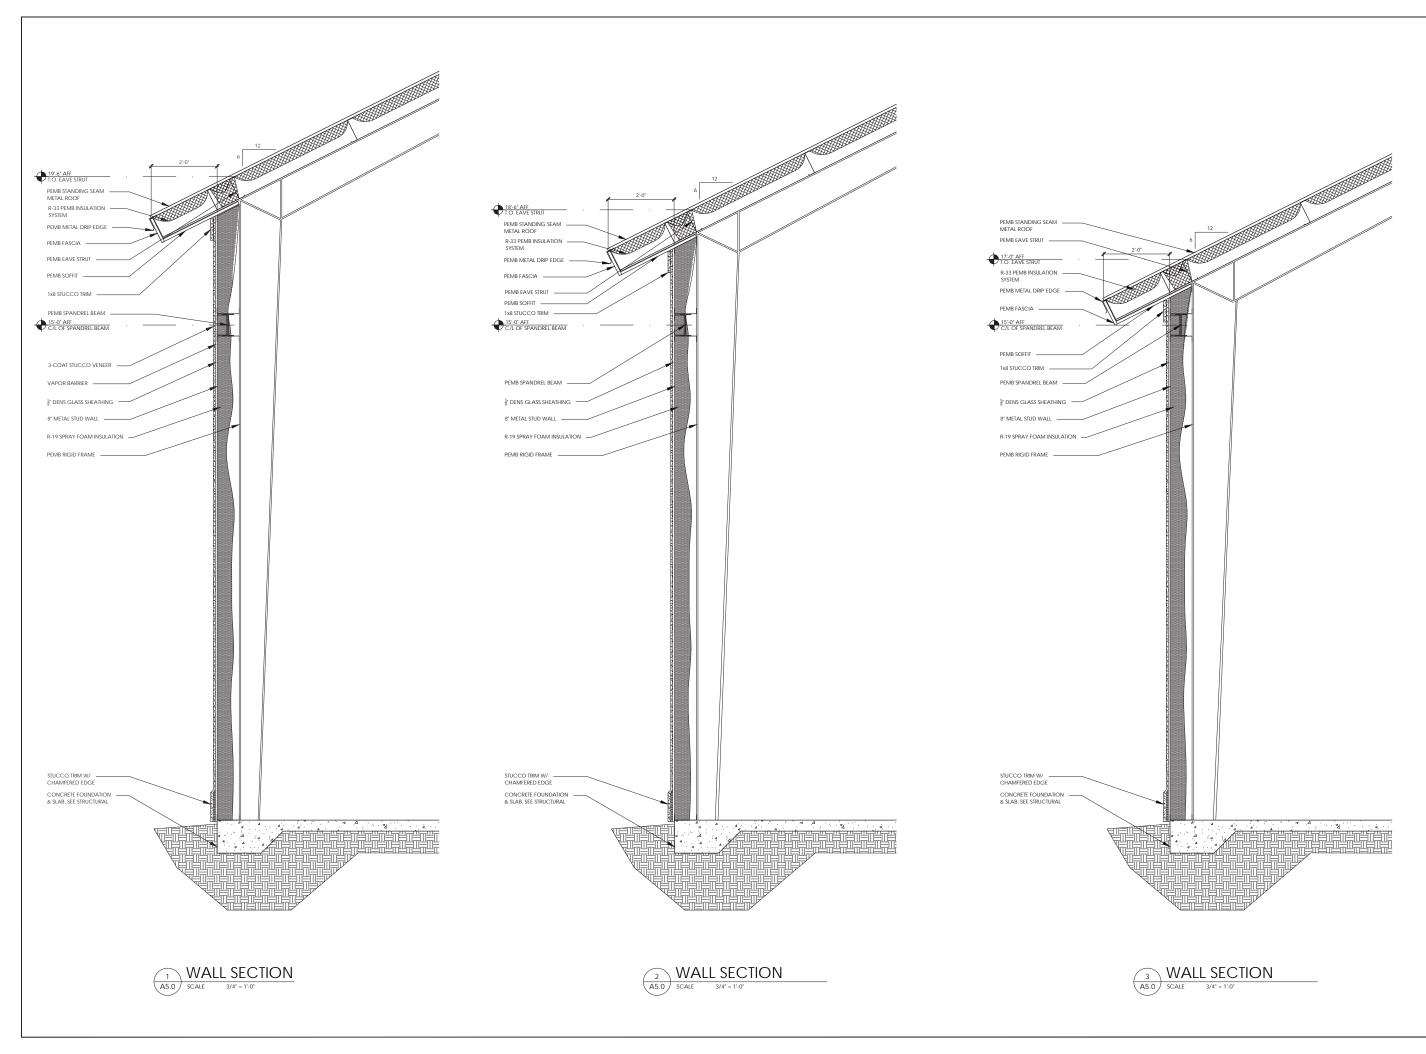



RD.

PARCEL R510 007 000 0155 0000 SPANISH WELLS HILTON HEAD ISLAND, SC SPANISH WELLS OFFICE AND WAREHOUSE BUILDING







ISSUE DATE DESCRIPTION

PROJECT # :


21-141 PROJECT CONTACT : DATE: 02/22/2022

> WALL SECTION

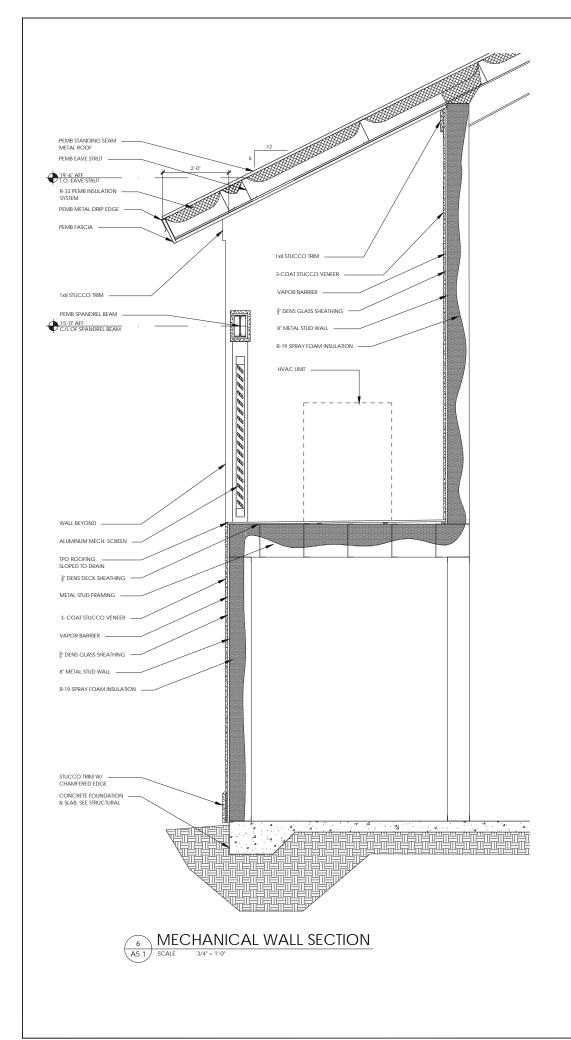


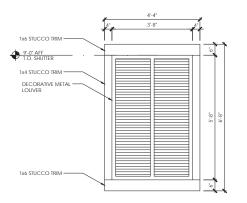


LOUVER TRIM DETAIL

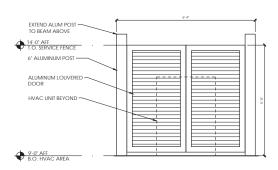


3 ALUMINUM MECHANICAL SCREEN
A5.1 SCALE 1/2" + 1'-0"

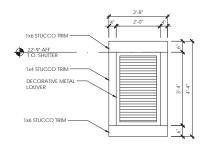


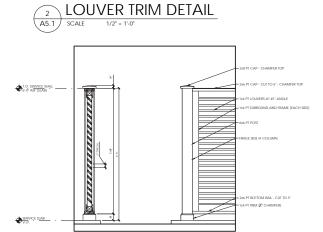

SERVICE YARD DETAIL

SCALE 1/2" - 1'-0'

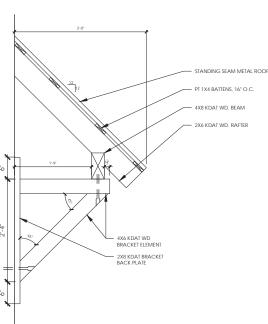

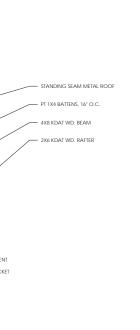

WOOD BRACKET DETAIL



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RD.

PARCEL R510 007 000 0155 0000 SPANISH WELLS HILTON HEAD ISLAND, SC SPANISH WELLS OFFICE AND WAREHOUSE BUILDING




ISSUE DATE DESCRIPTION


21-141


PROJECT CONTACT : DATE: 02/22/2022


DETAIL


000	OOR AND WINDOW SCHEDULE									НА	RDV	VAR	RE					
		SIZE		DC	OOR	FRA	FRAME DETAILS					PASSAGE SET	PULL	~	ОТО	LATES	JER NG	
DOOR NUMBER	w	н	Т	ELEVATION	MATERIAL	ELEVATION	MATERIAL	HEAD	JAMB	SILL/THRESH.	DESIGN PRESSURE	PASSA	PUSH / PULL	CLOSER	THRESHOLD	KICK PLATES	WEATHER STRIPPING	REMARKS
100A	6'-8"	7'-2½*		С	ALUM / GLASS		ALUM	3/A6.0	2/A6.0	1/A6.0				•	•		•	
100B	10'-0"	10'-0"		D	STL			6/A6.0	5/A6.0	4/A6.0								
100C	3'-0"	7'-0"		А	HM	1	НМ	7/A6.0	8/A6.0	9/A6.0				•	•	•	•	
110A	10'-0"	10'-0"		D	STL			6/A6.0	5/A6.0	4/A6.0								
110B	6'-8"	7'-2½*		С	ALUM / GLASS		ALUM	3/A6.0	2/A6.0	1/A6.0				•	•		•	
110C	3'-0"	7'-0"		А	НМ	1	НМ	7/A6.0	8/A6.0	9/A6.0				•	•	•	•	
120A	10'-0"	10'-0"		D	STL			6/A6.0	5/A6.0	4/A6.0								
120B	6'-8"	7'-2½'		С	ALUM / GLASS	-	ALUM	3/A6.0	2/A6.0	1/A6.0				•	•		•	
120C	3'-0"	7'-0"		А	НМ	1	НМ	7/A6.0	8/A6.0	9/A6.0				•	•	•	•	
130A	6'-8"	7'-2½*		С	ALUM / GLASS		ALUM	3/A6.0	2/A6.0	1/A6.0				•	•		•	
130B	10'-0"	10'-0"		D	STL			6/A6.0	5/A6.0	4/A6.0								
130C	3'-0"	7'-0"		А	HM	1	НМ	7/A6.0	8/A6.0	9/A6.0				•	•	•	•	
140A	3'-5"	7'-2½"		В	ALUM / GLASS	-	ALUM	3/A6.0	2/A6.0	1/A6.0				•	•		•	
140B	10'-0"	10'-0"		D	STL	-		6/A6.0	5/A6.0	4/A6.0								
140C	3'-0"	7'-0"		А	HM	1	НМ	7/A6.0	8/A6.0	9/A6.0				•	•	•	•	
150A	10'-0"	10'-0"		D	STL			6/A6.0	5/A6.0	4/A6.0								
150B	3'-5"	7'-21*		В	ALUM / GLASS	-	ALUM	3/A6.0	2/A6.0	1/A6.0				•	•		•	
150C	12'-0"	14'-0"		D	STL			6/A6.0	5/A6.0	4/A6.0								
150D	3'-0"	7'-0"		А	HM	1	HM	7/A6.0	8/A6.0	9/A6.0								

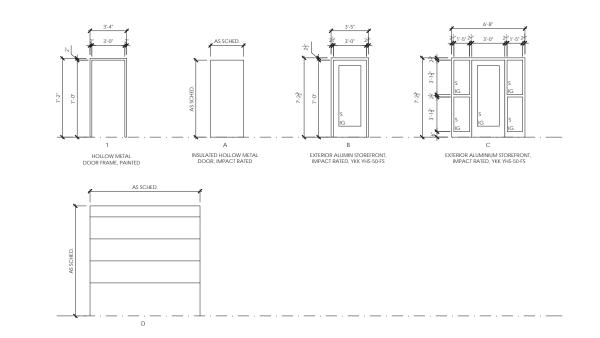

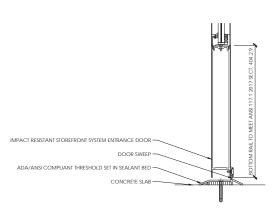

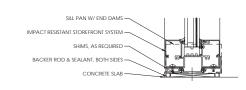


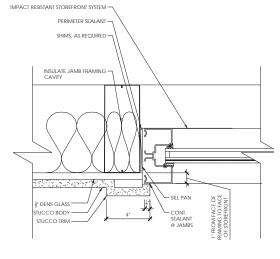

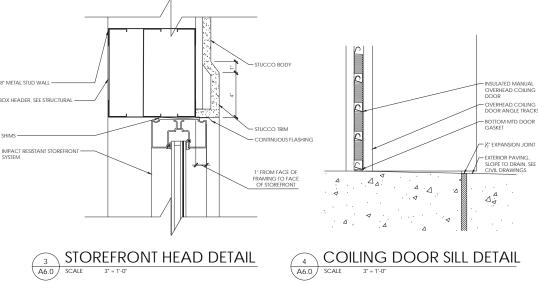

STOREFRONT BOTTOM RAIL DETAIL A6.0 SCALE 3"-1"-0"


OVERHEAD COILING DOOR ANGLE TRACKS

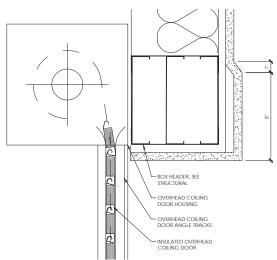



STOREFRONT SILL DETAIL

2 STOREFRONT JAMB DETAIL

2 SCALE 3° = 1'-0"

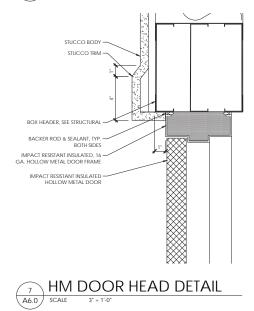

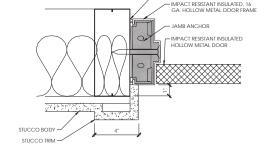

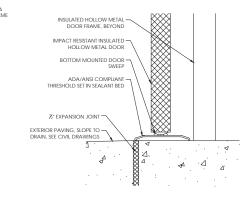

5 COILING DOOR JAMB DETAIL
SCALE 3" + 1'-0"

COILING DOOR HEAD DETAIL

6 A6.0 SCALE 3"-1".0"

8 HM DOOR JAMB DETAIL
A6.0) SCALE 3" = 1"-0"

9 HM DOOR SILL DETAIL
A6.0 SCALE 3" = 1'-0"



ged feet classified from



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ISSUE DATE DESCRIPTION

PROJECT # : 21-141
PROJECT CONTACT : JW
DATE: 02/22/2022

DOOR SCHEDULE

A6.0

DESIGN TEAM/DRB COMMENT SHEET

The comments below are staff recommendations to the Design Review Board (DRB) and do NOT constitute DRB approval or denial.

PROJECT NAME: Spanish Wells Office Warehouse Bldg. DRB#: DRB-000497-2022									
DATE: 02/23/2022									
RECOMMENDATION: Approval Approval with Conditions Denial RECOMMENDED CONDITIONS:									
ARCHITECTURAL DESIGN									
DESIGN GUIDE/LMO CRITERIA	Complies Yes	No	Not Applicable	Comments or Conditions					
All facades have equal design characteristics		\boxtimes		The rear façade appears to have random architectural detail.					
Has a strong roof form with enough variety to provide visual interest				Consider raising the roof of the center two units to add visual interest.					
Human scale is achieved by the use of proper proportions and architectural elements		\boxtimes		East elevations appear out of proportion. Windows are large and high for human scale. Awning appears high on the facade. Consider architectural detail of the second story.					
Decorative lighting is limited and low wattage and adds to the visual character		\boxtimes		Fixtures selected are available with 3000K or less temperature. Please add note on plan regarding temperature.					
LANDSCAPE DESIGN									
DESIGN GUIDE/LINO CRITERIA	Complies Yes	No	Not Applicable	Comments or Conditions					
Provides for a harmonious setting for the site's structures, parking areas or other construction				Add additional evergreen understory trees to the rear buffer to screen the building. Staff					

enclosure.

1. This project required DPR review. 2. Specify a spacing of the Spartina in the stormwater detention basins. 3. Specify a paint or finish for the dumpster enclosure. Staff recommends a darker color.



Town of Hilton Head Island

Community Development Department One Town Center Court

Hilton Head Island, SC 29928
Phone: 843-341-4757 Fax: 843-842-8908

www.hiltonheadislandsc.gov

FOR OFFICIAL USE ONLY
Date Received:
Accepted by:
DRB #:
Meeting Date:

Applicant/Agent Name: Thomas Hultgren	Company: Gator Nortl	hridge Partners,	LLLP
Mailing Address: 7850 NW 146th St. 4th Floor	City: Miami Lakes	State: <u>FL</u>	Zip: <u>33016</u>
Telephone: mobile: 786-316-9113 Fax: 305-948-6478 office: 305-949-9049	E-mail: <u>thultgren@gatori</u>	inv.com	
Project Name: Northridge Plaza Walkway Roof Renovation Project Name: Northridge Plaza Walkway Roof Renovation		Hilton Parkway	
Parcel Number [PIN]: R 5 1 1 0 0 8 0 0 0 0	0 2 5 4 0 0 0 0		
Zoning District: Community Commercial O	verlay District(s): <u>COD - RC</u>	OW Arterial	
CORRIDOR DE			
CORRIDOR RE	EVIEW, MAJOR		
DESIGN REVIEW BOARD (DRB)) SUBMITTAL RE	QUIREME	ENTS
Digital Submissions may be accepted via e-mail by calli	<u>ng 843-341-4757.</u>		
Project Category:			
Concept Approval – Proposed Development	X Alte	ration/Addition	
Final Approval – Proposed Development	Sign	I	
Submittal Requirements for <i>All</i> projects:			
N/A Private Architectural Review Board (ARB) Notice			
jurisdiction of an ARB, the applicant shall submit 2-103.I.4.b.iii.01. Submitting an application to the			
applicant.	The to meet this requires	nent is the <u>respo</u>	normity of the
\$100,000:12 - E C	¢175 Einel Annuell	D 1 D	1
\$\frac{100.00}{100.00}Filing Fee: Concept Approval-Proposed Developm Alterations/Additions \$100, Signs \$25; cash or ch		•	•
Titoriations/Tadditions \$100, Signs \$25, Cash of Ci	eek made payable to the		Titua Islana.
Additional Submittal Requirements:			
Concept Approval – Proposed Development	a aviating tong amonby and t	ha lagation of tw	ass masting the
A survey (1"=30' minimum scale) of property lines tree protection regulations of Sec. 16-6-104.C.2, a			
beaches.	na ir appirouoio, rocuiron or	. cordering stree	is, marsires and
A site analysis study to include specimen trees, ac		, wetlands, buffe	ers, setbacks,
views, orientation and other site features that may A draft written narrative describing the design into	•	and objectives ar	nd how it
reflects the site analysis results.	ant of the project, its godis d	ma objectives an	id now it
Context photographs of neighboring uses and arch			
Conceptual site plan (to scale) showing proposed l			
Conceptual sketches of primary exterior elevations	_	racter of the proj	oosea

Last Revised 01/21/15 1

Additional Submittal Requirements:	
Final Approval – Proposed Development X A final written narrative describing how the project co review guidelines of Sec. 16-3-106.F.3.	nforms with the conceptual approval and design
Final site development plan meeting the requirements of Final site lighting and landscaping plans meeting the result of Final floor plans and elevation drawings (1/8"=1'-0" meeting to adequate the colors with architectural sections and details to adequate the color board (11"x17" maximum) containing actual colors.	equirements of Appendix D: D-6.H and D-6.I. inimum scale) showing exterior building materials and ately describe the project.
elevations, and indicating the manufacturer's name and Any additional information requested by the Design Roscale model or color renderings, that the Board finds n	eview Board at the time of concept approval, such as
Additional Submittal Requirements:	
Alterations/Additions X All of the materials required for final approval of prop additional materials.	osed development as listed above, plus the following
X A survey (1"=30' minimum scale) of property lines, ex	isting topography and the location of trees meeting the fapplicable, location of bordering streets, marshes and
X Photographs of existing structure.	
Additional Submittal Requirements: Signs	
Accurate color rendering of sign showing dimensions,	type of lettering, materials and actual color samples.
For freestanding signs: Site plan (1"=30' minimum scale) showing location of and property lines Proposed landscaping plan.	sign in relation to buildings, parking, existing signs,
For wall signs: Photograph or drawing of the building depicting the proposed light Location, fixture type, and wattage of any proposed light	•
Note: All application items must be received by the deadline date in or	der to be reviewed by the DRB per LMO Appendix D: D-23.
A representative for each agenda item is strongly encouraged to atten	
Are there recorded private covenants and/or restriction the proposed request? If yes, a copy of the private cover this application. YES NO	
To the best of my knowledge, the information on this a factual, and complete. I hereby agree to abide by all conditions that I understand that such conditions shall appobligation transferable by sale.	tions of any approvals granted by the Town of Hilton
I further understand that in the event of a State of Emerge set forth in the Land Management Ordinance may be suspen	•
For Gator Northridge Partners, LLLP	
Thomas Hultgren - Project Manager SIGNATURE	2/21/22 DATE
SICINA LUKE	DATE

Last Revised 01/21/15 2



GATOR INVESTMENTS

7850 NW 146th St, 4th Floor Miami Lakes, FL 33016 (305) 949-9049 phone (305) 948-6478 fax

February 21st, 2022

<u>Project Narrative – Design Review Board (DRB) Submittal</u> Walkway Canopy Roof Renovation – Northridge Plaza

The intent of this project is to renovate the approximate 151 Squares (15,100 SF) of existing walkway canopy and its wooden "Cedar Shake" roof for the entirety of the Gator Northridge Partners, LLLP (Landlord) owned Northridge Plaza shopping center located at 435 William Hilton Parkway Suites A through Y, Hilton Head, SC 29926.

Landlord intends to remove and replace the canopy's 4x10x20 treated fascia board walkway as well as the "tongue & groove" 2x6 pine soffit. The Cedar Shake will be replaced with a natural slate Vermont Slate roofing system. Specifically, the Cupa 14 slate in dark grey per the provided spec sheets.

Existing lighting and landscaping will remain. Existing building elevations will remain the same. A sample of the Cupa 14 natural slate will be provided to the DRB for review and approval.

Please see the attached site plans & surveys, existing photos, and natural slate specs sheets for reference.


Sincerely,

Thomas Hultgren Project Manager

Thomas Hutty of

On behalf of Gator Northridge Partners, LLLP

cc: James A. Goldsmith William Goldsmith

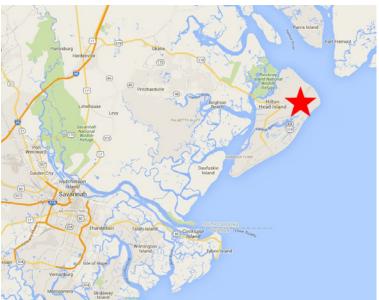

DEMOGRAPHICS


2021

435 William Hilton Parkway, Hilton Head, SC 29926

RADIUS	1 MILE	3 MILE	5 MILE
POPULATION	3,819	21,351	29,456
AVG. HH INCOME	\$99,157	\$128,318	\$145,107
AVG. AGE	42	53	53





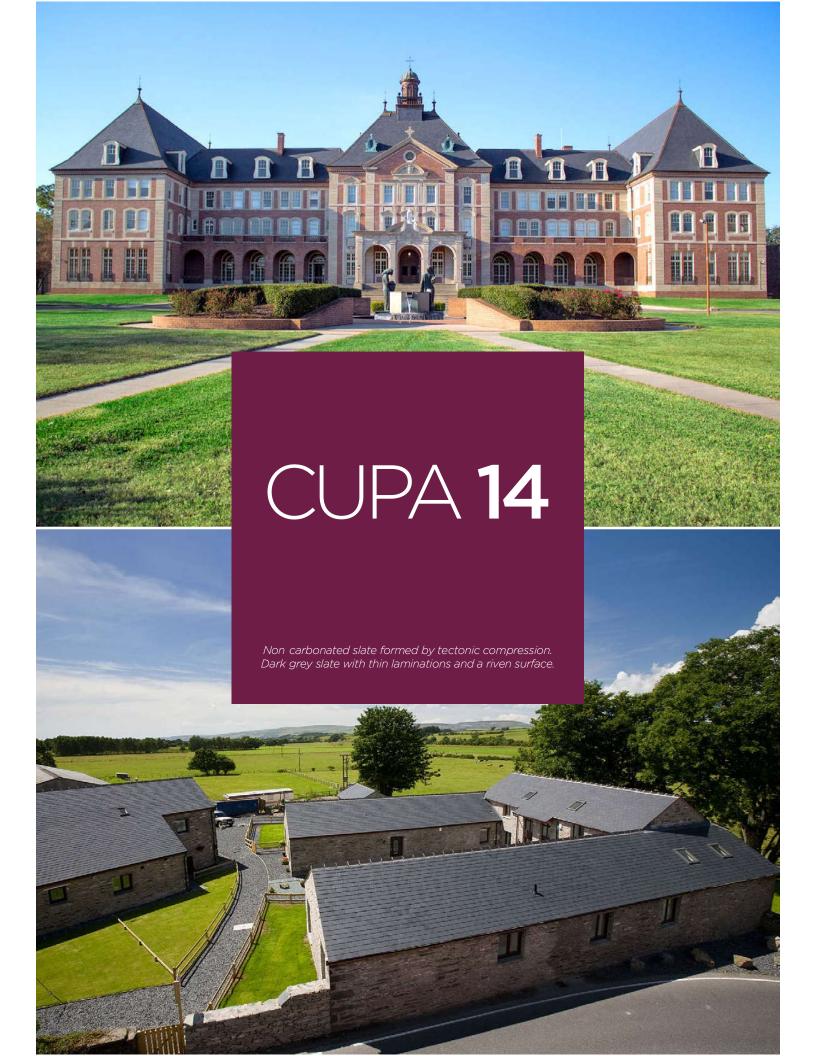



Quarry Las Fuentes. Benuza (León)



Operating since 1985.

Main sizes: 8"x6" to 24"x12"
Thickness: 3/16" to 3/8"



Formats



Rectangu a

Selections

EXCELLENCE

ARDOISIER

HEAVY

Technical specifications

ABSORPTION	CARBONATE NON CARBONATED	MOR CHARACTERISTIC	SO ₂ EXPOSURE TEST	THERMAL CYCLE TEST	FREEZE THAW TEST
0,21% Code : W1 (< 0,6%)	Complies (< 1,5%)	Longitudinal 43,5 MPA Transverse 45,7 MPA	S1	T1	Fulfill < 0,6%

International certifications















European Standard: EN 12326 | American Standard: ASTM C406-15



The world leader in natural slate

A Medua s/n - 32330 Sobradelo de Valdeorras - Ourense (Spain) T. +34 988 335 410, info@cupapizarras.com, www.cupapizarras.com









Imagery @2022 Google, Imagery @2022 Maxar Technologies, U.S. Geological Survey, Map data @2022 50 ft

Google Maps



Imagery ©2022 Google, Imagery ©2022 Maxar Technologies, Map data ©2022 20 ft

Google Maps Hilton Head Island, South Carolina



Google Maps Hilton Head Island, South Carolina



image capture. Jan 2019 @ 2022 000



Google Maps Hilton Head Island, South Carolina



Google Maps Hilton Head Island, South Carolina





Google Maps Hilton Head Island, South Carolina



Google
Street View - Jan 2019

Google Maps Hilton Head Island, South Carolina



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Street View - Jan 2019



Google Maps Hilton Head Island, South Carolina












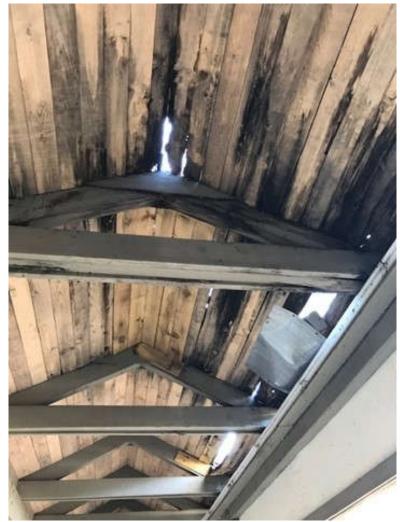

























DEMOGRAPHICS


2021


435 William Hilton Parkway, Hilton Head, SC 29926

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AVG. HH INCOME	\$99,157	\$128,318	\$145,107
AVG. AGE	42	53	53





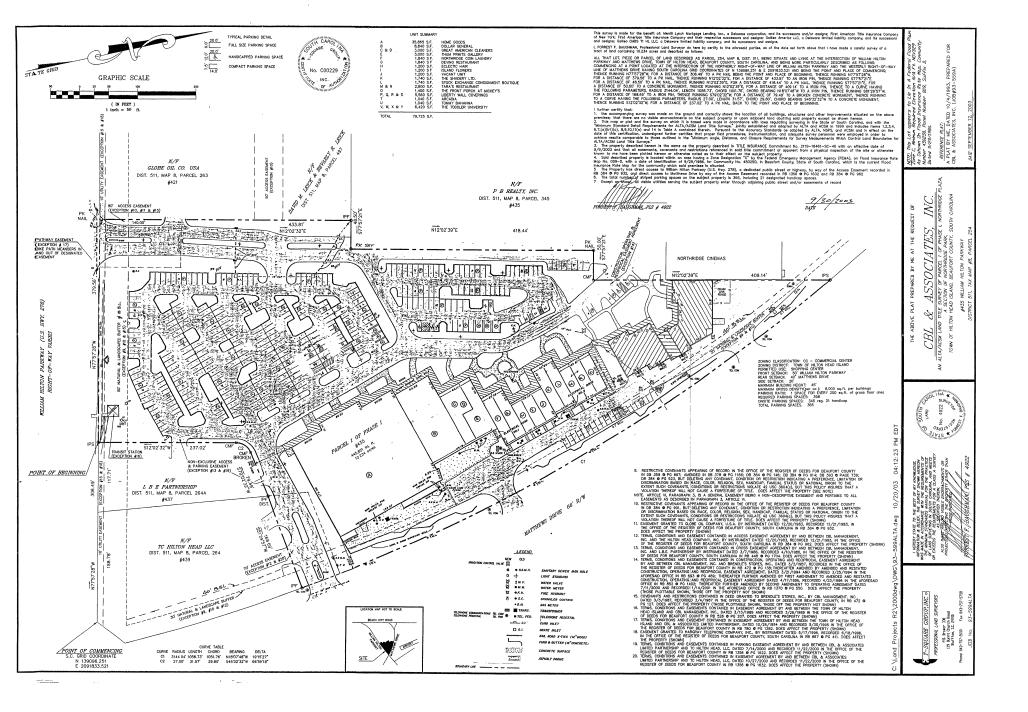

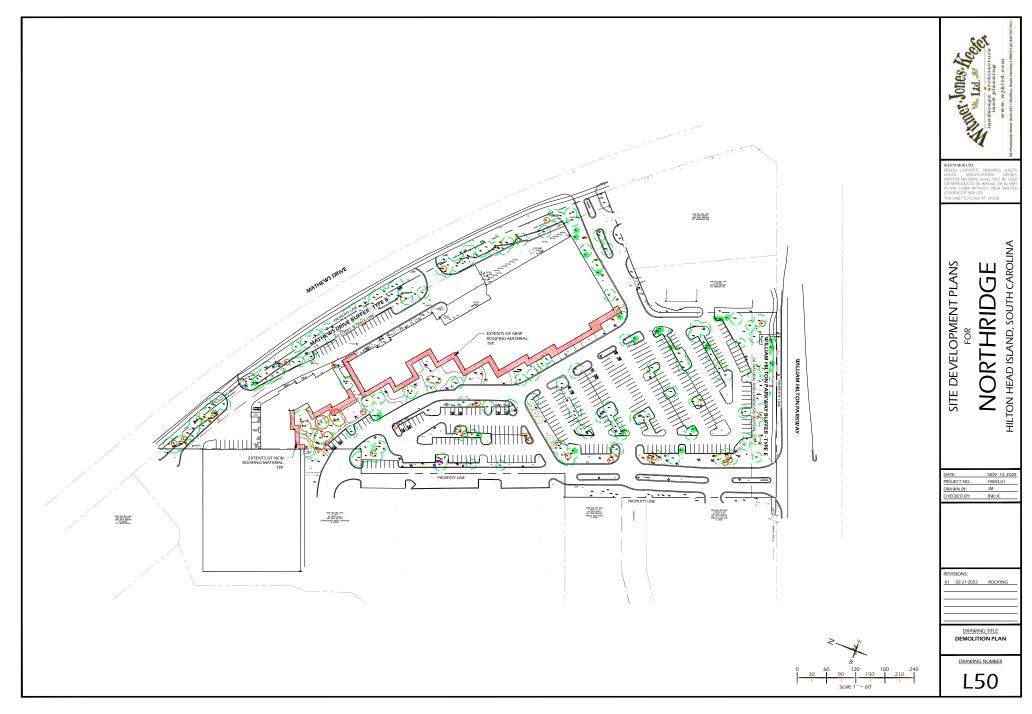



Imagery @2022 Google, Imagery @2022 Maxar Technologies, U.S. Geological Survey, Map data @2022 50 ft

Google Maps



Imagery ©2022 Google, Imagery ©2022 Maxar Technologies, Map data ©2022 20 ft

Google Maps Hilton Head Island, South Carolina



Google Maps Hilton Head Island, South Carolina



image capture. Jan 2019 @ 2022 000



Google Maps Hilton Head Island, South Carolina



Google Maps Hilton Head Island, South Carolina





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Street View - Jan 2019

Google Maps Hilton Head Island, South Carolina



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Street View - Jan 2019



Google Maps Hilton Head Island, South Carolina





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Image capture: Jan 2019 © 2022 Google






























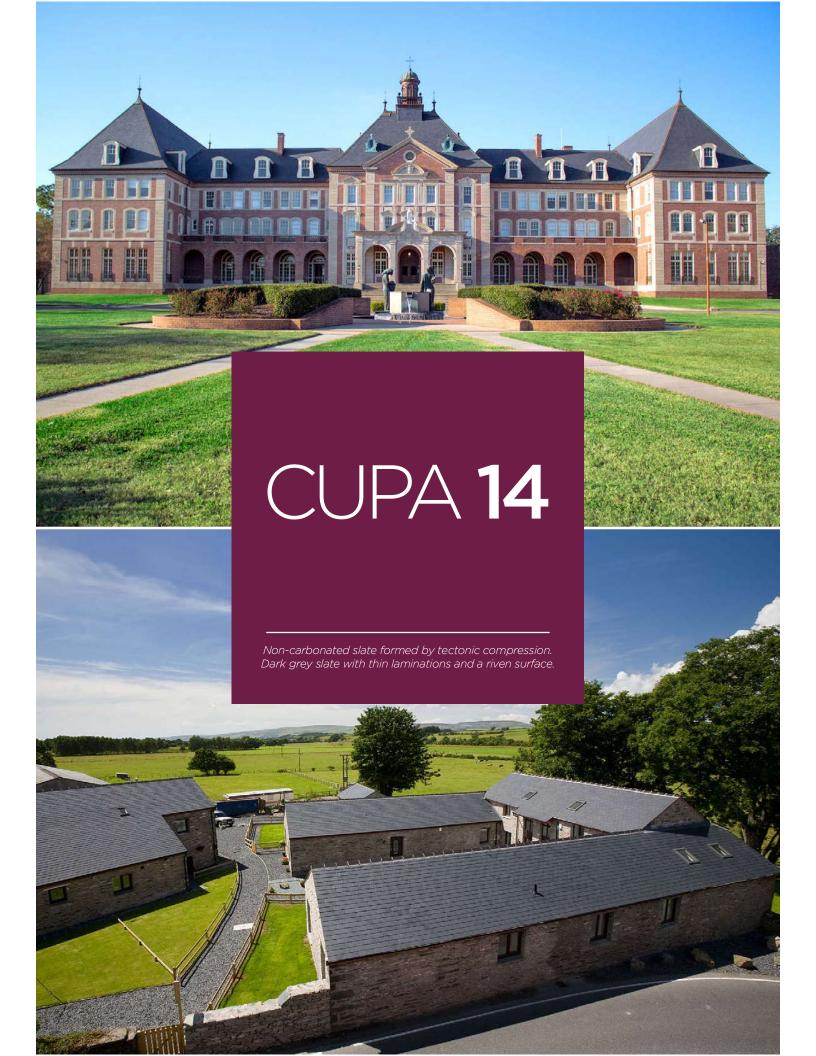



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Formats



Rectangular

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DESIGN TEAM/DRB COMMENT SHEET

The comments below are staff recommendations to the Design Review Board (DRB) and do NOT constitute DRB approval or denial.

PROJECT NAME: Northridge Walkway Ca	nopy		DRB	#: DRB-000485-2022
DATE: 02/03/2022				
RECOMMENDATION: Approval RECOMMENDED CONDITIONS:	Approval	with C	onditions	Denial 🔀
APPLICATION MATERIAL				
DRB REQUIREMENTS	Complies Yes	No	Not Applicable	Comments or Conditions
New Building Details Match Existing Building Details				The walkway roof of the Cinema is not proposed to be replaced. Please note the Cinema building is under different ownership.
ARCHITECTURAL DESIGN				
DESIGN GUIDE/LMO CRITERIA	Complies Yes	No	Not Applicable	Comments or Conditions
Utilizes natural materials and colors		\boxtimes		Design Guide, page 15, "Generally materials common to the area or historically present should be selected." Slate is not a roofing material "common" to a sea island.
MISC COMMENTS/QUESTIONS				
Staff is motivated to see Northridge renovations proceed	but they must co	mply wit	h the Design Guide. St	aff would suggest the applicant consider a standing

seam metal roof. That material is and has been commonly used as a roofing on Hilton Head.



Town of Hilton Head Island

Community Development Department One Town Center Court

Hilton Head Island, SC 29928 Phone: 843-341-4757 Fax: 843-842-8908

www.hiltonheadislandsc.gov

FOR OFFICIAL USE ONLY
Date Received:
Accepted by:
DRB #:
Meeting Date:

Applicant/Agent Name: David Thompson	Company: David Thompson Architect
Mailing Address: 704 Meeting Street	City: Charleston State: SC Zip: 29403
Telephone: <u>843-297-8939</u> Fax:	E-mail: dthompson@dthompsonarchitect.com
Project Name: Lucky Beach Bar + Kitchen	Project Address: 14 Folly Field RD, Hilton Head, SC 29928
Parcel Number [PIN]: R ₅ 1 1 0 0 9 0 0 0 Zoning District: RD- Resort Development	1 0 0 0 0 0 0 0 0 O Overlay District(s): RD Zoning District
	REVIEW, MAJOR RB) SUBMITTAL REQUIREMENTS
Digital Submissions may be accepted via e-mail by co	alling 843-341-4757.
Project Category: Concept Approval – Proposed Development Final Approval – Proposed Development	Addition Sign
Submittal Requirements for All projects:	
jurisdiction of an ARB, the applicant shall sub	tice of Action (if applicable): When a project is within the mit such ARB's written notice of action per LMO Section 16-the ARB to meet this requirement is the <u>responsibility of the</u>
7	opment \$175, Final Approval – Proposed Development \$175, r check made payable to the Town of Hilton Head Island.
tree protection regulations of Sec. 16-6-104.C.2 beaches. A site analysis study to include specimen trees, views, orientation and other site features that magnetic analysis results. Context photographs of neighboring uses and a Conceptual site plan (to scale) showing proposes.	intent of the project, its goals and objectives and how it rchitectural styles. ed location of new structures, parking areas and landscaping. ions showing architectural character of the proposed

Last Revised 01/21/15 1

	-
review guidelines of Sec. 16-3-106.F.3. Final site development plan meeting the reception of the reception	eeting the requirements of Appendix D: D-6.H and D-6.I. /8"=1'-0" minimum scale) showing exterior building materials and ls to adequately describe the project. ing actual color samples of all exterior finishes, keyed to the
additional materials. A survey (1"=30' minimum scale) of proper	oval of proposed development as listed above, plus the following rty lines, existing topography and the location of trees meeting the I.C.2, and if applicable, location of bordering streets, marshes and
For freestanding signs:	
A representative for each agenda item is strongly encourd Are there recorded private covenants and/or 1	ne date in order to be reviewed by the DRB per LMO Appendix D: D-23. aged to attend the meeting. restrictions that are contrary to, conflict with, or prohibit vate covenants and/or restrictions must be submitted with
To the best of my knowledge, the information factual, and complete. I hereby agree to abide by Head Island. I understand that such conditions obligation transferable by sale.	on this application and all additional documentation is true all conditions of any approvals granted by the Town of Hiltons shall apply to the subject property only and are a right of Emergency due to a Disaster, the review and approval times by be suspended.
SIGNATURE	February 22, 2022 DATE

Last Revised 01/21/15 2



February 22, 2022

RE: Lucky Beach Bar + Kitchen – Alterations to 14 Folly Field Rd

To: Mr. Chris Darnell, Hilton Head DRB

The goals of this alteration are as follows;

- 1. Enhance the architectural value of the existing building by adding wood siding to the two existing vertical elements at the West Porch and North Entry.
- 2. Improve connectivity and visibility from inside to outside by increasing the amount of glazing and doors.
- 3. Animate the exterior by increasing outdoor dining opportunities and providing activity areas such as a fire pit and gaming opportunities.
- 4. Improve the pedestrian experience and public views through landscape design, lighting and furnishings.

The scope of exterior work includes the following;

- Construct a new service window porch on the East Parking lot façade for to-go orders, curb service and bar service to the patio.
- Construct a new dining porch on the North façade
- Increase outdoor dining areas with pervious surfaces on the North East corner including a fire pit
- Modify and supplement existing landscaping
- Modify windows on the East and North sides
- Add overhead doors and increased storefront area on the West façade to engage the bar patio
- Enclose the existing entry vestibule using aluminum storefront and add a wood framed awning to the front door
- Signage design will follow under separate submittal



DAVID THOMPSON ARCHITECT, LLC CHARLESTON SC / 843-297-8939



ISSUED DATE / REVISIONS SD - 11.12.2021 DRB SUBMITTAL - 12.21.2021 DRB SUBMITTAL - 02.22.2022







VIEW FROM PARKING LOT















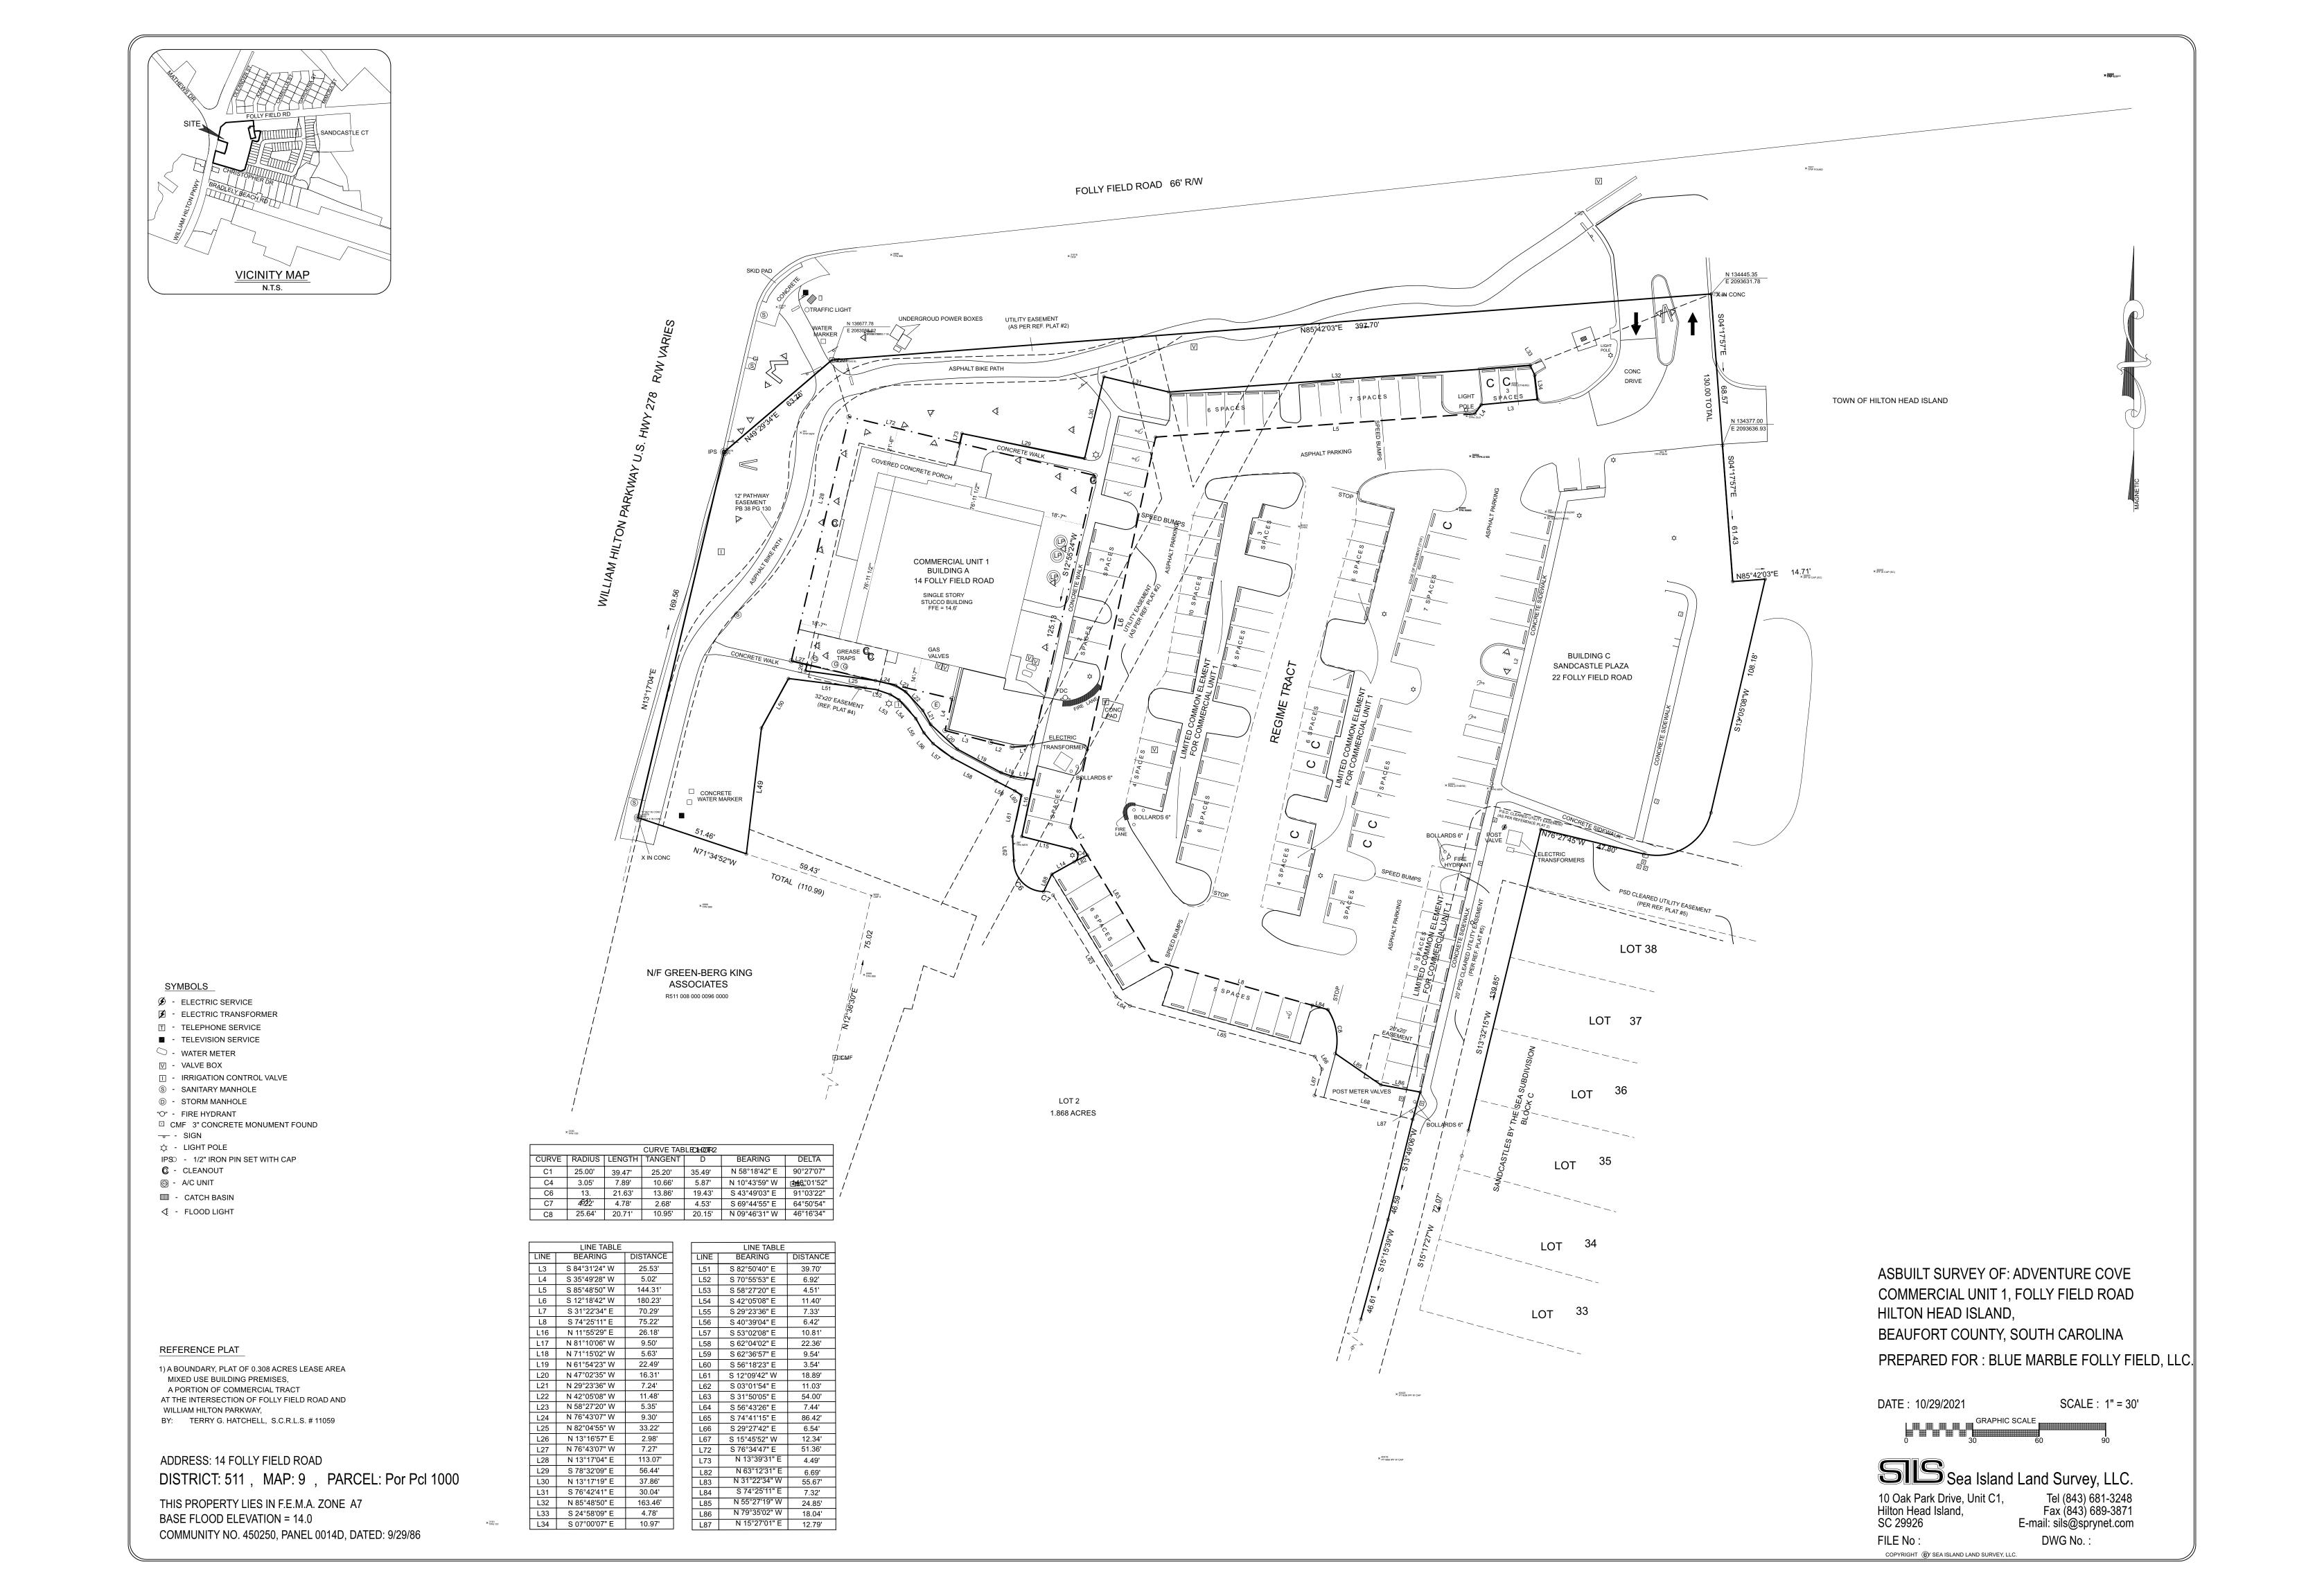

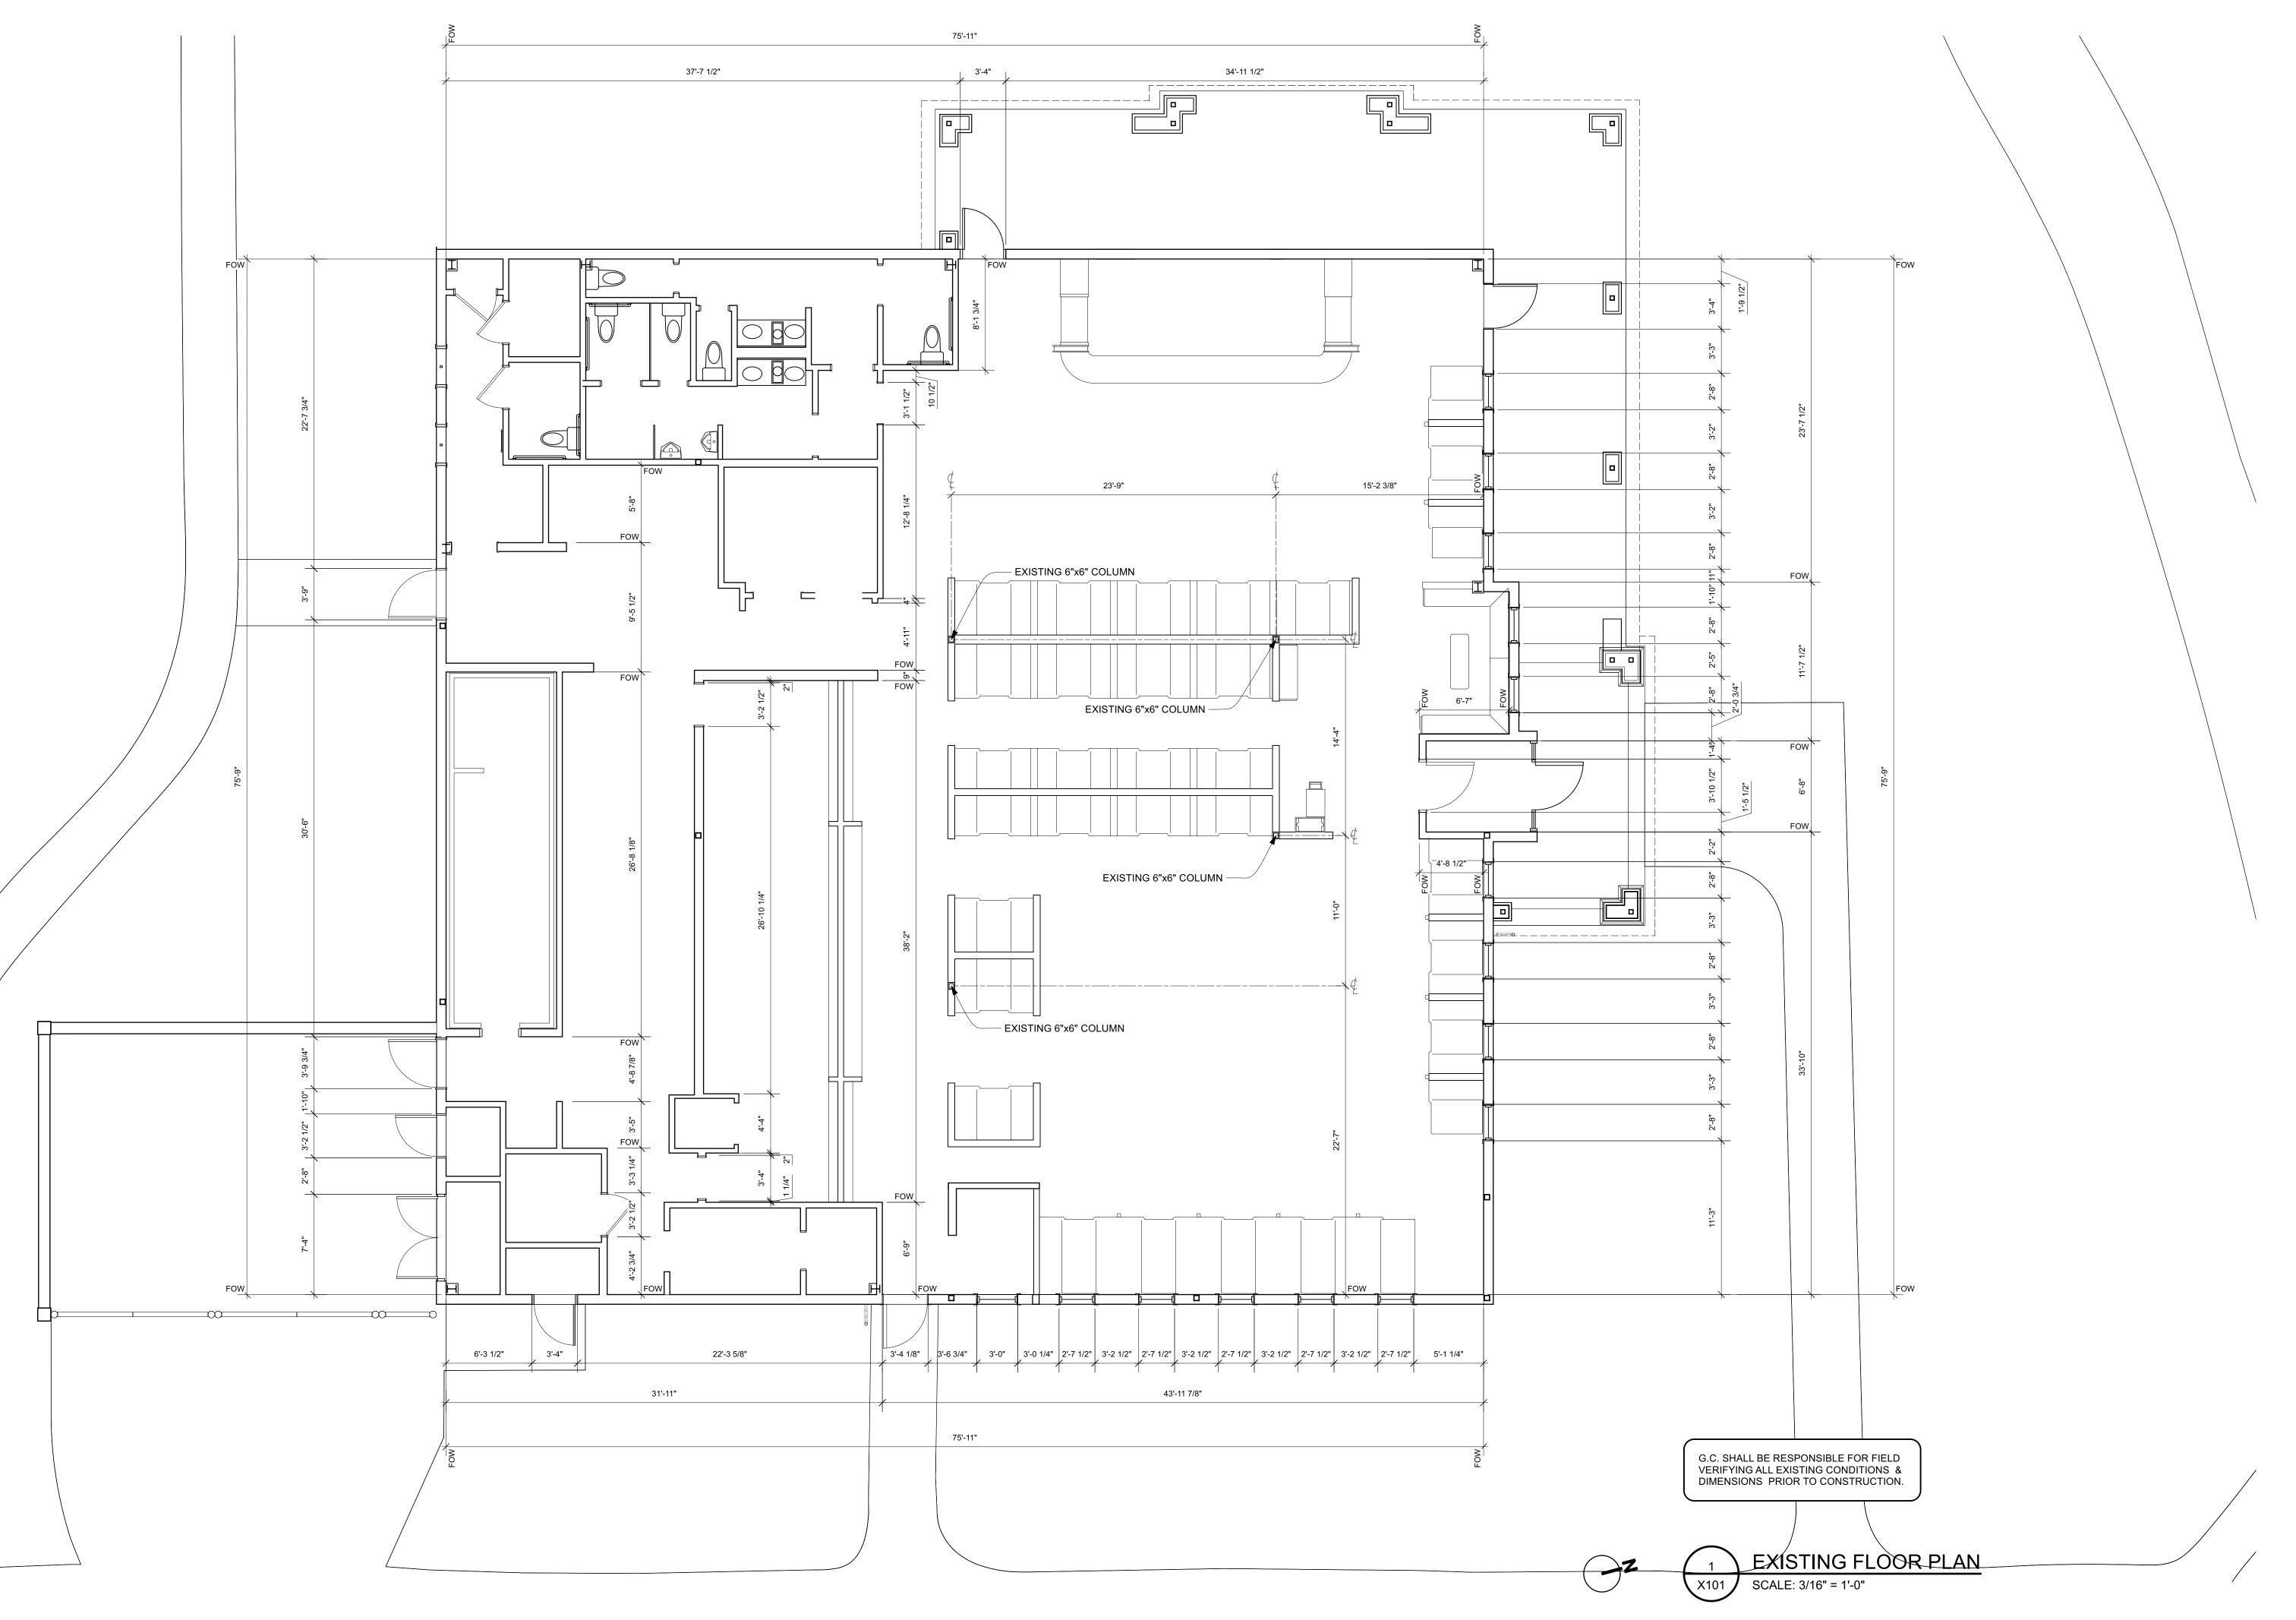



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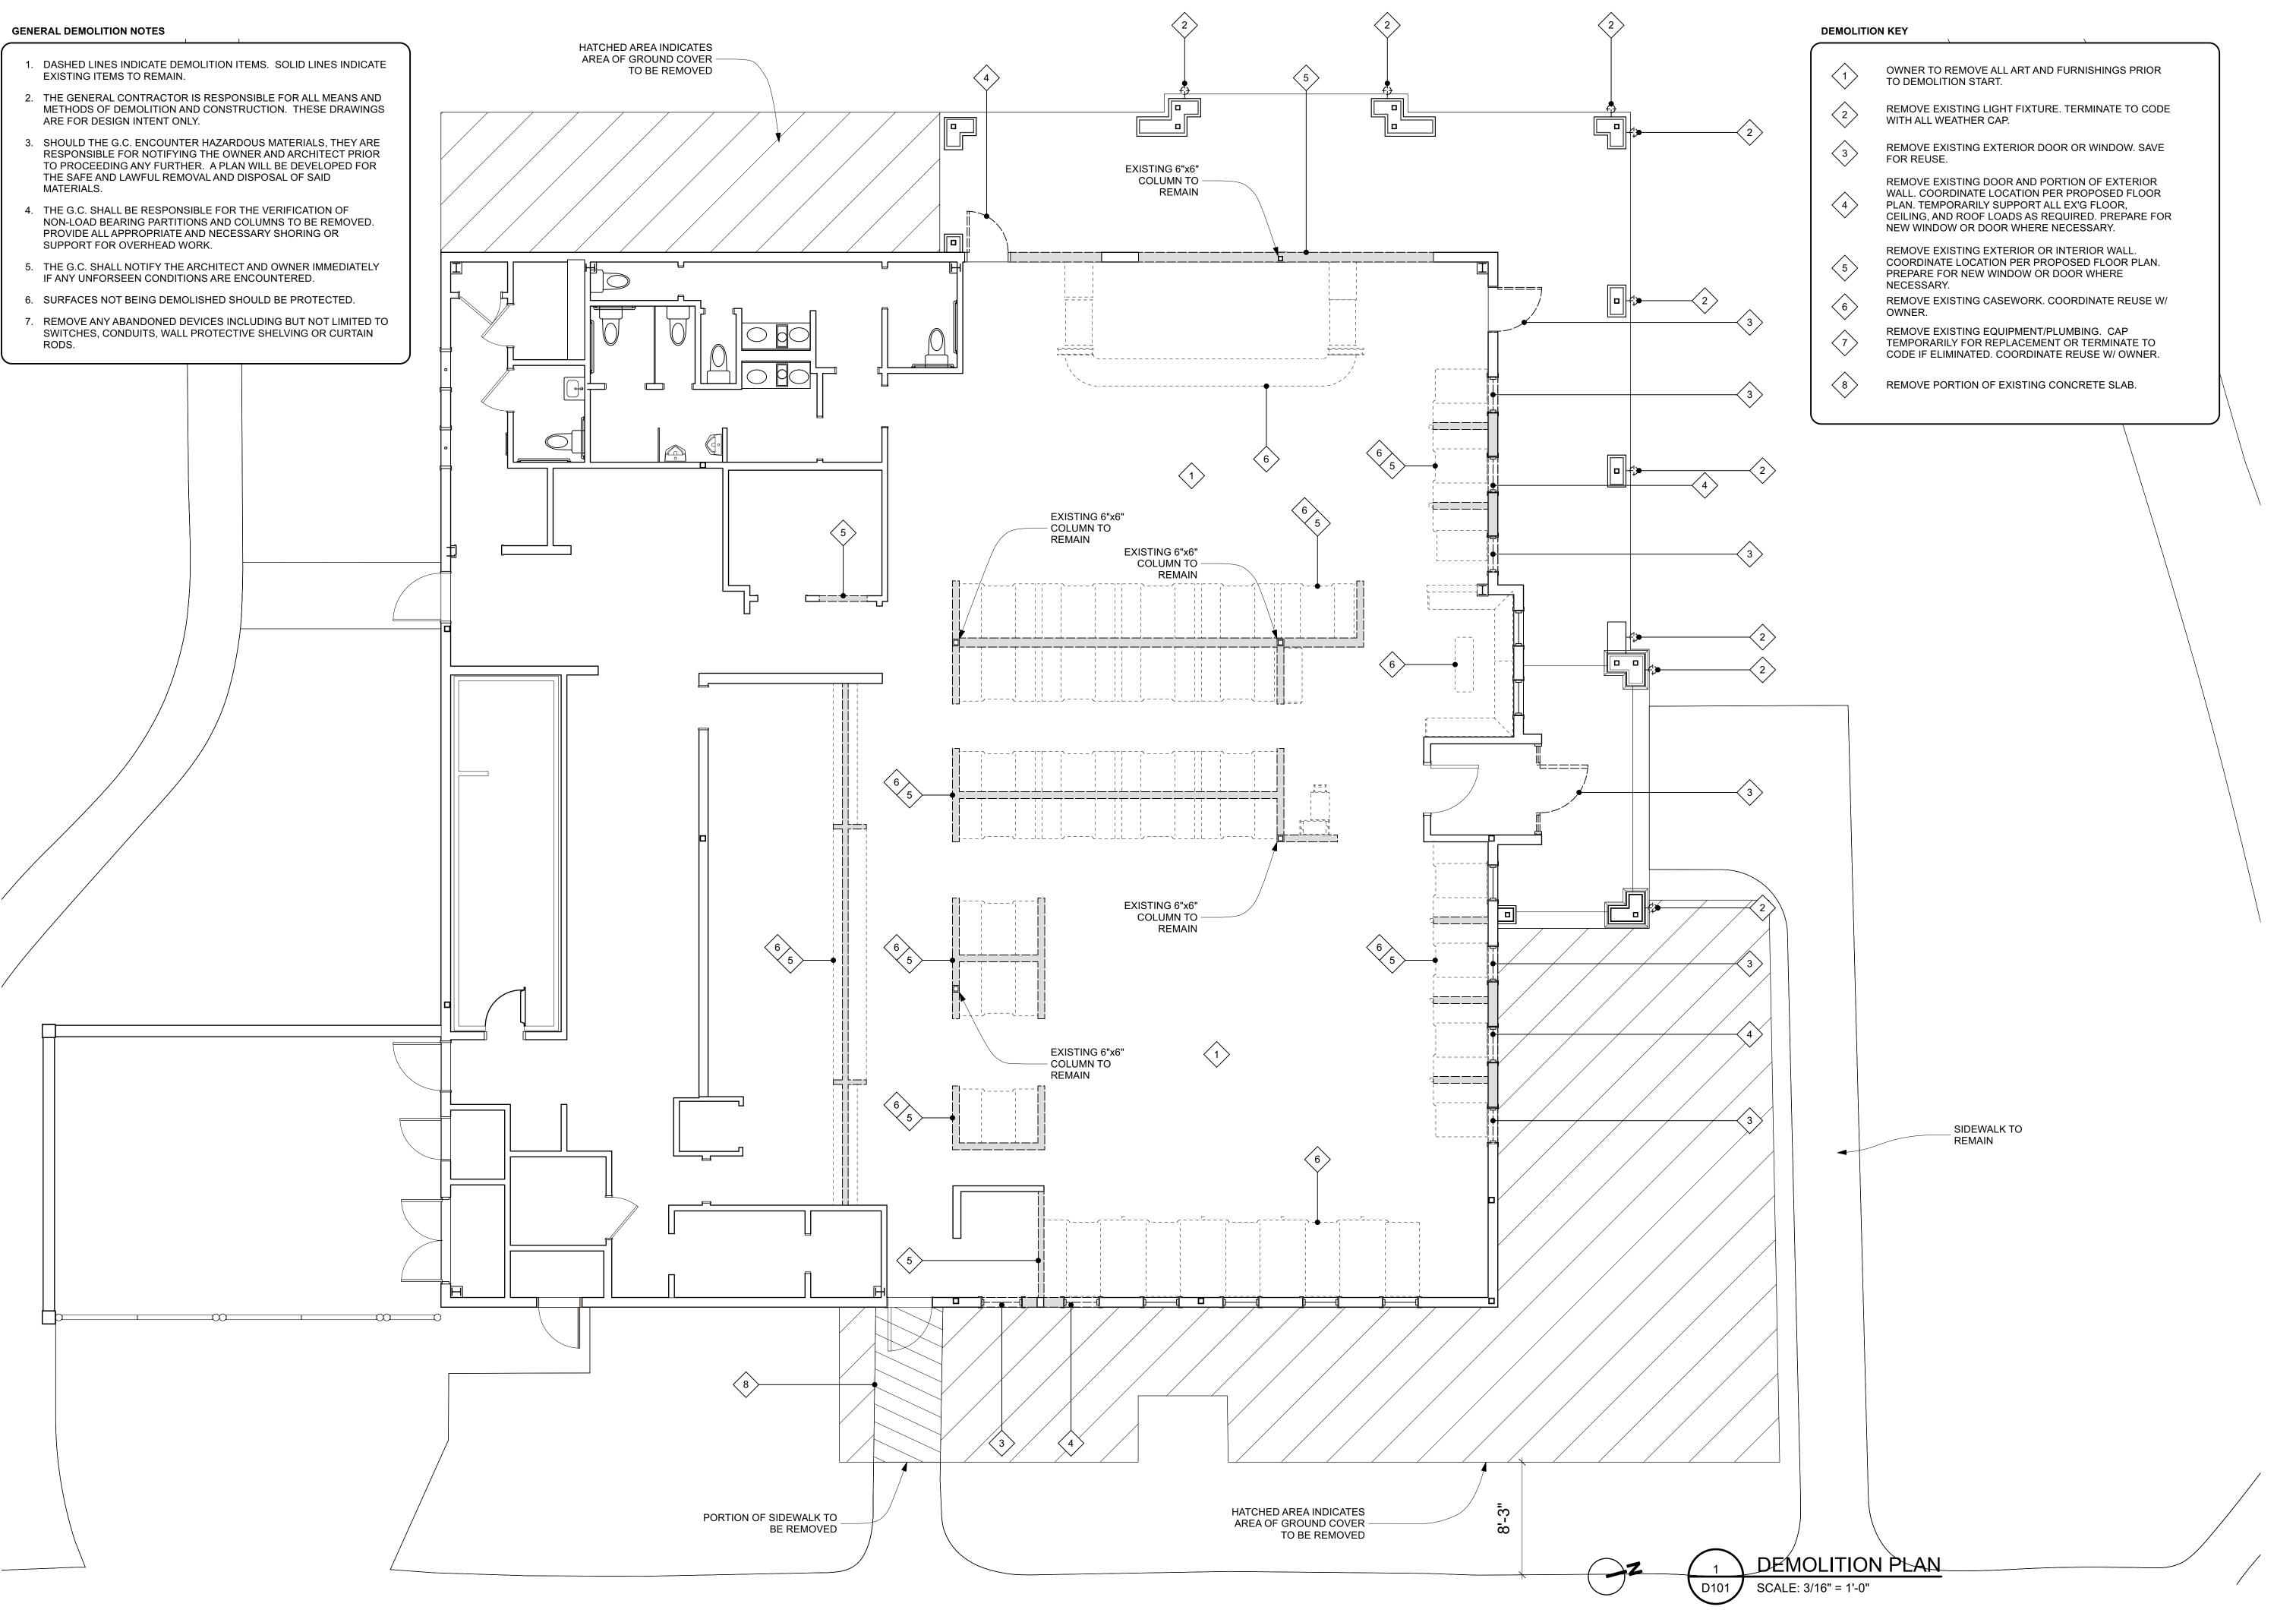
ISSUED DATE / REVISIONS

SD - 11.12.2021 DRB SUBMITTAL - 12.21.2021 DRB SUBMITTAL - 02.22.2022

> ACH BAR + KITCHEN FOLLY FIELD RD,

14 FOLLY FIELD RD, HILTON HEAD, SC 2992

X101





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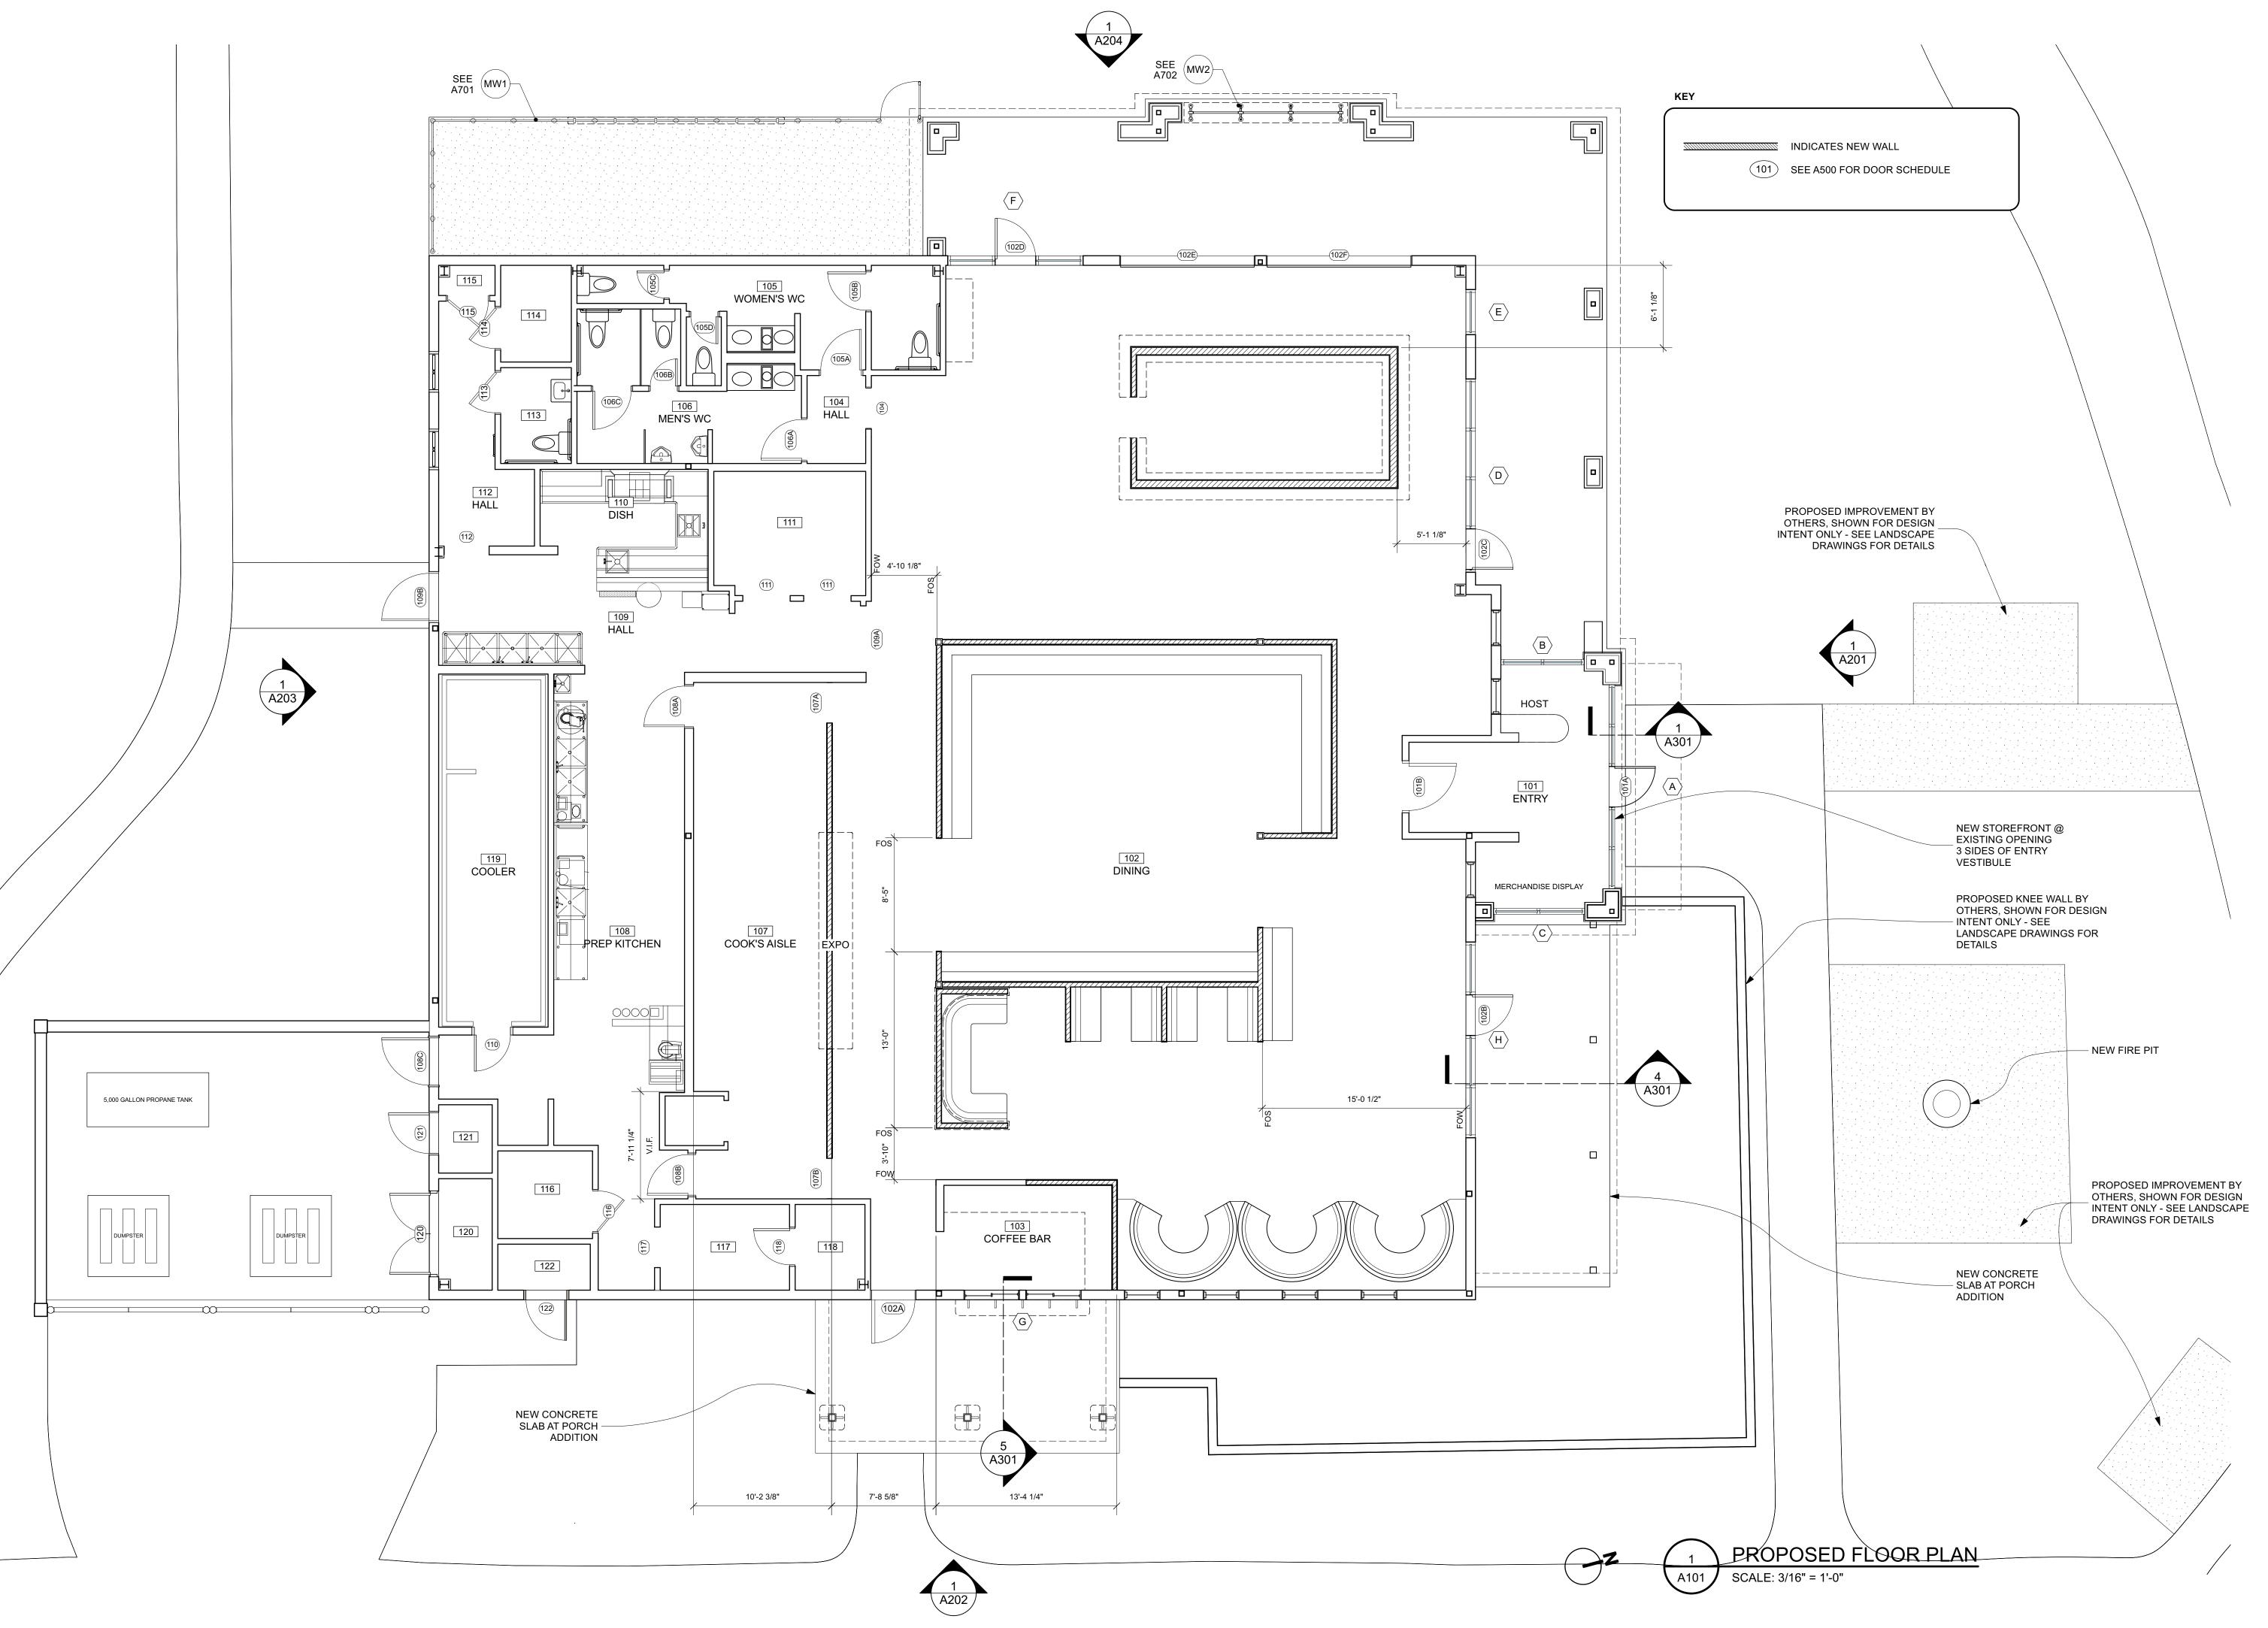
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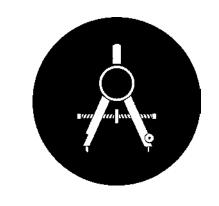
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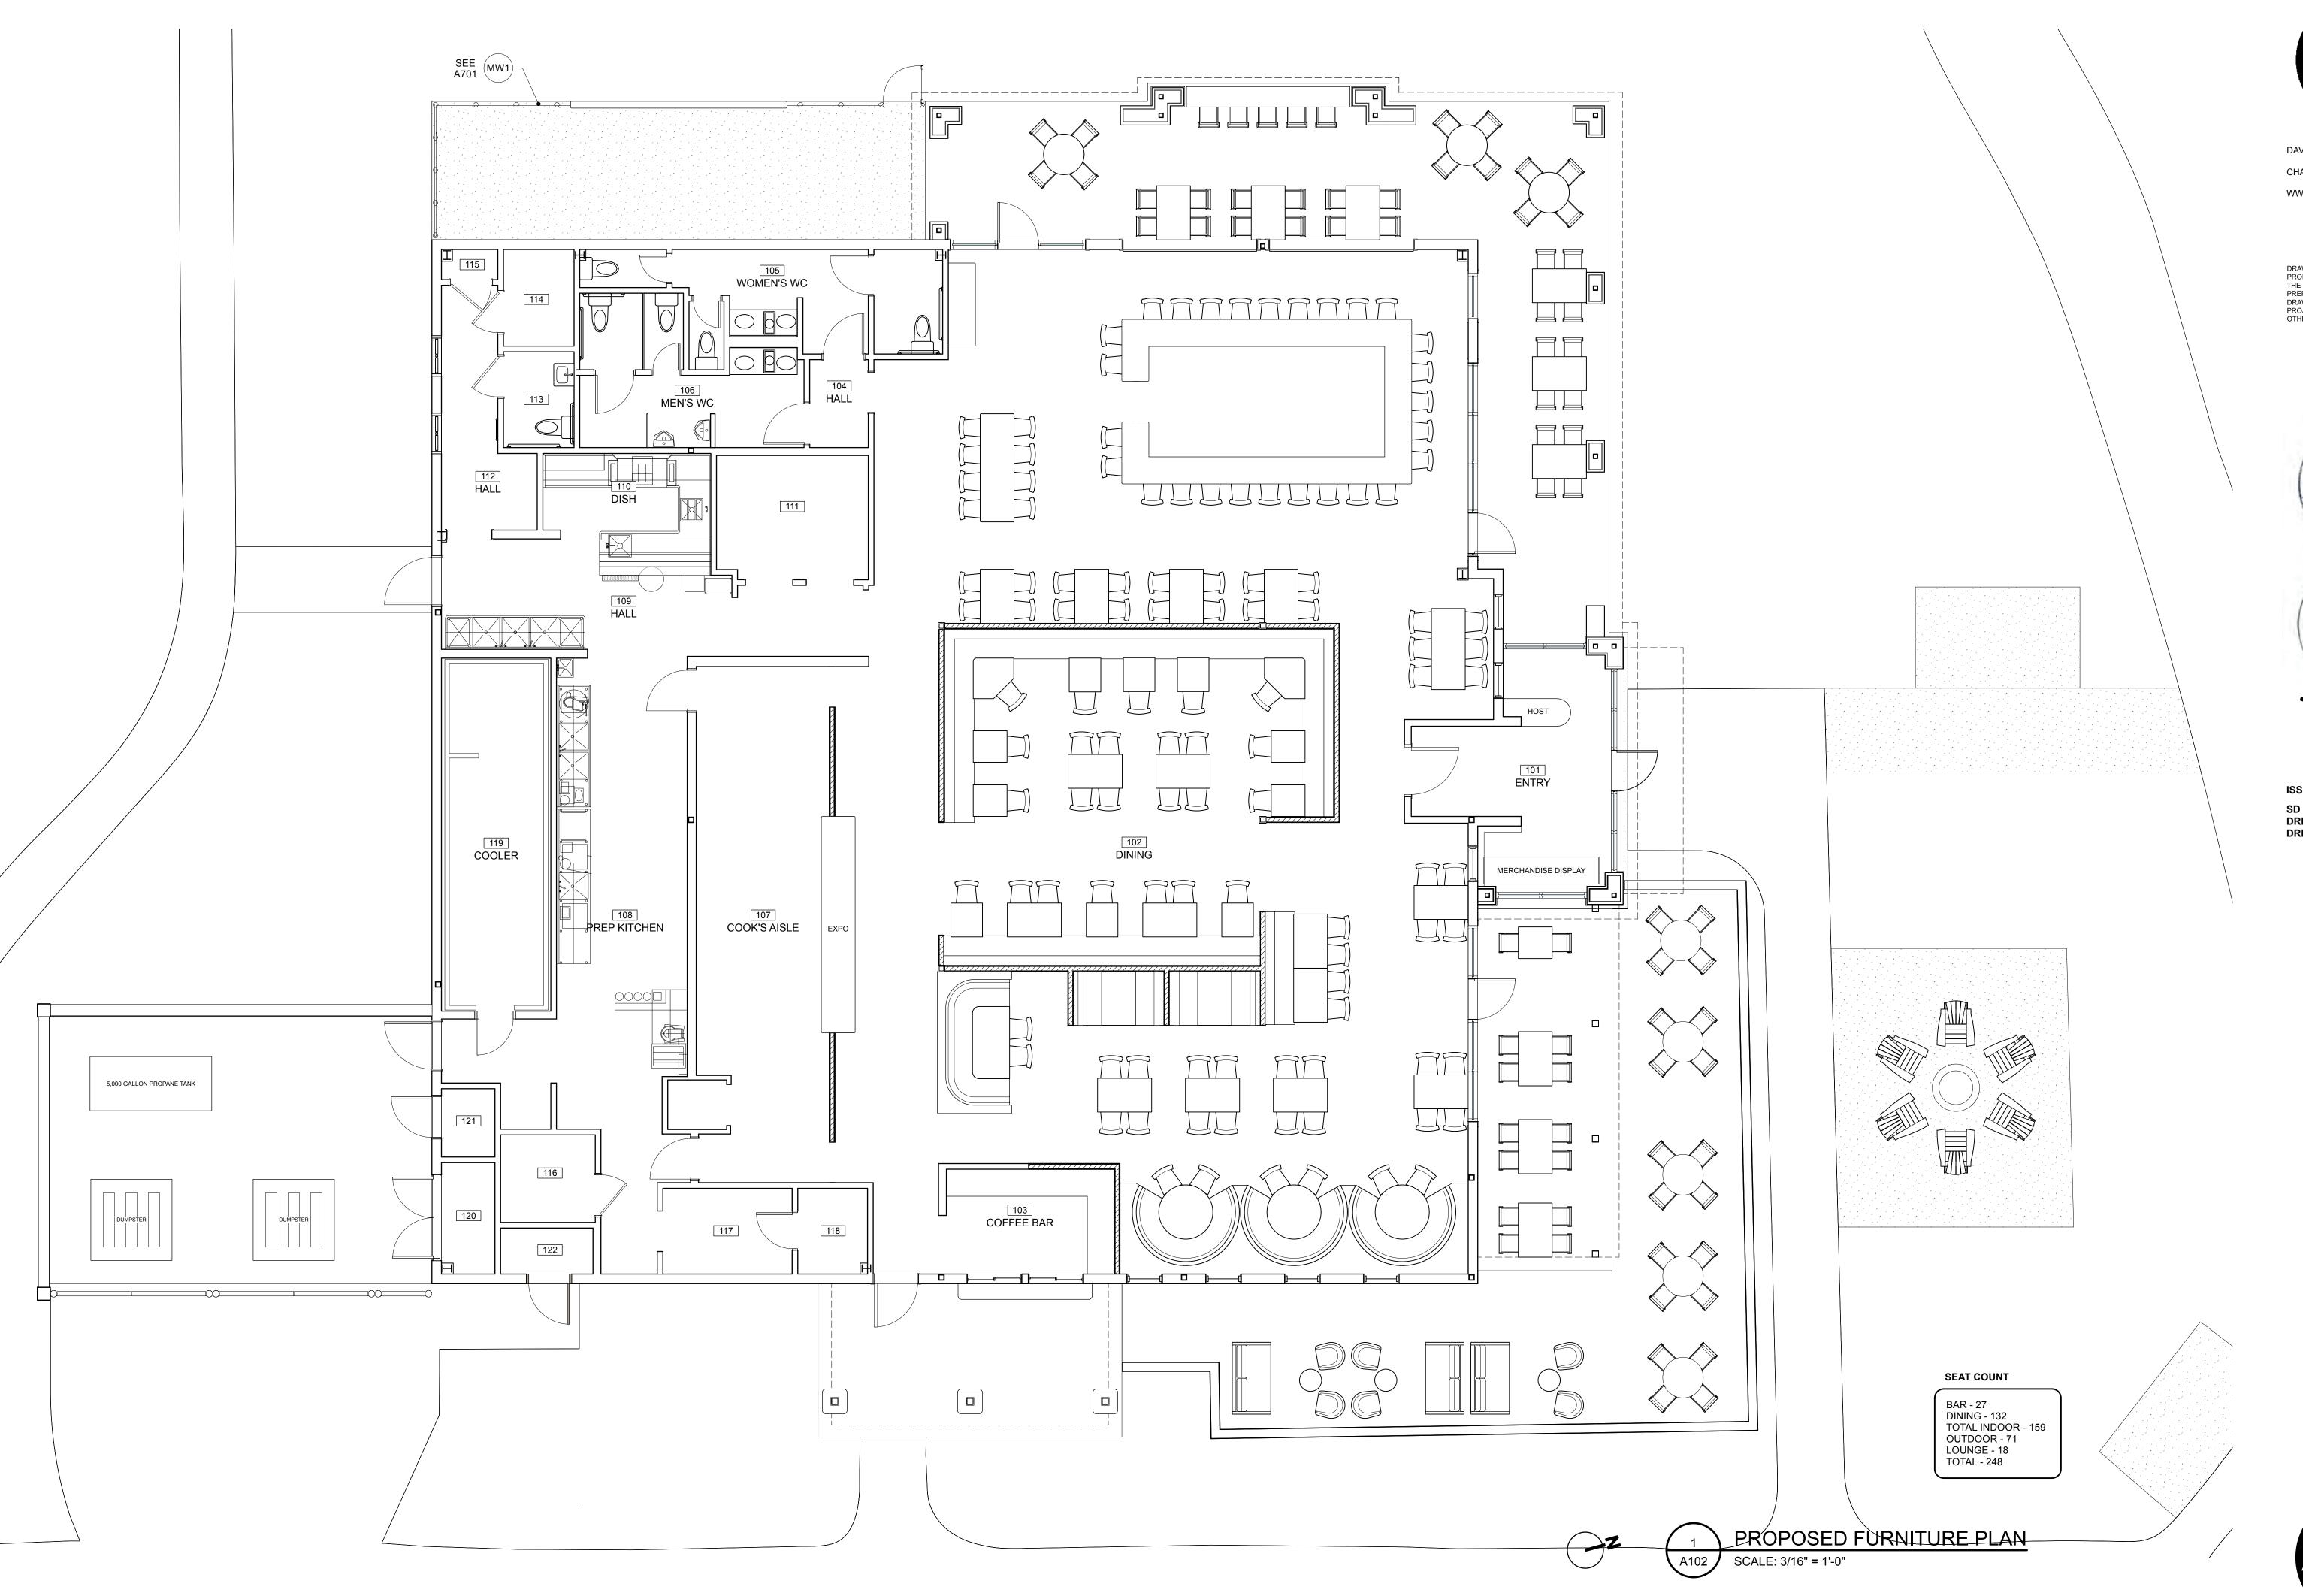
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AR

RD, 29928 14 FOLLY FIELD F HILTON HEAD, SC 2





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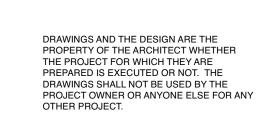


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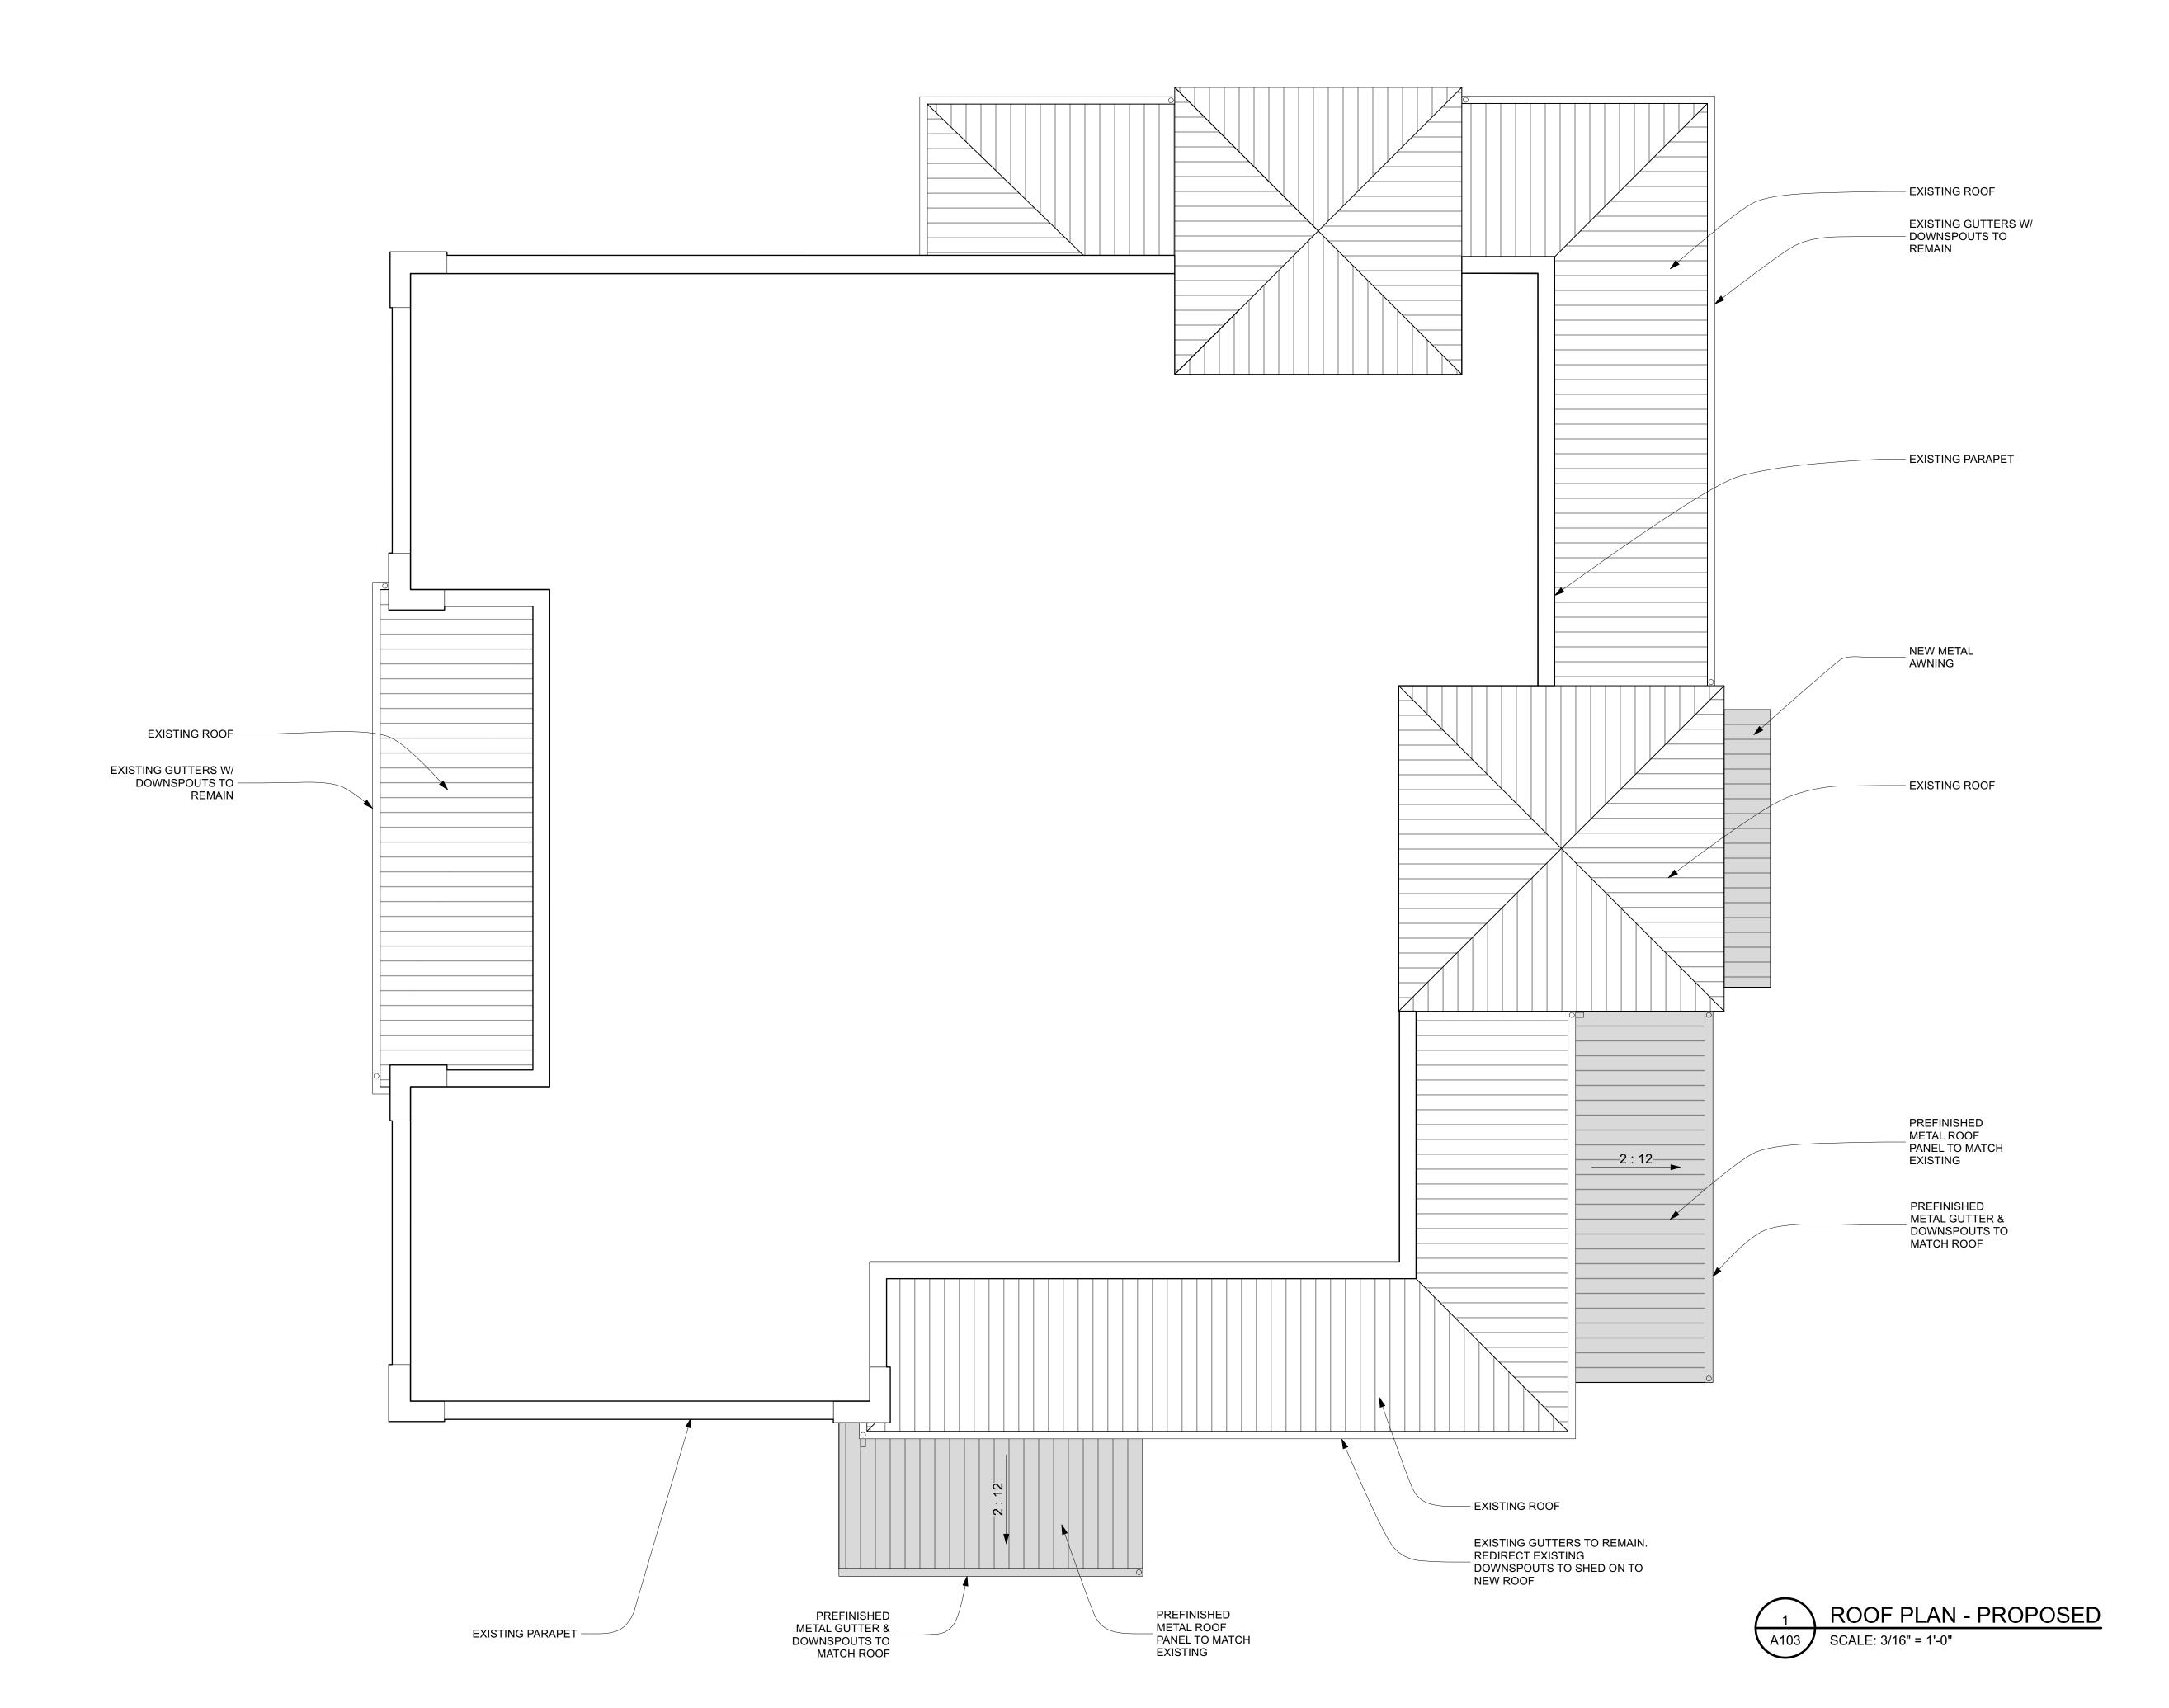
ISSUED DATE / REVISIONS

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RD, 29928

14 FOLLY FIELD F HILTON HEAD, SC 2 **BEACH BAR** LUCKY








VIEW OF SIDE PATIO FROM BIKE PATH



VIEW FROM PARKING LOT



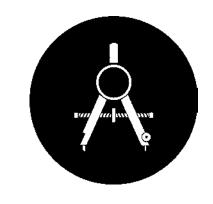

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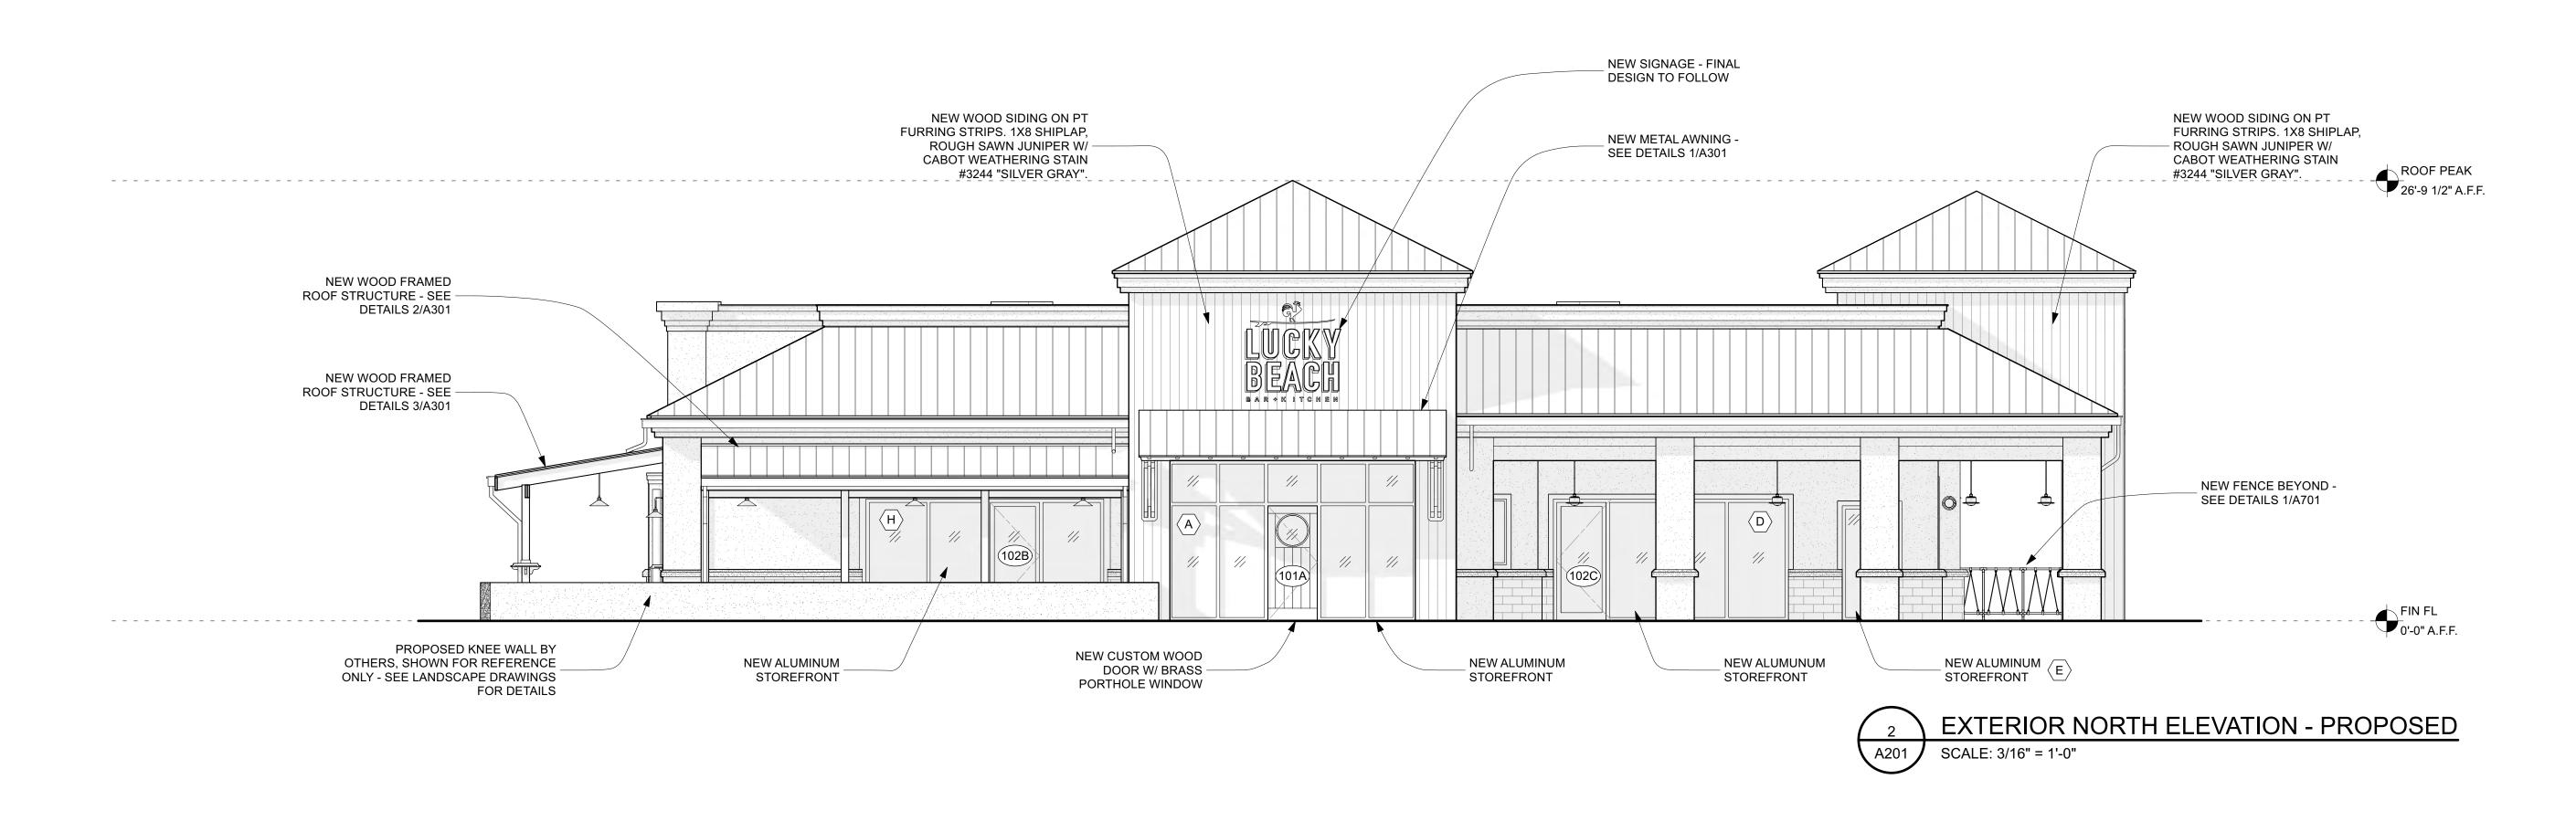
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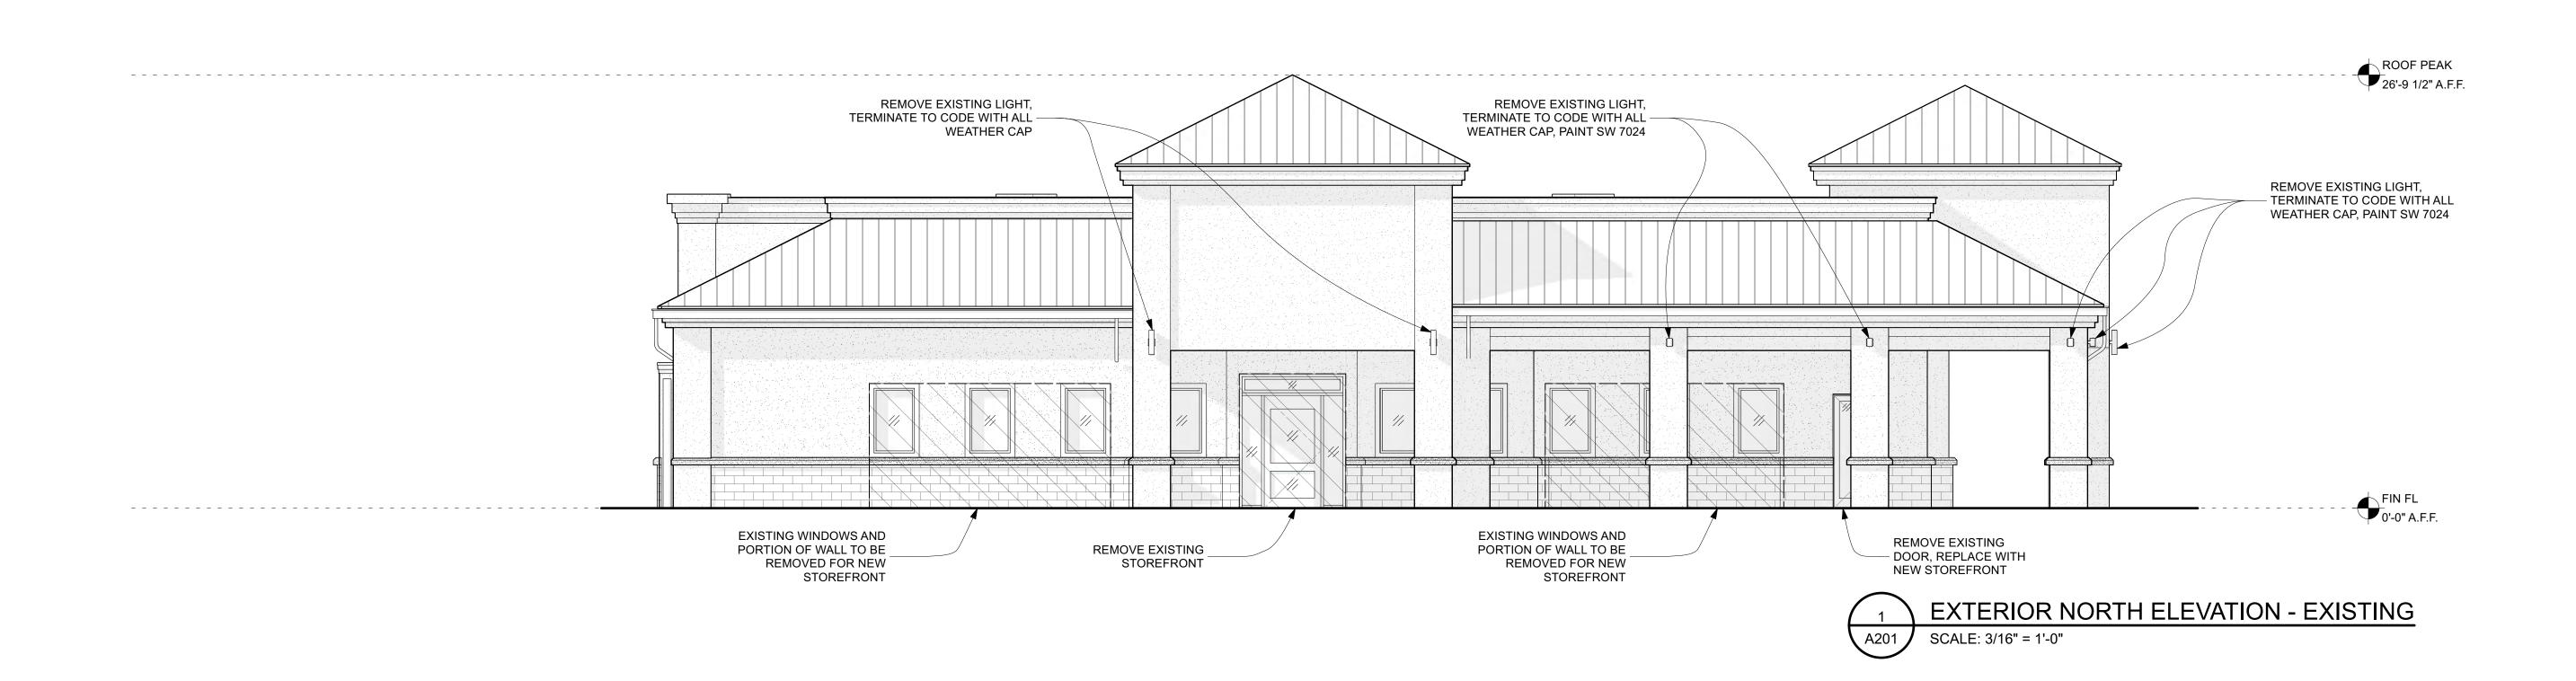
KY BEACH BAR + KITCHEN
14 FOLLY FIELD RD.

DRB SUBMITTAL - 02.22.2022















EXTERIOR EAST ELEVATION - EXISTING

SCALE: 3/16" = 1'-0"

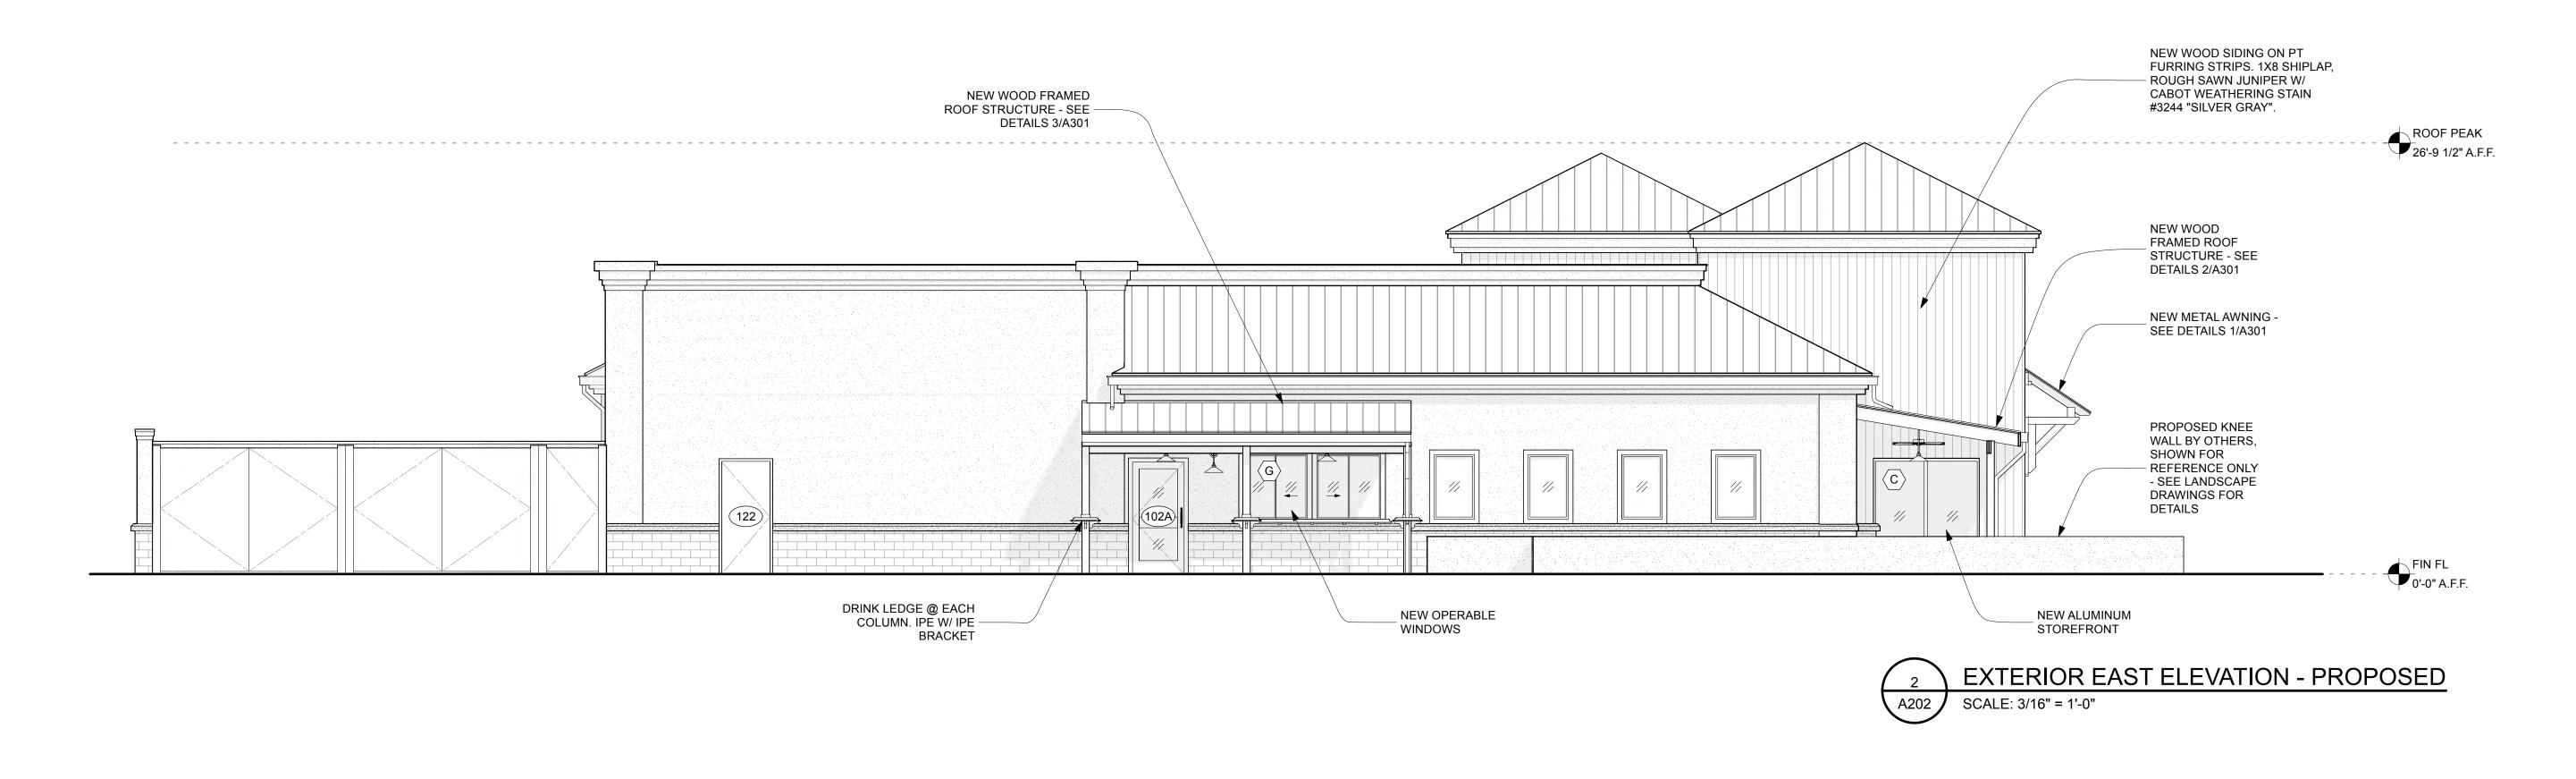

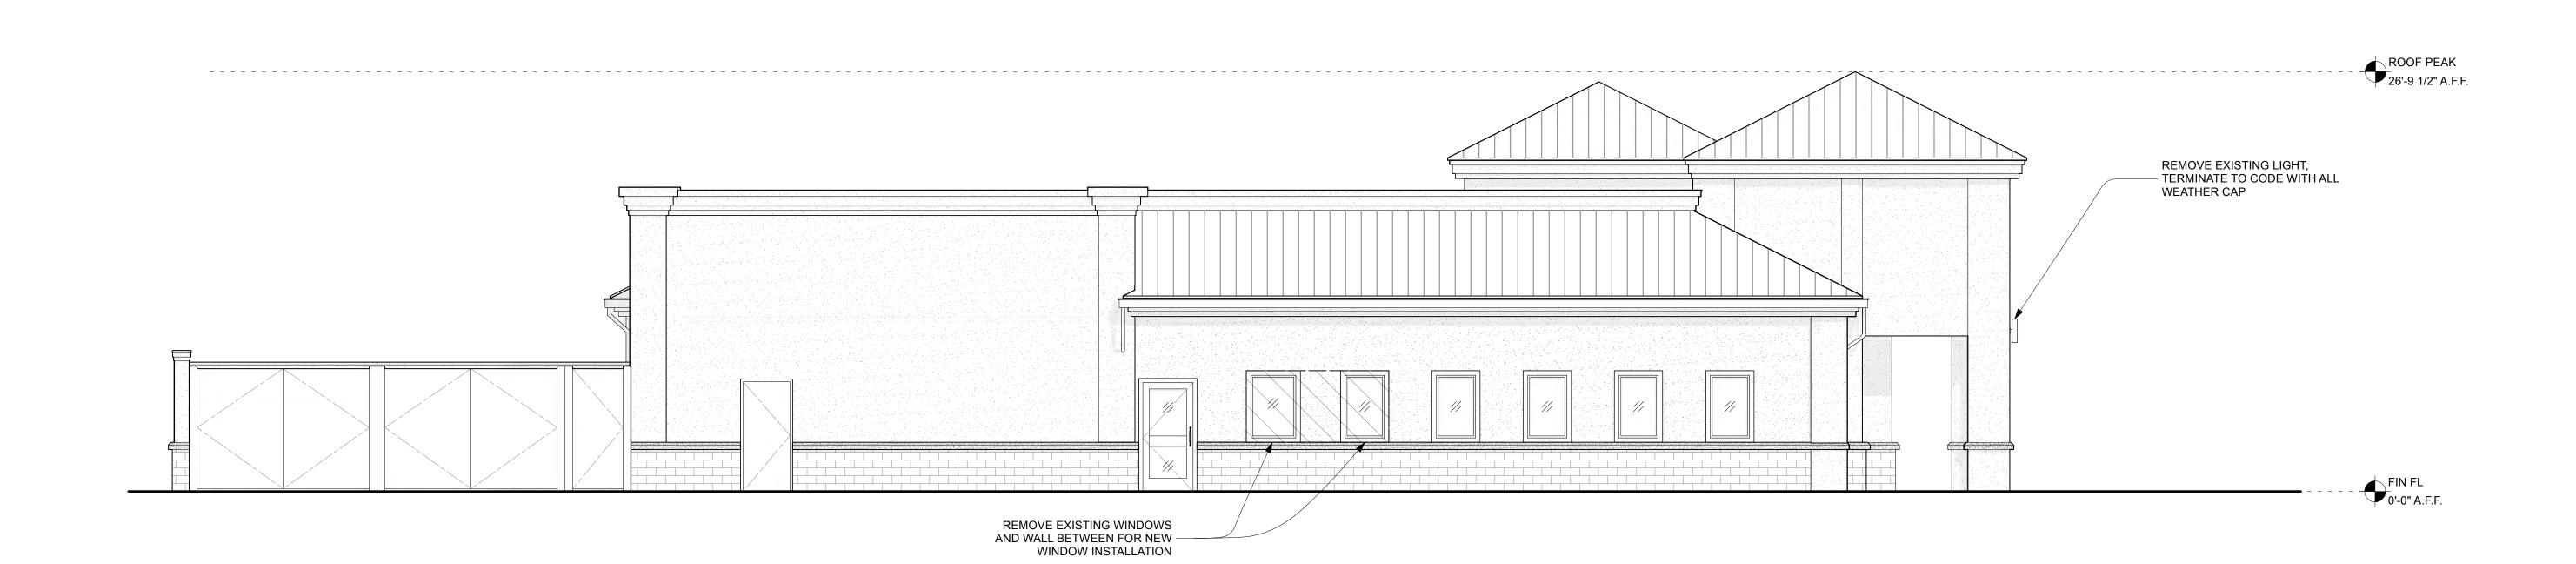



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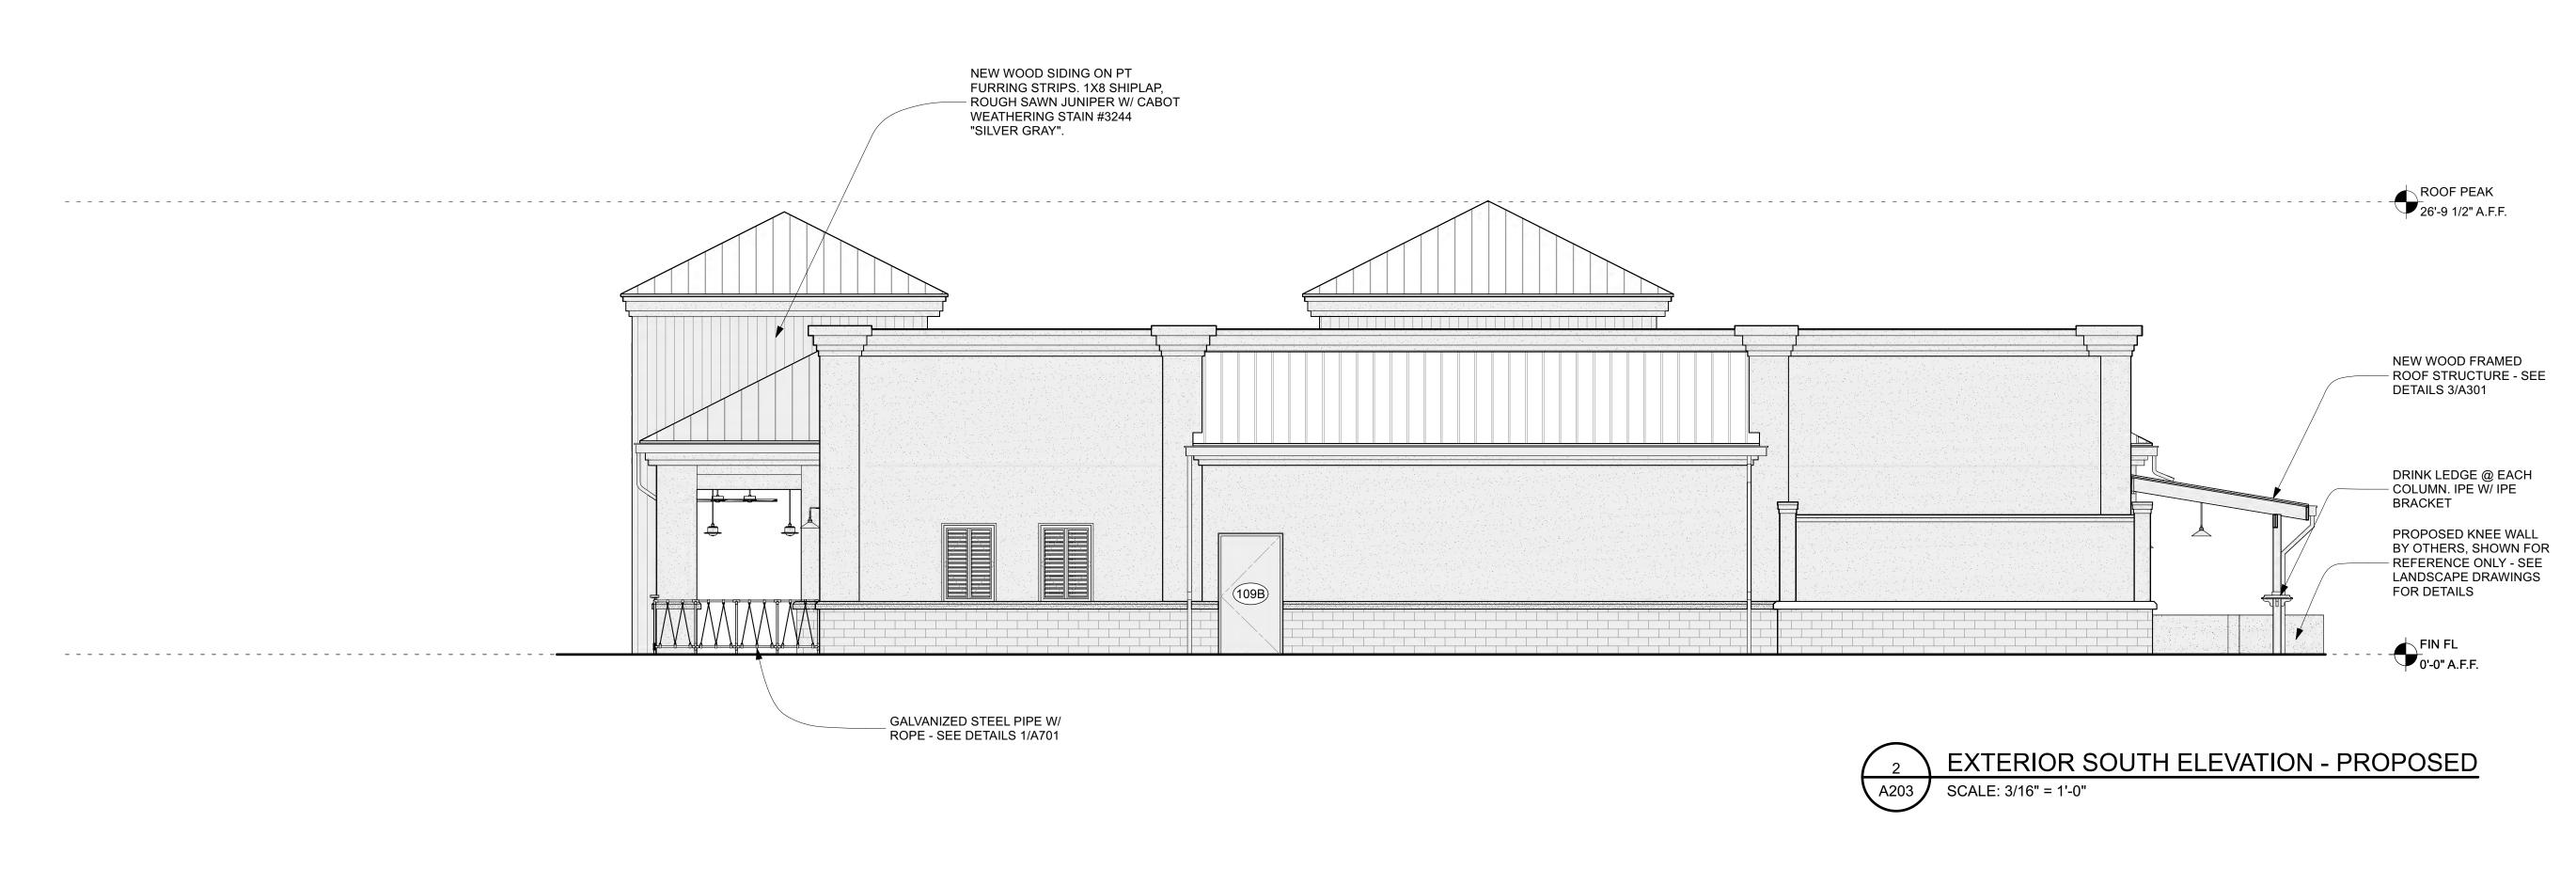



ISSUED DATE / REVISIONS SD - 11.12.2021

DRB SUBMITTAL - 12.21.2021 DRB SUBMITTAL - 02.22.2022








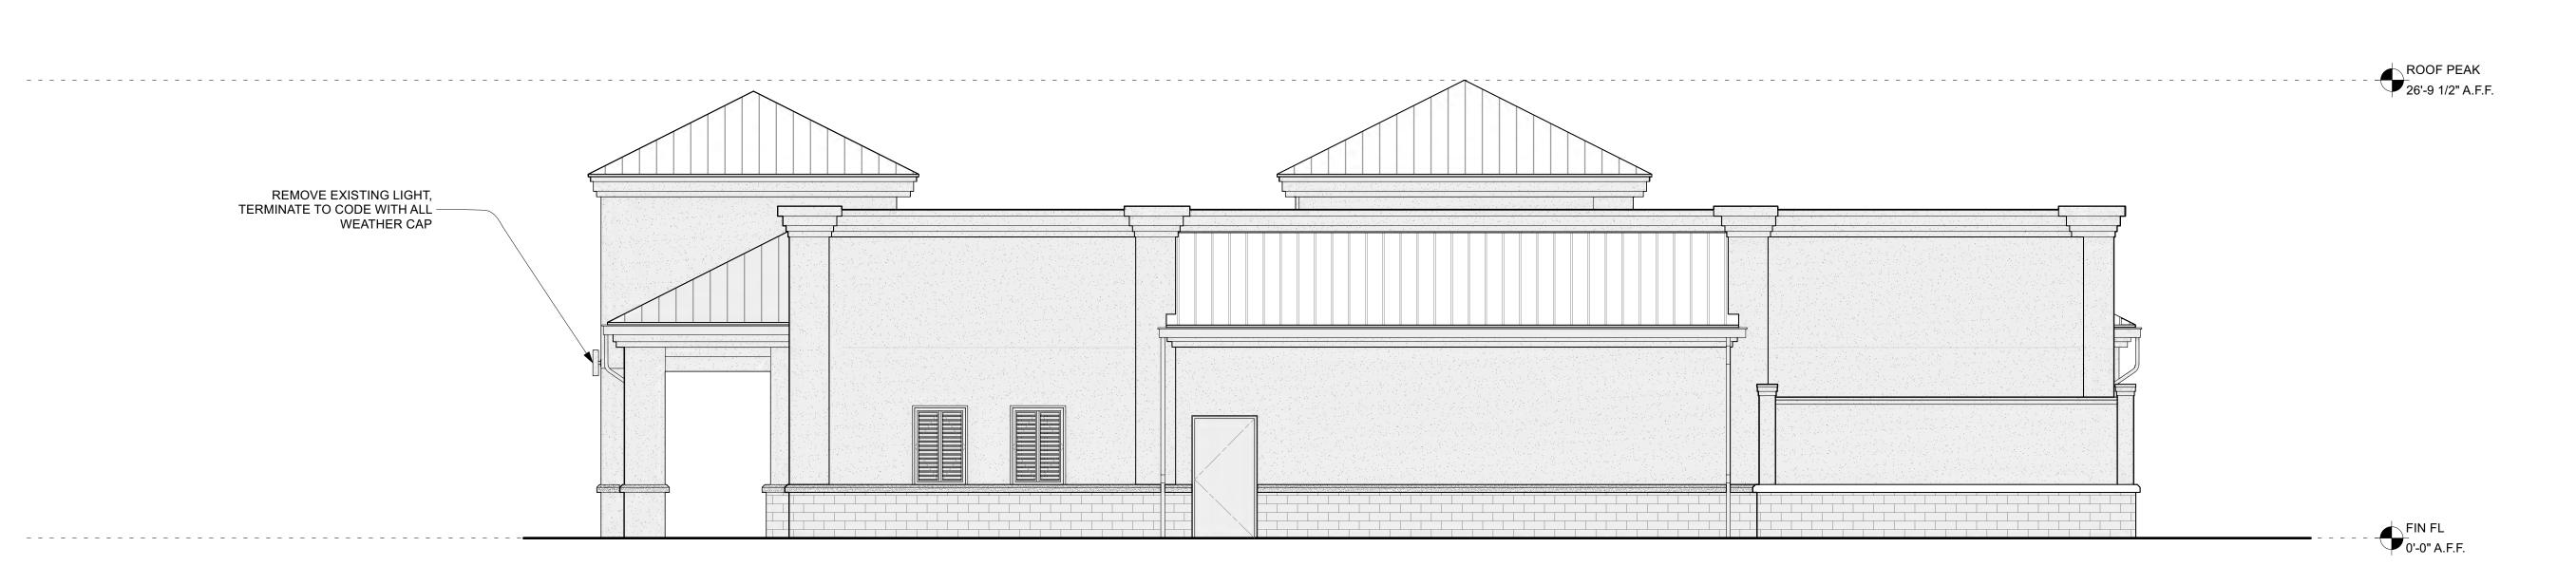

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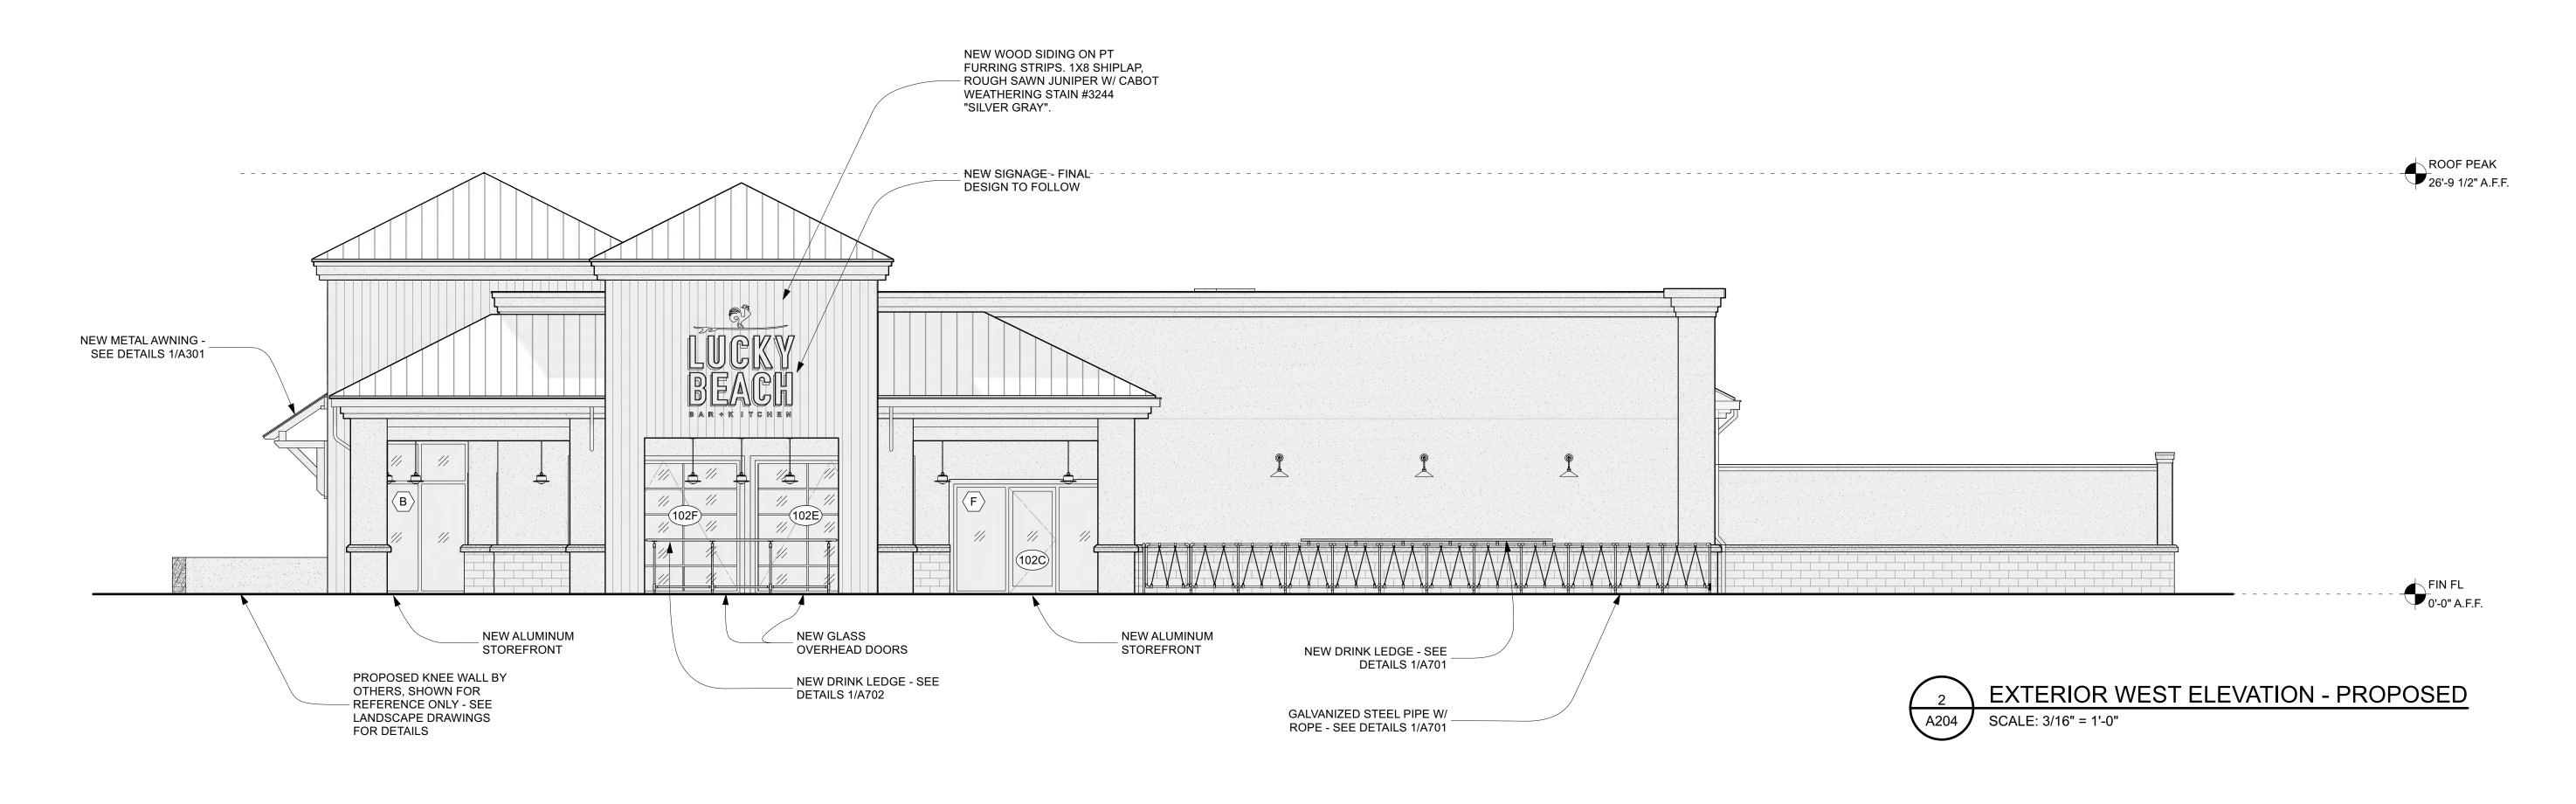



ISSUED DATE / REVISIONS SD - 11.12.2021 DRB SUBMITTAL - 12.21.2021 **DRB SUBMITTAL - 02.22.2022**

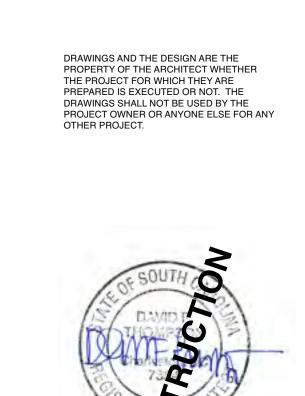




SCALE: 3/16" = 1'-0"



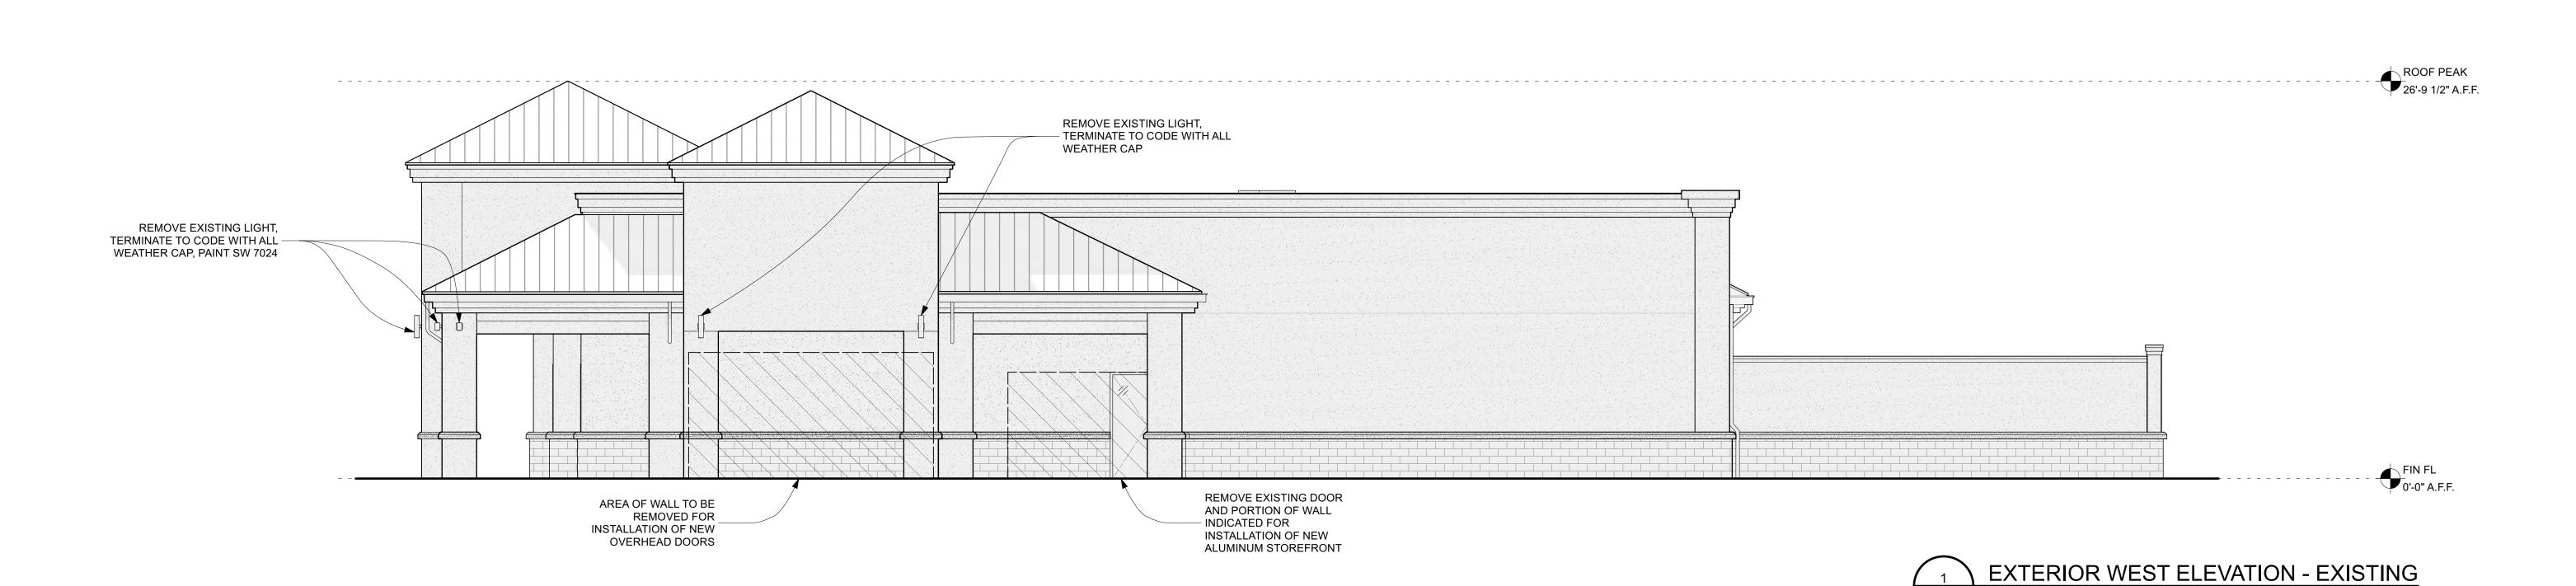


METAL ROOF MATCH EXISTING BRONZE ROOF

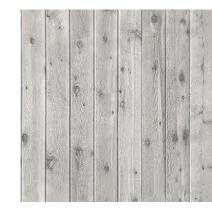

WOOD SIDING 1X8 SHIPLAP, ROUGH SAWN JUNIPER W/ CABOT WEATHERING STAIN #3244 "SILVER GRAY".

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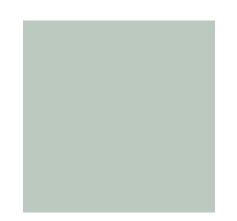
WALL PAINT SW 7024 FUNCTIONAL GREY

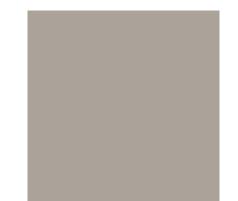


IPE WOOD UNFINISHED

(c) (c)

D



CEILING PAINT DCR079

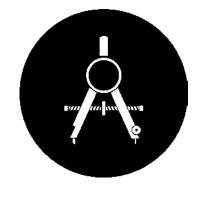

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CHARLESTON SC / 843-297-8939
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SD - 11.12.2021 DRB SUBMITTAL - 12.21.2021 DRB SUBMITTAL - 02.22.2022

EXTERIOR EAST ELEVATION - COLORED

SCALE: 3/16" = 1'-0"




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1 EXTERIOR NORTH ELEVATION - COLORED

A205 SCALE: 3/16" = 1'-0"

CKY BEACH BAR





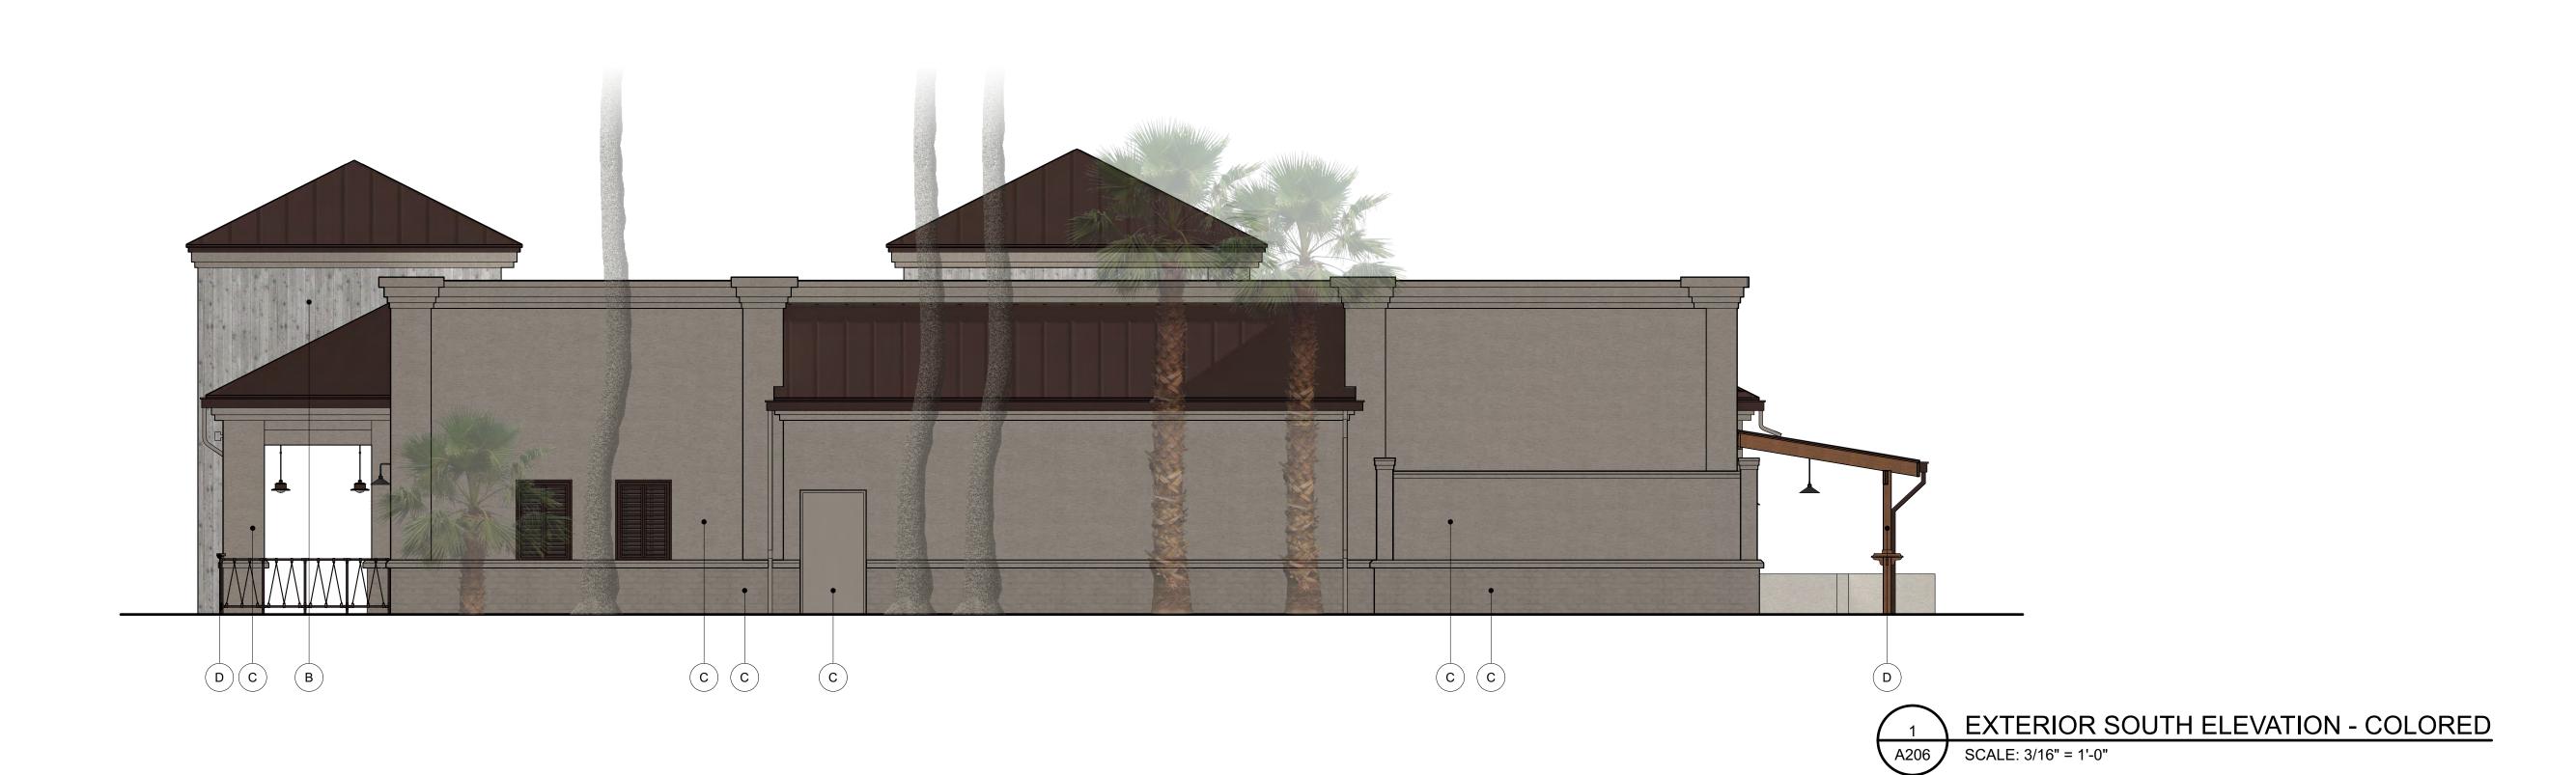


ISSUED DATE / REVISIONS SD - 11.12.2021


DRB SUBMITTAL - 12.21.2021 DRB SUBMITTAL - 02.22.2022




PATIO AWNING SECTION

SCALE: 1/2" = 1'-0"

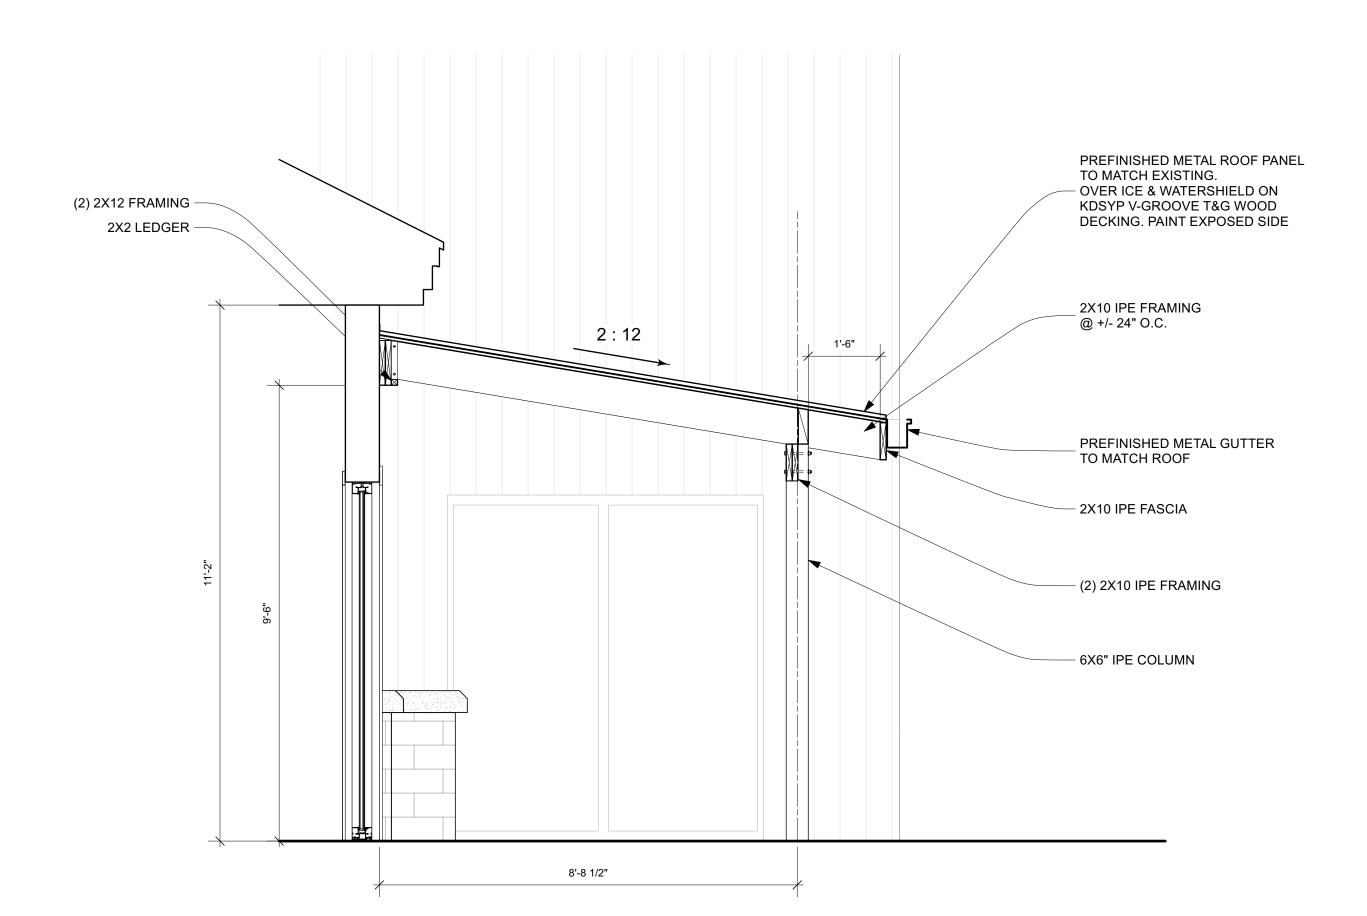

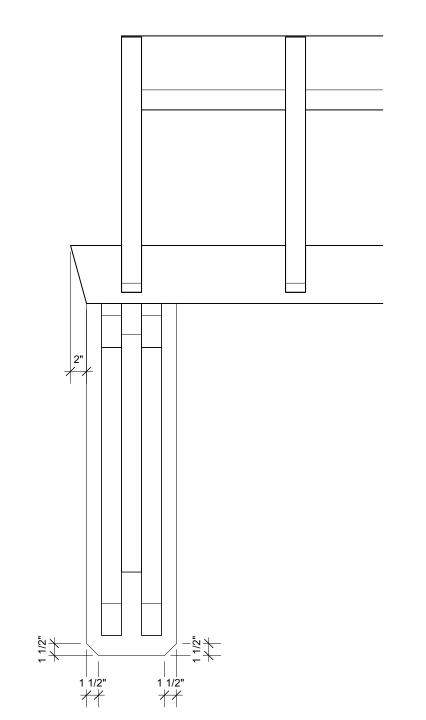




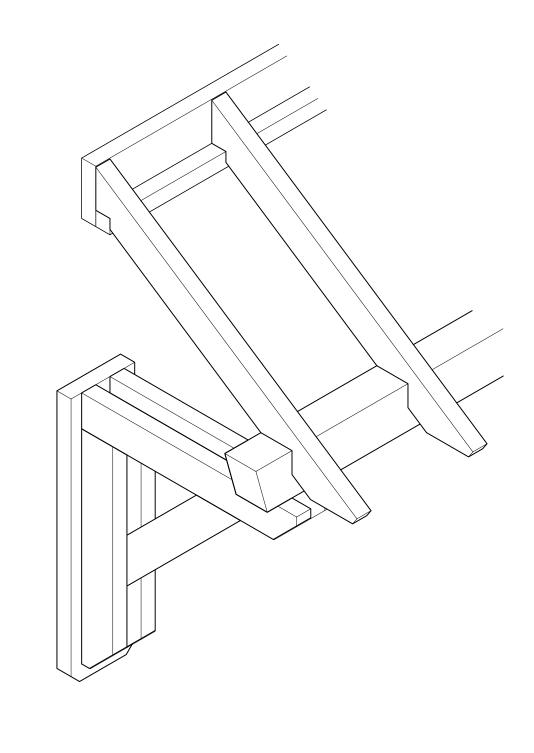

2 AWNING BRACKET AXONOMETRIC

A301 SCALE: 1" = 1'-0"

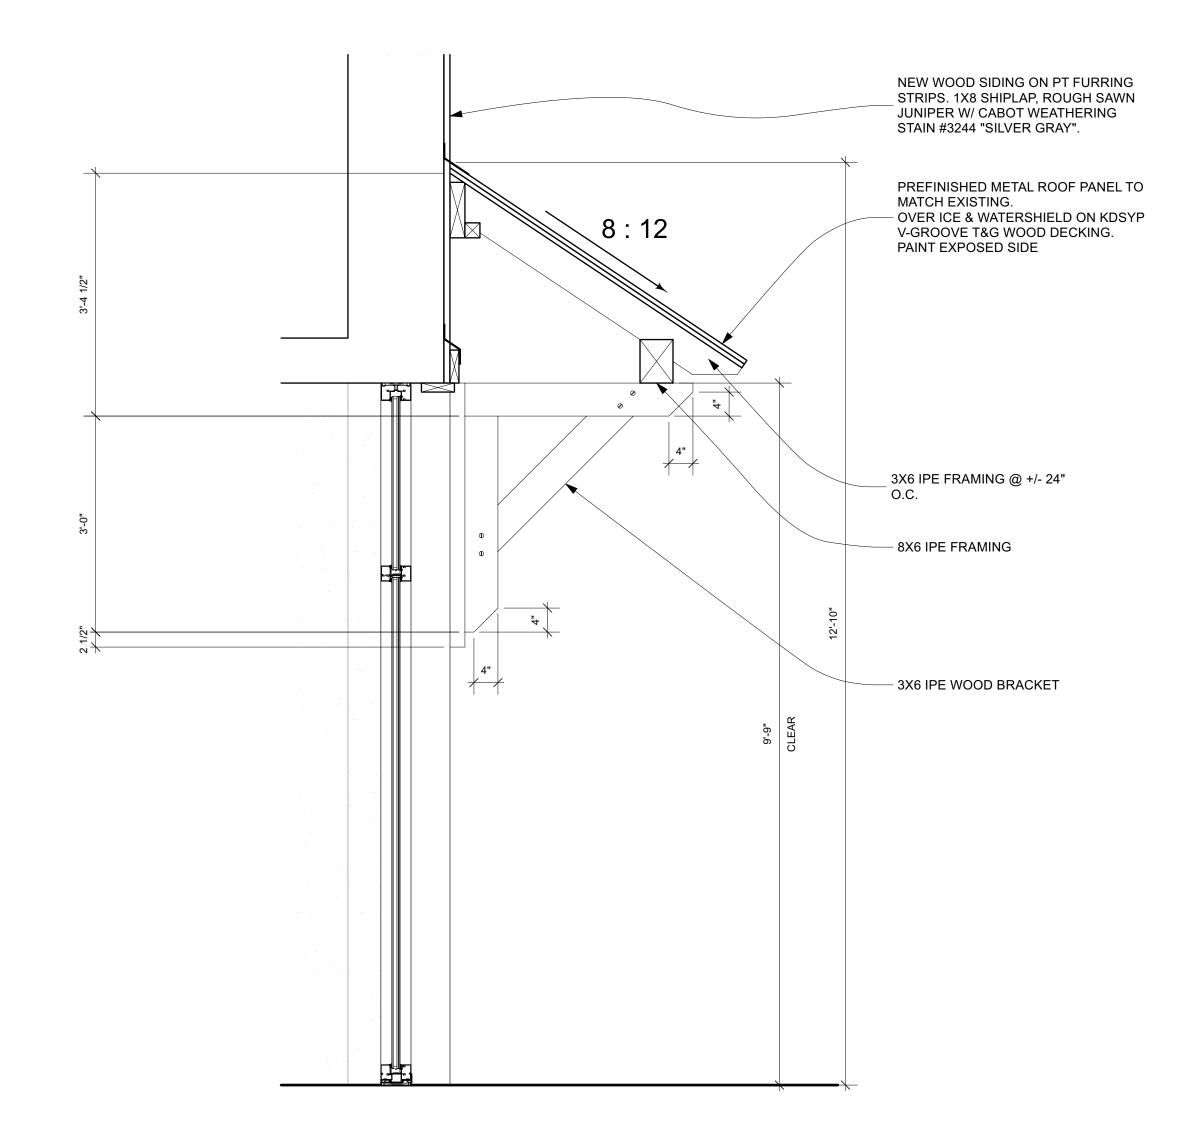





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CHARLESTON SC / 843-297-8939
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ISSUED DATE / REVISIONS

SD - 11.12.2021 DRB SUBMITTAL - 12.21.2021 DRB SUBMITTAL - 02.22.2022

BAR + KITCHEN
r FIELD RD,
AD, SC 29928

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ISSUED DATE / REVISIONS

DRB SUBMITTAL - 12.21.2021 DRB SUBMITTAL - 02.22.2022

> **LUCKY BEACH BAR + KITCHEN** 14 FOLLY FIELD RD, HILTON HEAD, SC 29928

DOOR SCHEDULES

1. G.C. MUST PROVIDE PRODUCT DATA SUBMITTAL AND SHOP DRAWINGS FOR DOORS. HARDWARE SUBMITTAL TO INCLUDE BUT NOT LIMITED TO HINGES,

2. DOORS SHALL HAVE ANSI COMPLIANT HARDWARE. PROVIDE SUBMITTAL.

5. G.C. SHALL COORDINATE LOCK AND KEY REQUIREMENTS WITH OWNER.

4. ALL DOOR HARDWARE SHALL COMPLY WITH 1008.1.9 FOR DOOR OPERATIONS. EGRESS DOORS SHALL BE READILY OPERABLE FROM THE EGRESS SIDE

3. ALL DOORS AND ASSOCIATED HARDWARE SHALL COMPLY WITH

WITHOUT THE USE OF A KEY OR SPECIAL EFFORT.

DOOR NOTES

LOCKING MECHANISMS, THRESHOLDS, ETC.

ICCA117.1-2009

NOMINAL SIZE


TO" EXT TBD N/A

T'0" EXT TBD TBD


8'6" EXT TBD TBD

8'6" EXT TBD TBD

REMARKS

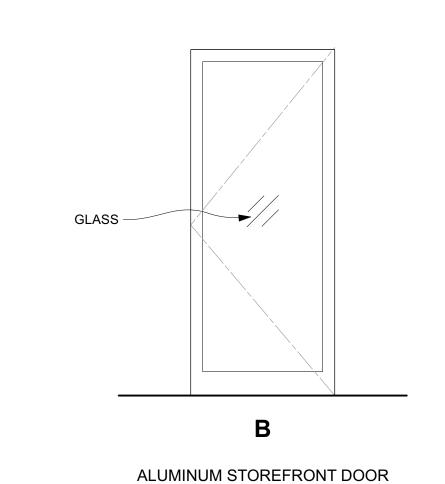

EXTERIOR

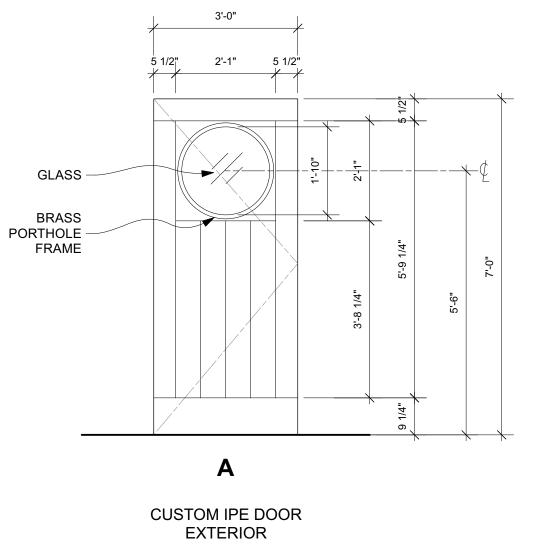

DOOR SCHEDULE

LOCATION ENTRY

DINING
DINING
DINING
DINING
DINING


101A 102B 102C 102D 102E 102F


	5 1/2" 2'-1" 5 1/2	*	-27	
GLASS		2:1		
BRASS PORTHOLE FRAME		3'-8 1/4"	5'-9 1/4"	.0-7
			9 1/4"	
	Α		N	N N

"ALUMAVIEW AV300"
SECTIONAL RAIL AND
STILE DOORS BY
RAYNOR GARAGE DOORS
EXTERIOR

C



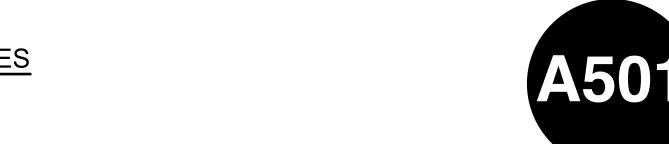

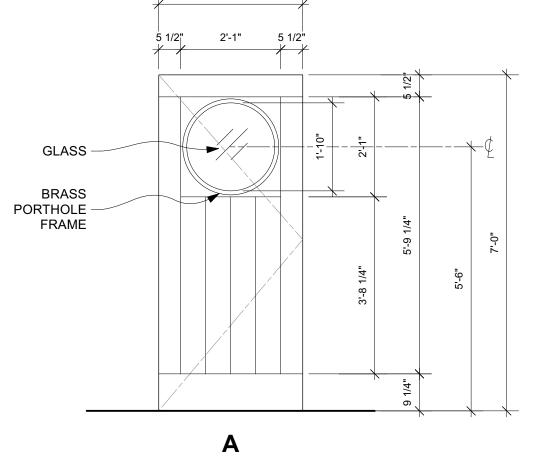

2. G.C. MUST PROVIDE SHOP DRAWINGS AND FINISH SAMPLE FOR ARCHITECT APPROVAL.

3. ALL WINDOWS SHALL BE IMPACT RATED AND MEET REQUIRED MISSILE TEST STANDARDS AND DP RATING REQUIREMENTS PER 2018 IBC SECTION 2406.2.

4. ALL GLAZING SHALL BE 1" INSULATED UNIT, W/ SOLARBAND 70 FILM SHGC MUST BE \leq 0.3, U-VALUE MUST BE \leq 0.5, LOW E


5. G.C. SHALL INSTALL PER MANUFACTURER'S INSTRUCTIONS.



WINDOW TYPES

SCALE: 1/2" = 1'-0"

8'-6 1/4"

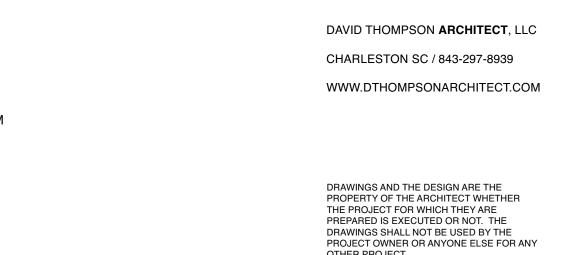




OTHER PROJECT.




ISSUED DATE / REVISIONS

DRB SUBMITTAL - 12.21.2021 DRB SUBMITTAL - 02.22.2022



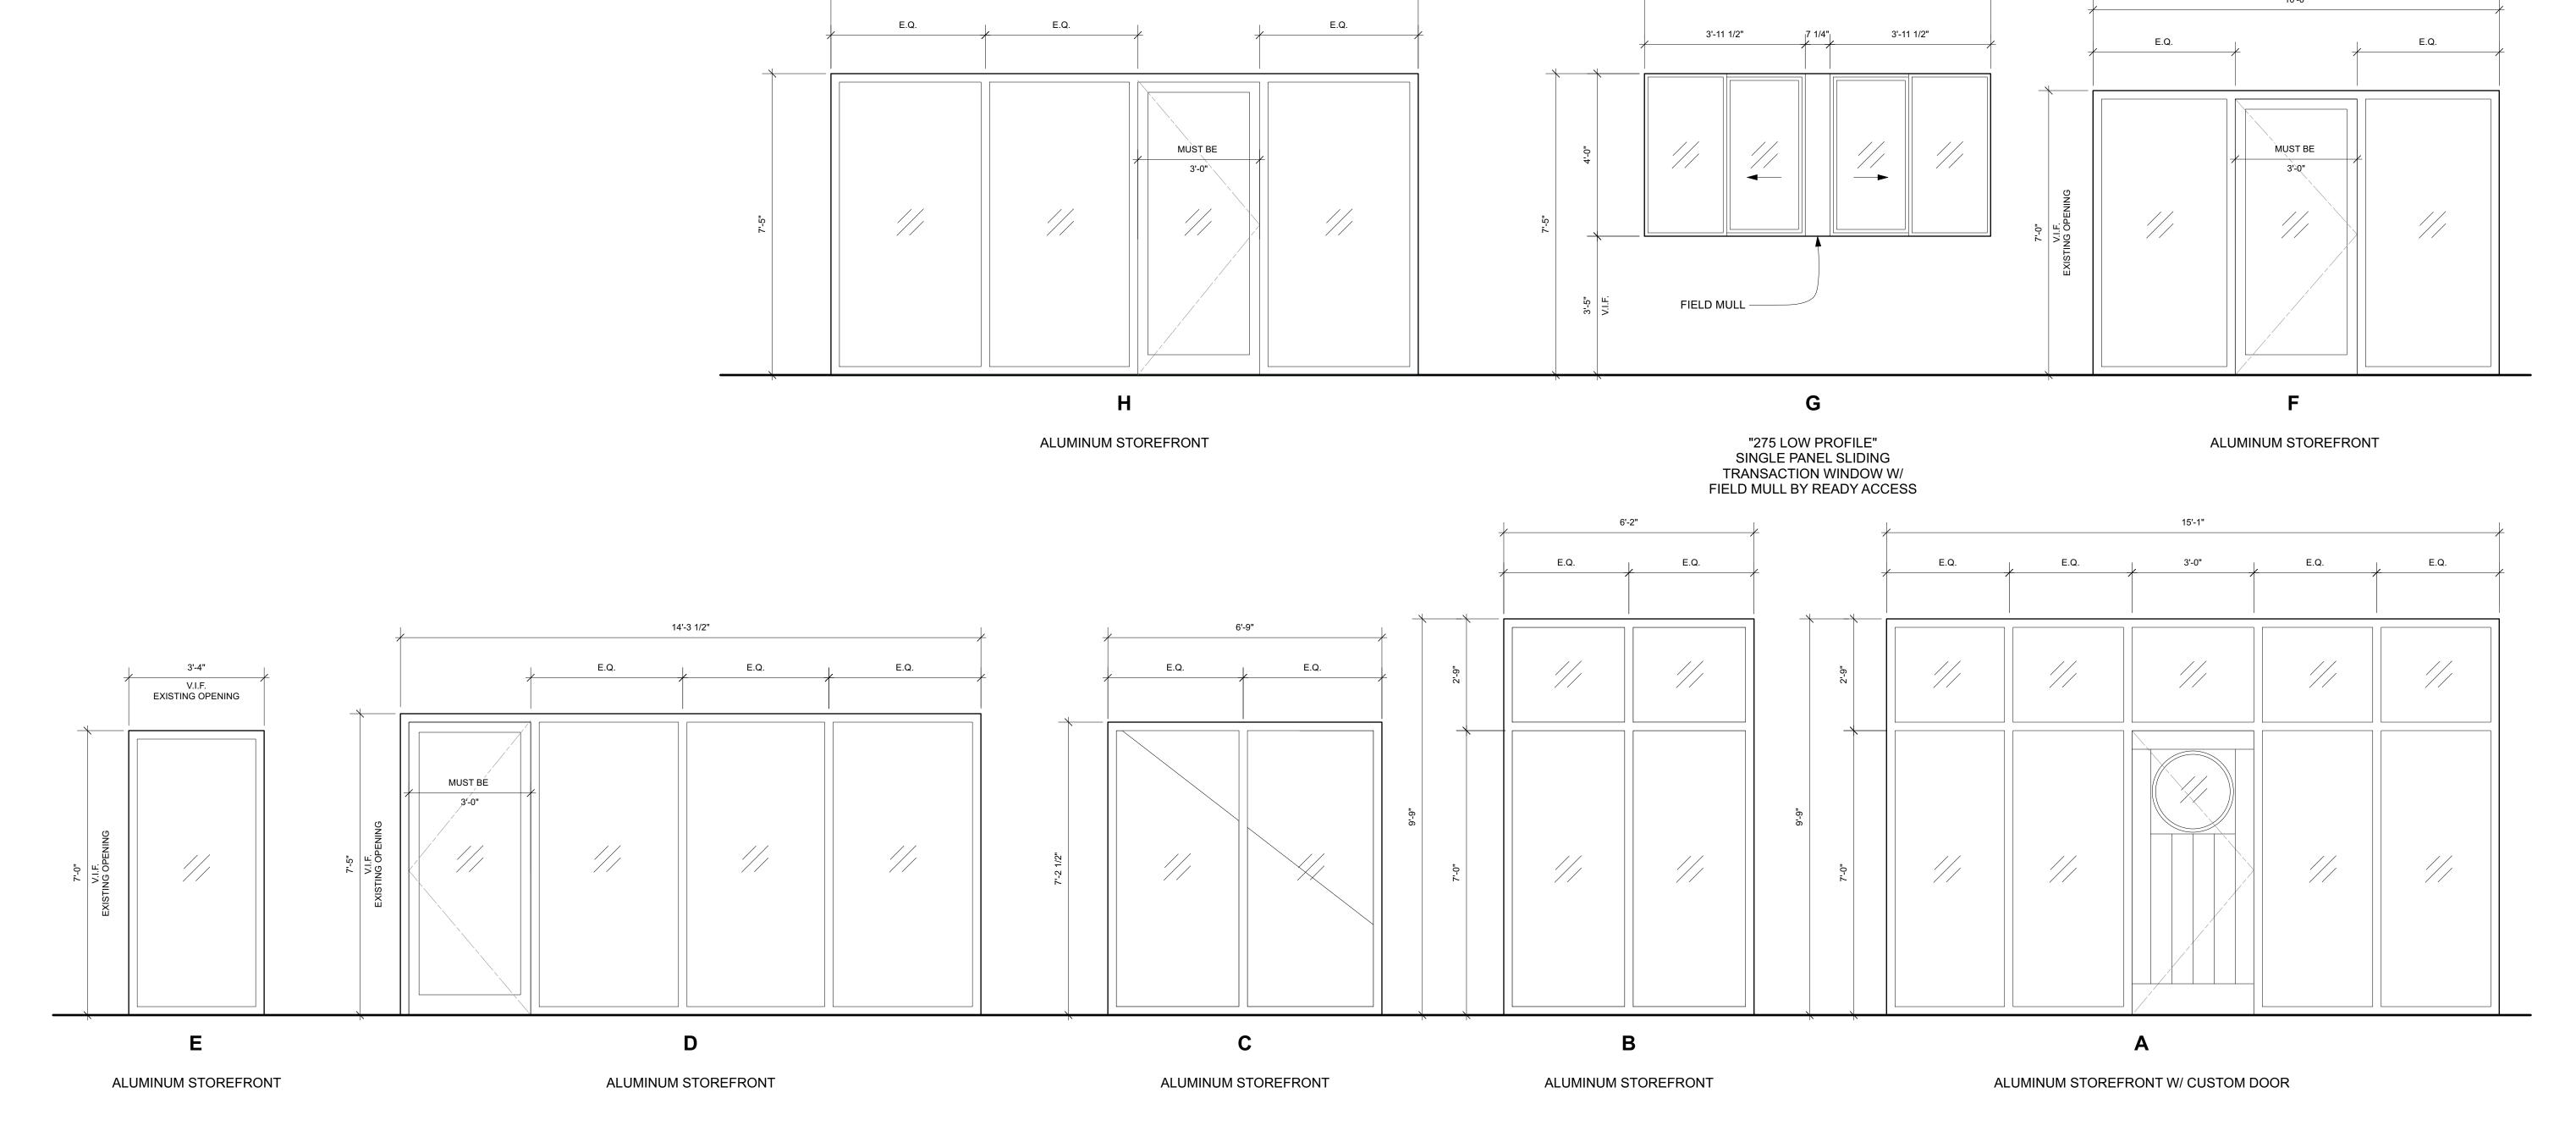

14'-5 1/2"

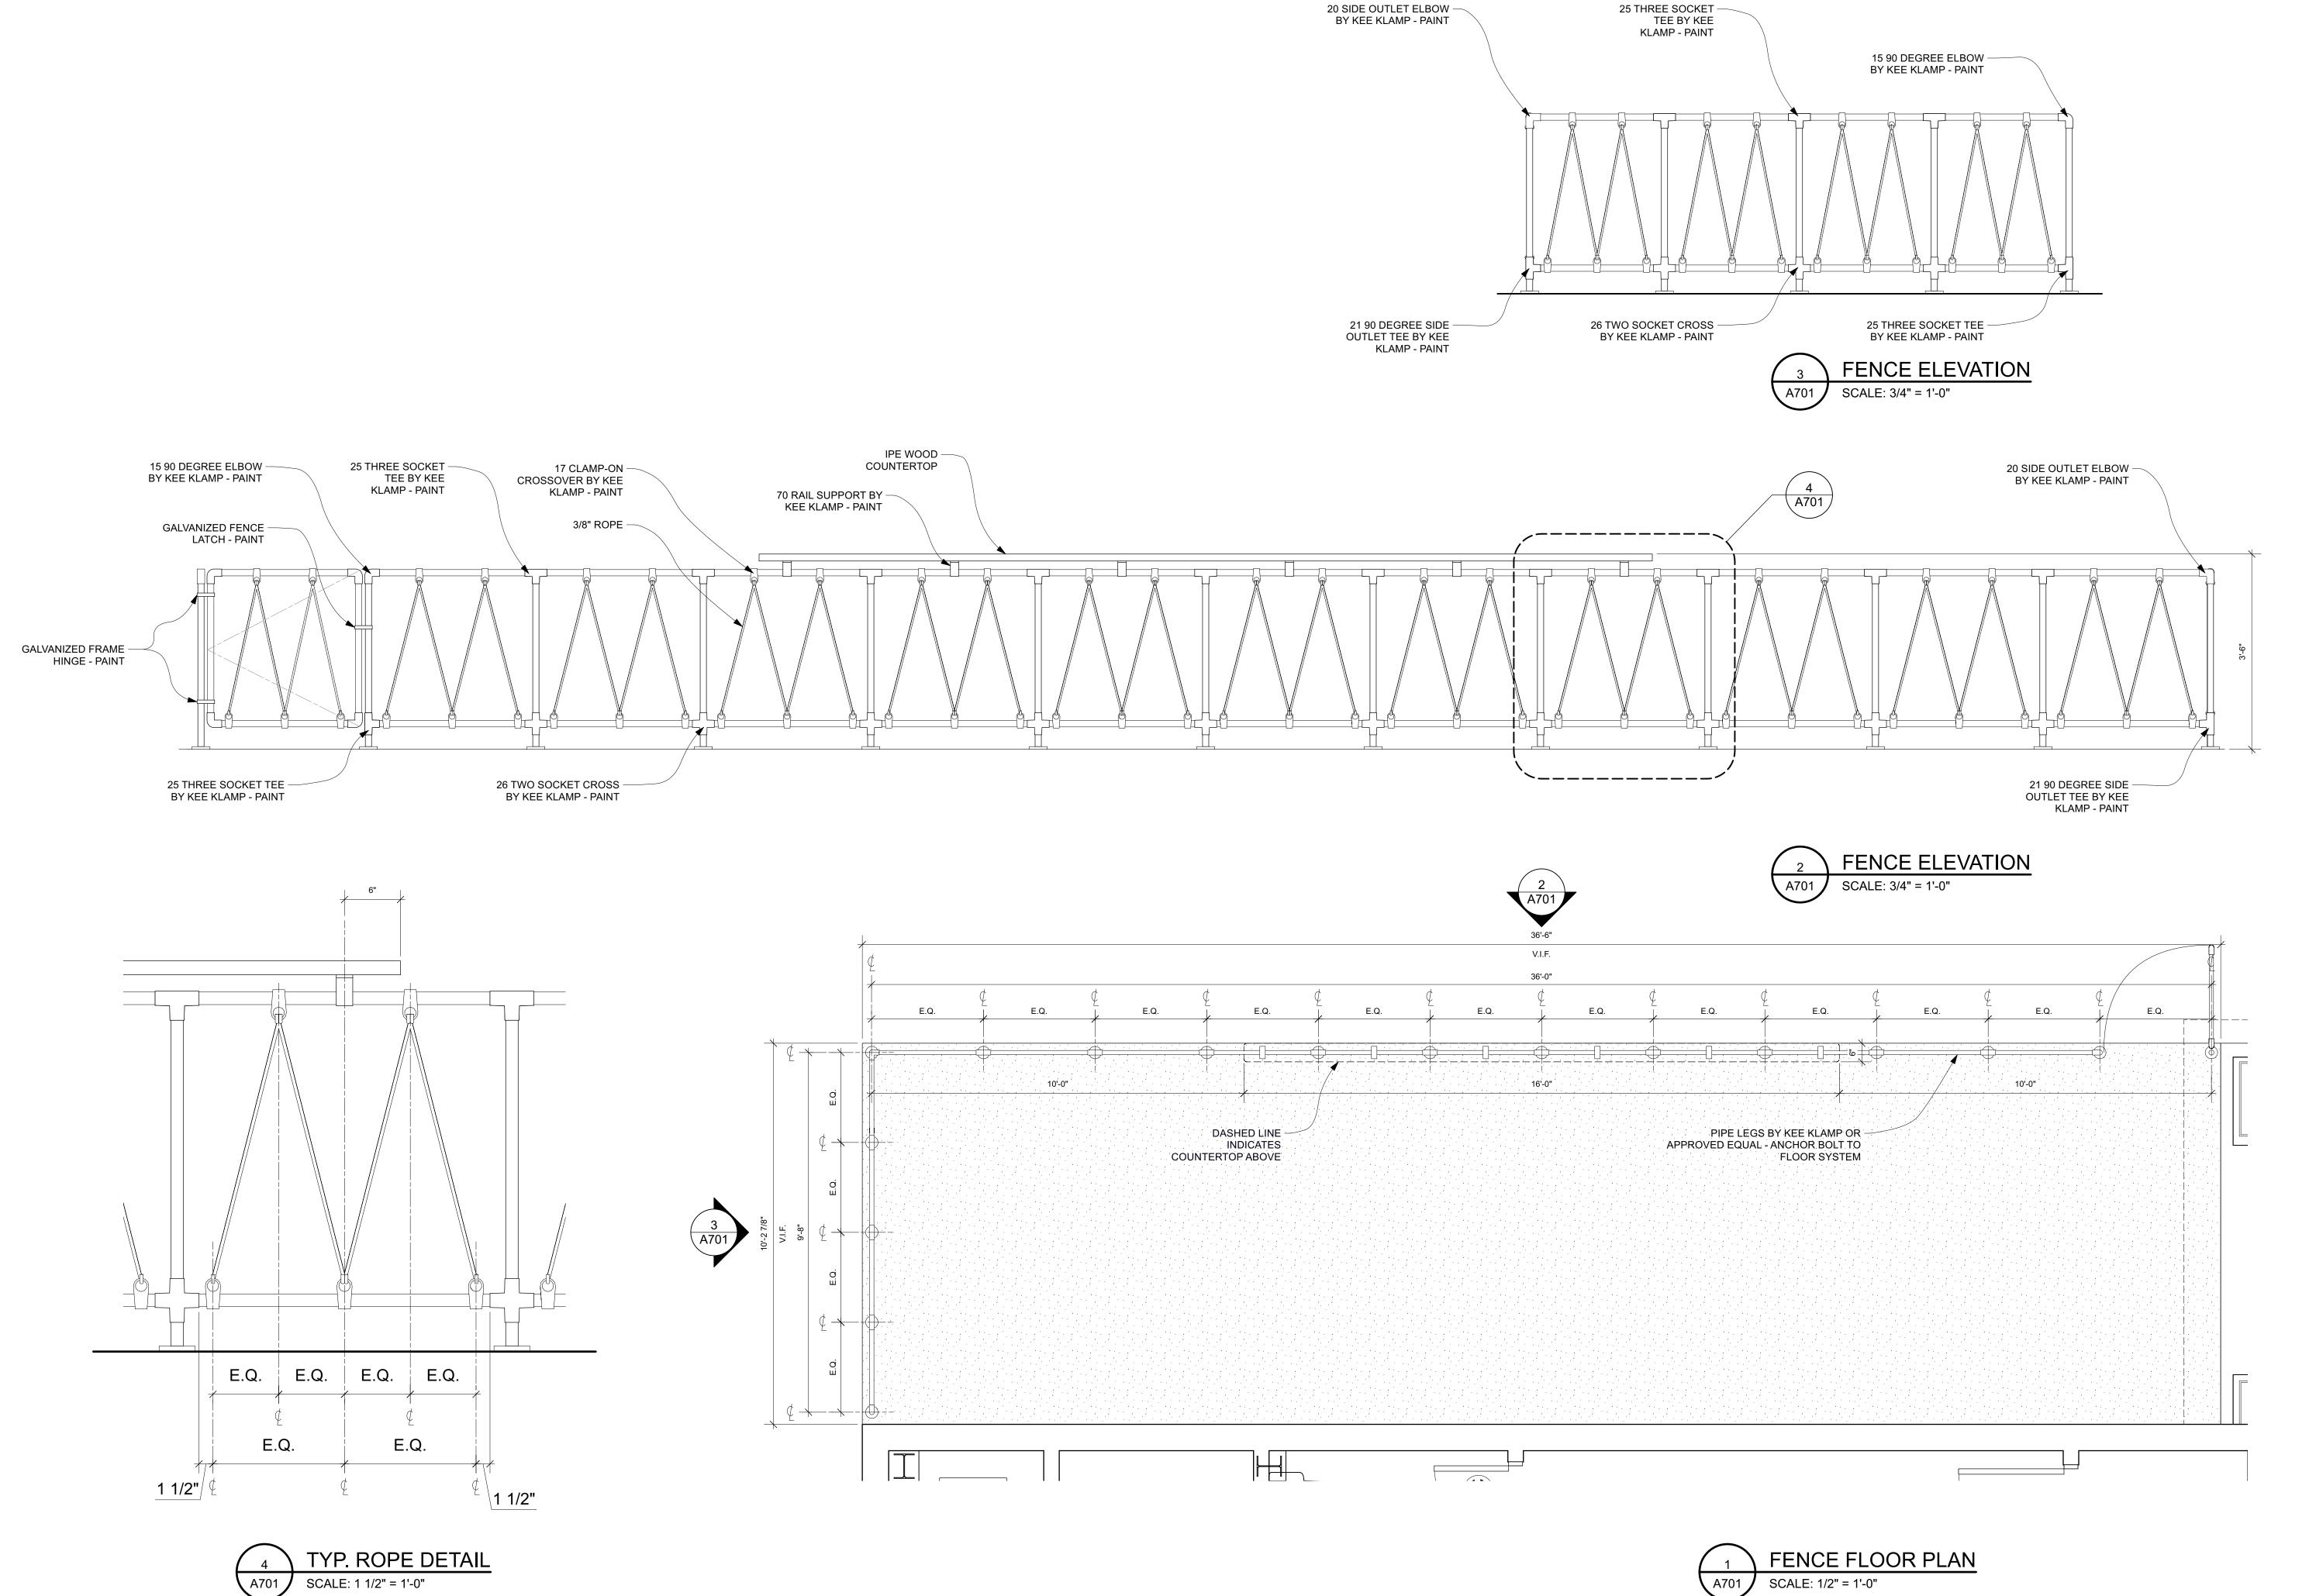

25 THREE SOCKET -

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CHARLESTON SC / 843-297-8939

WWW.DTHOMPSONARCHITECT.COM

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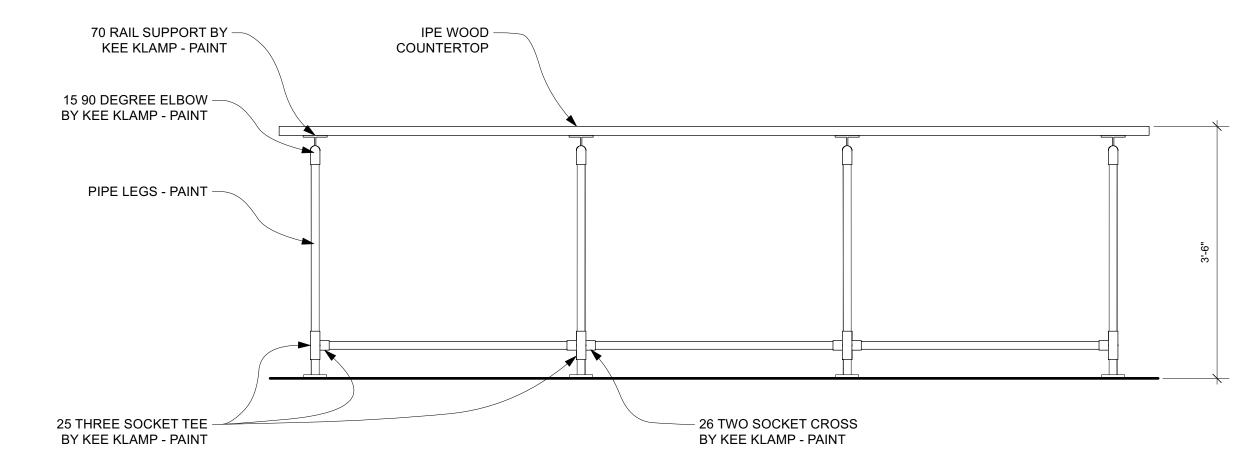
OTHER PROJECT.




ISSUED DATE / REVISIONS SD - 11.12.2021

DRB SUBMITTAL - 12.21.2021 DRB SUBMITTAL - 02.22.2022







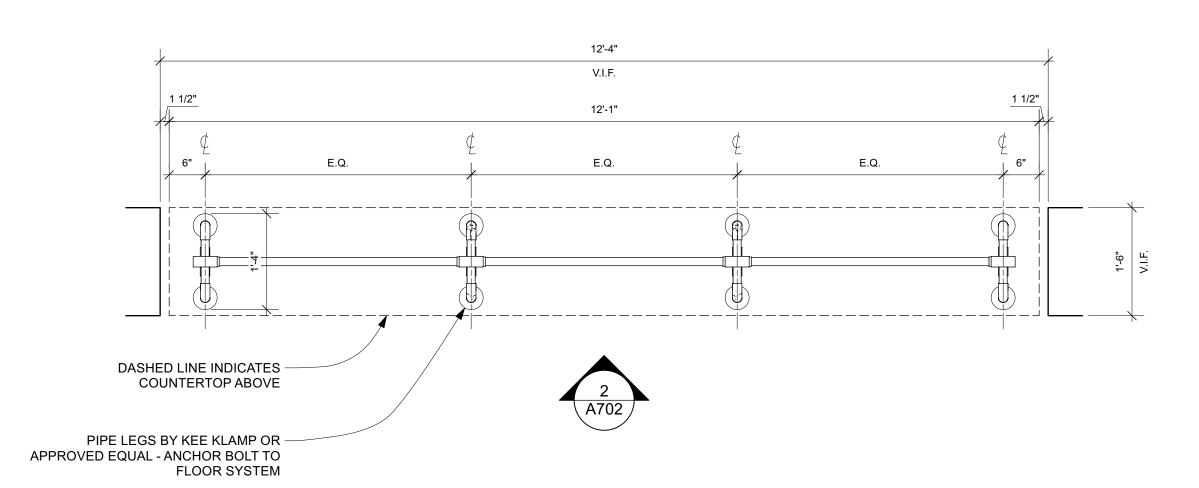





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LUCKY BEACH BAR



"NORFOLK B3262" W/ MARINE
BRONZE FINISH
BY TROY LIGHTING.
7'-6" A.F.F. UNLESS NOTED OTHERWISE.



"TOLEDO B2772" W/ OLD
SILVER FINISH
BY TROY LIGHTING.
8'-8" A.F.F. UNLESS NOTED OTHERWISE.




"SOUTH STREET F9396OR"
W/ OLD RUST FINISH
BY TROY LIGHTING.
7'-0" A.F.F.




"TOLEDO F2774" W/ OLD SILVER FINISH BY TROY LIGHTING. 7'-0" A.F.F.



"INDUSTRY DC" W/ GALVANIZED FINISH
AND SILVER PLYWOOD BLADES
BY THE MODERN FAN CO.
9'-0" A.F.F. UNLESS NOTED OTHERWISE.

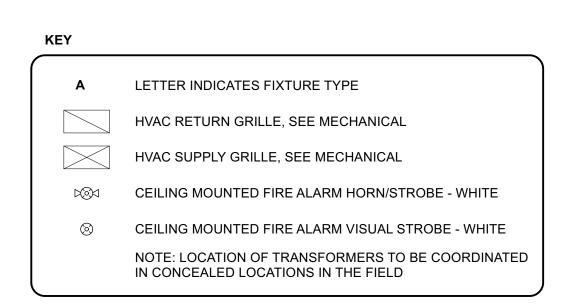

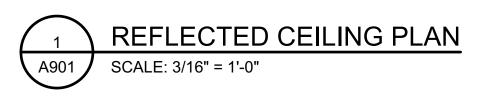



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CHARLESTON SC / 843-297-8939
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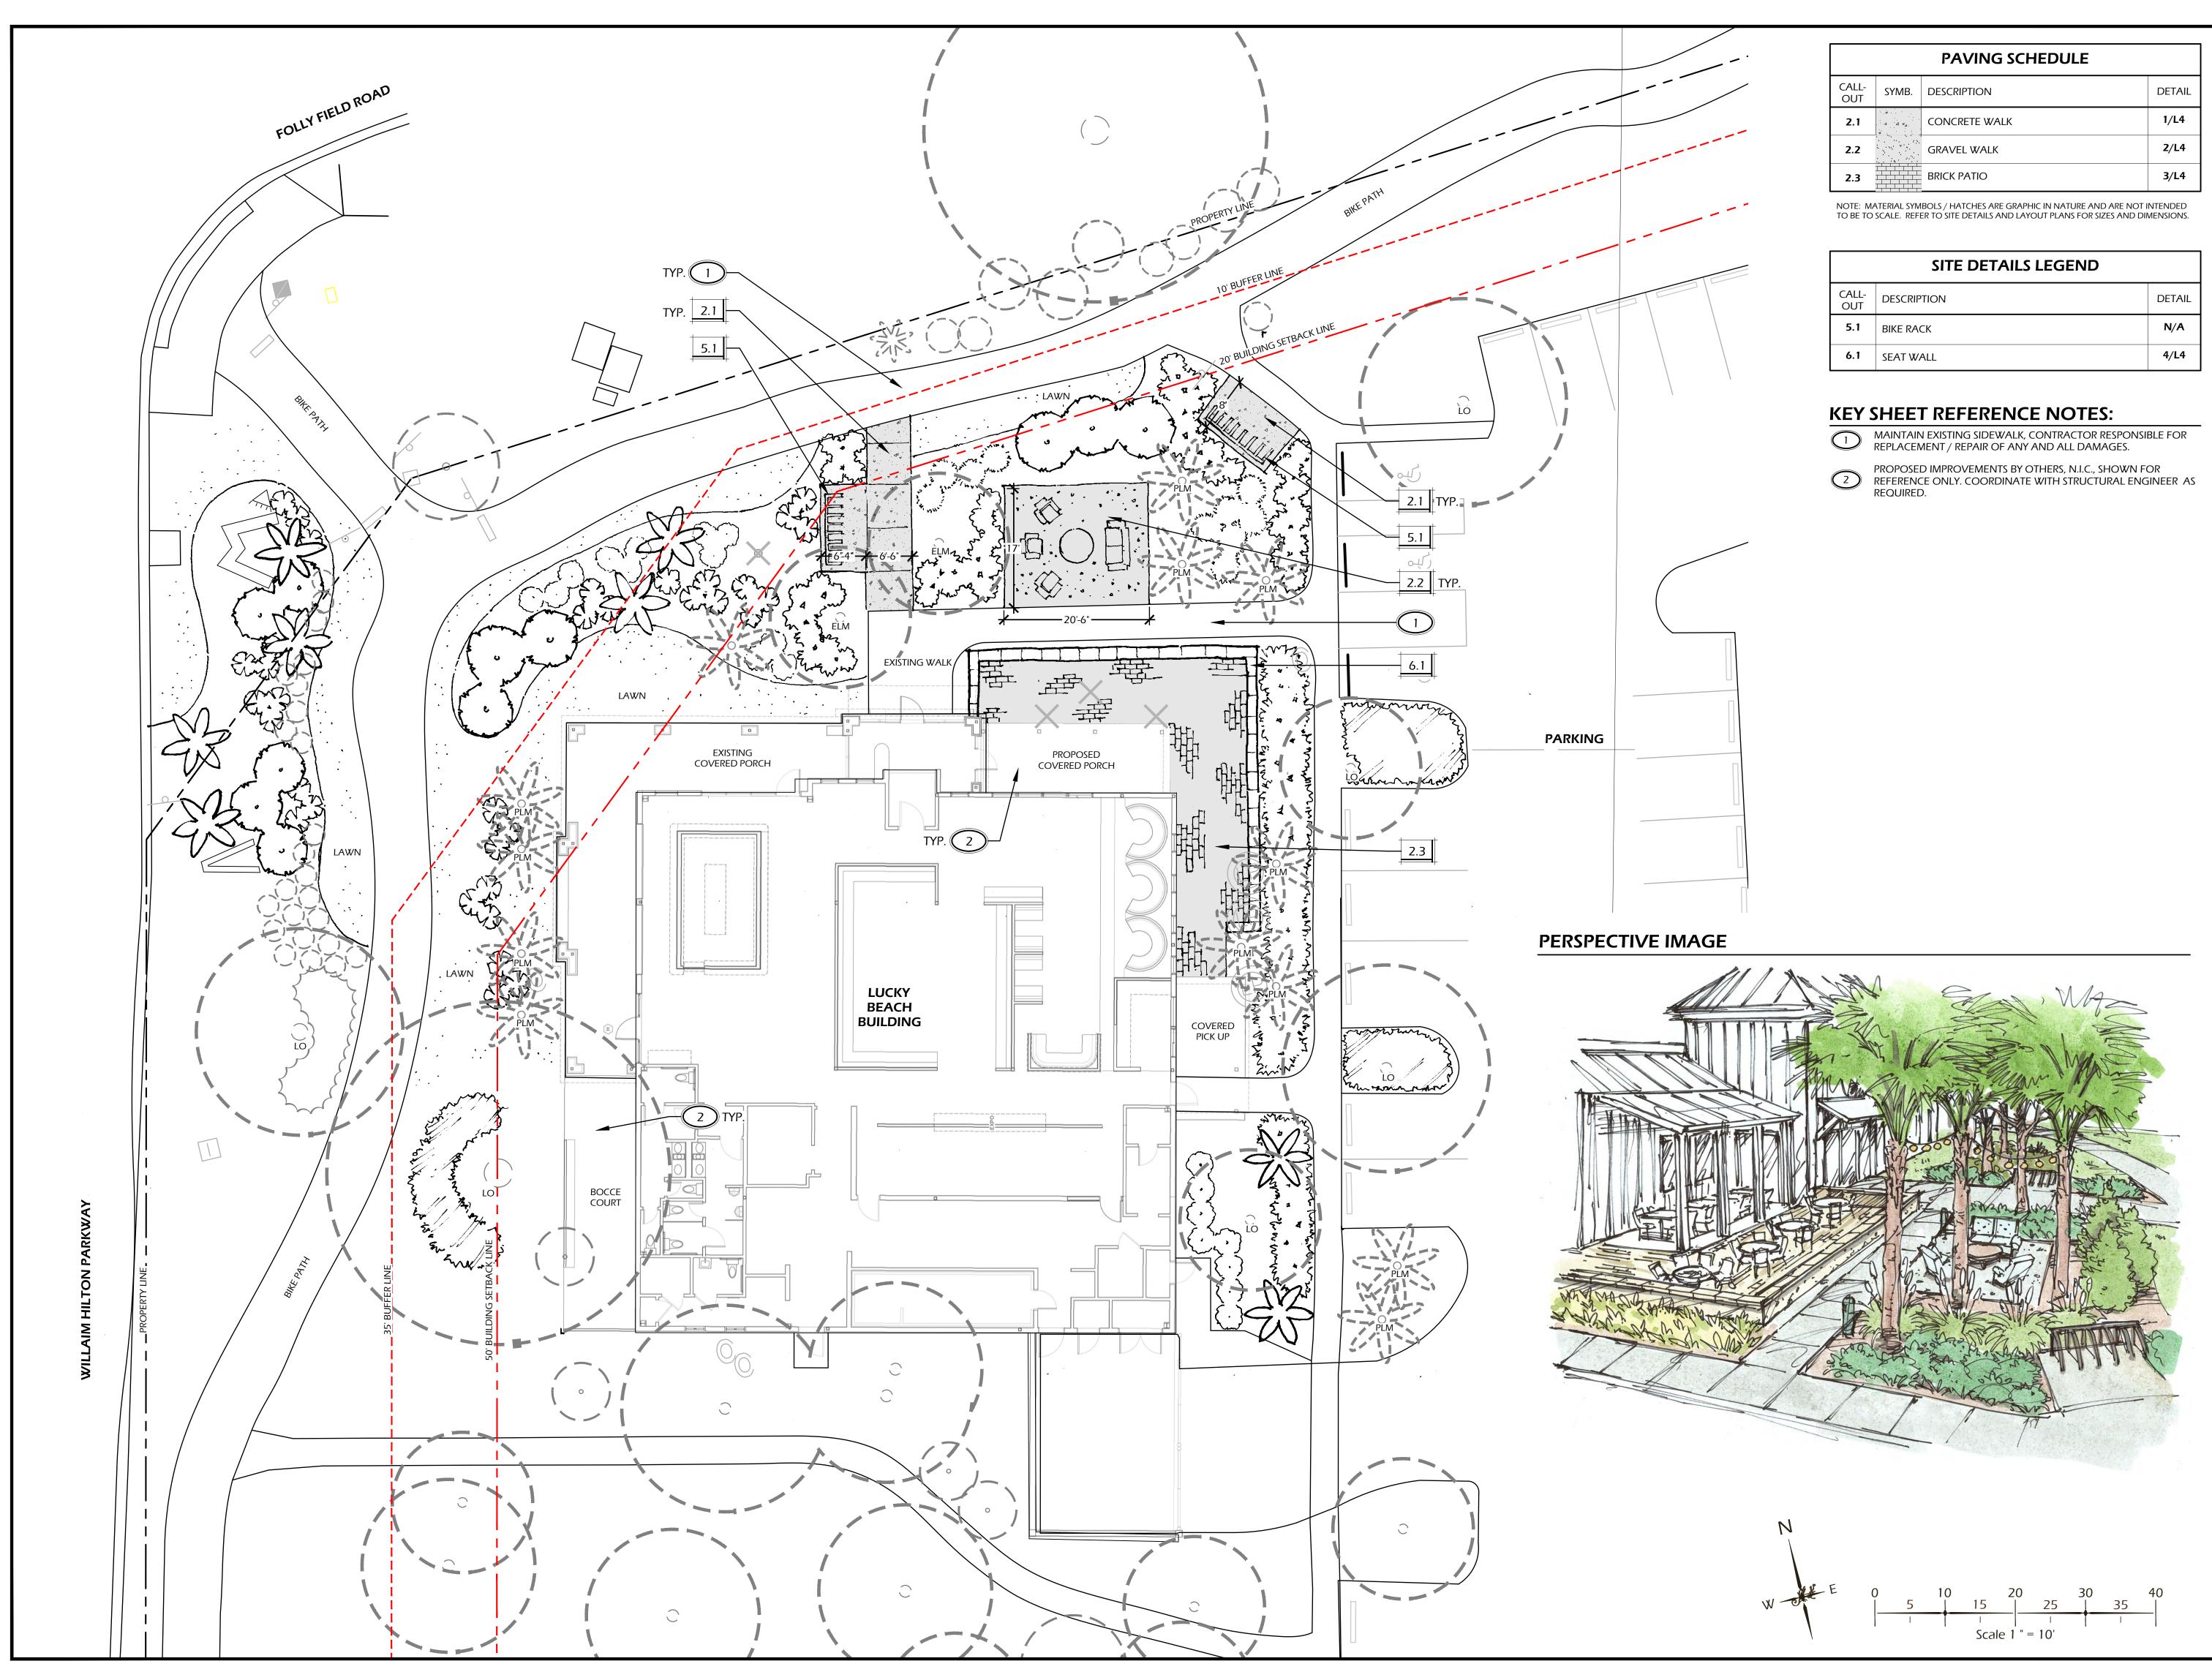
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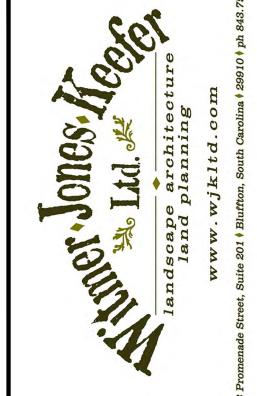


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CH BAR + KITCHEN





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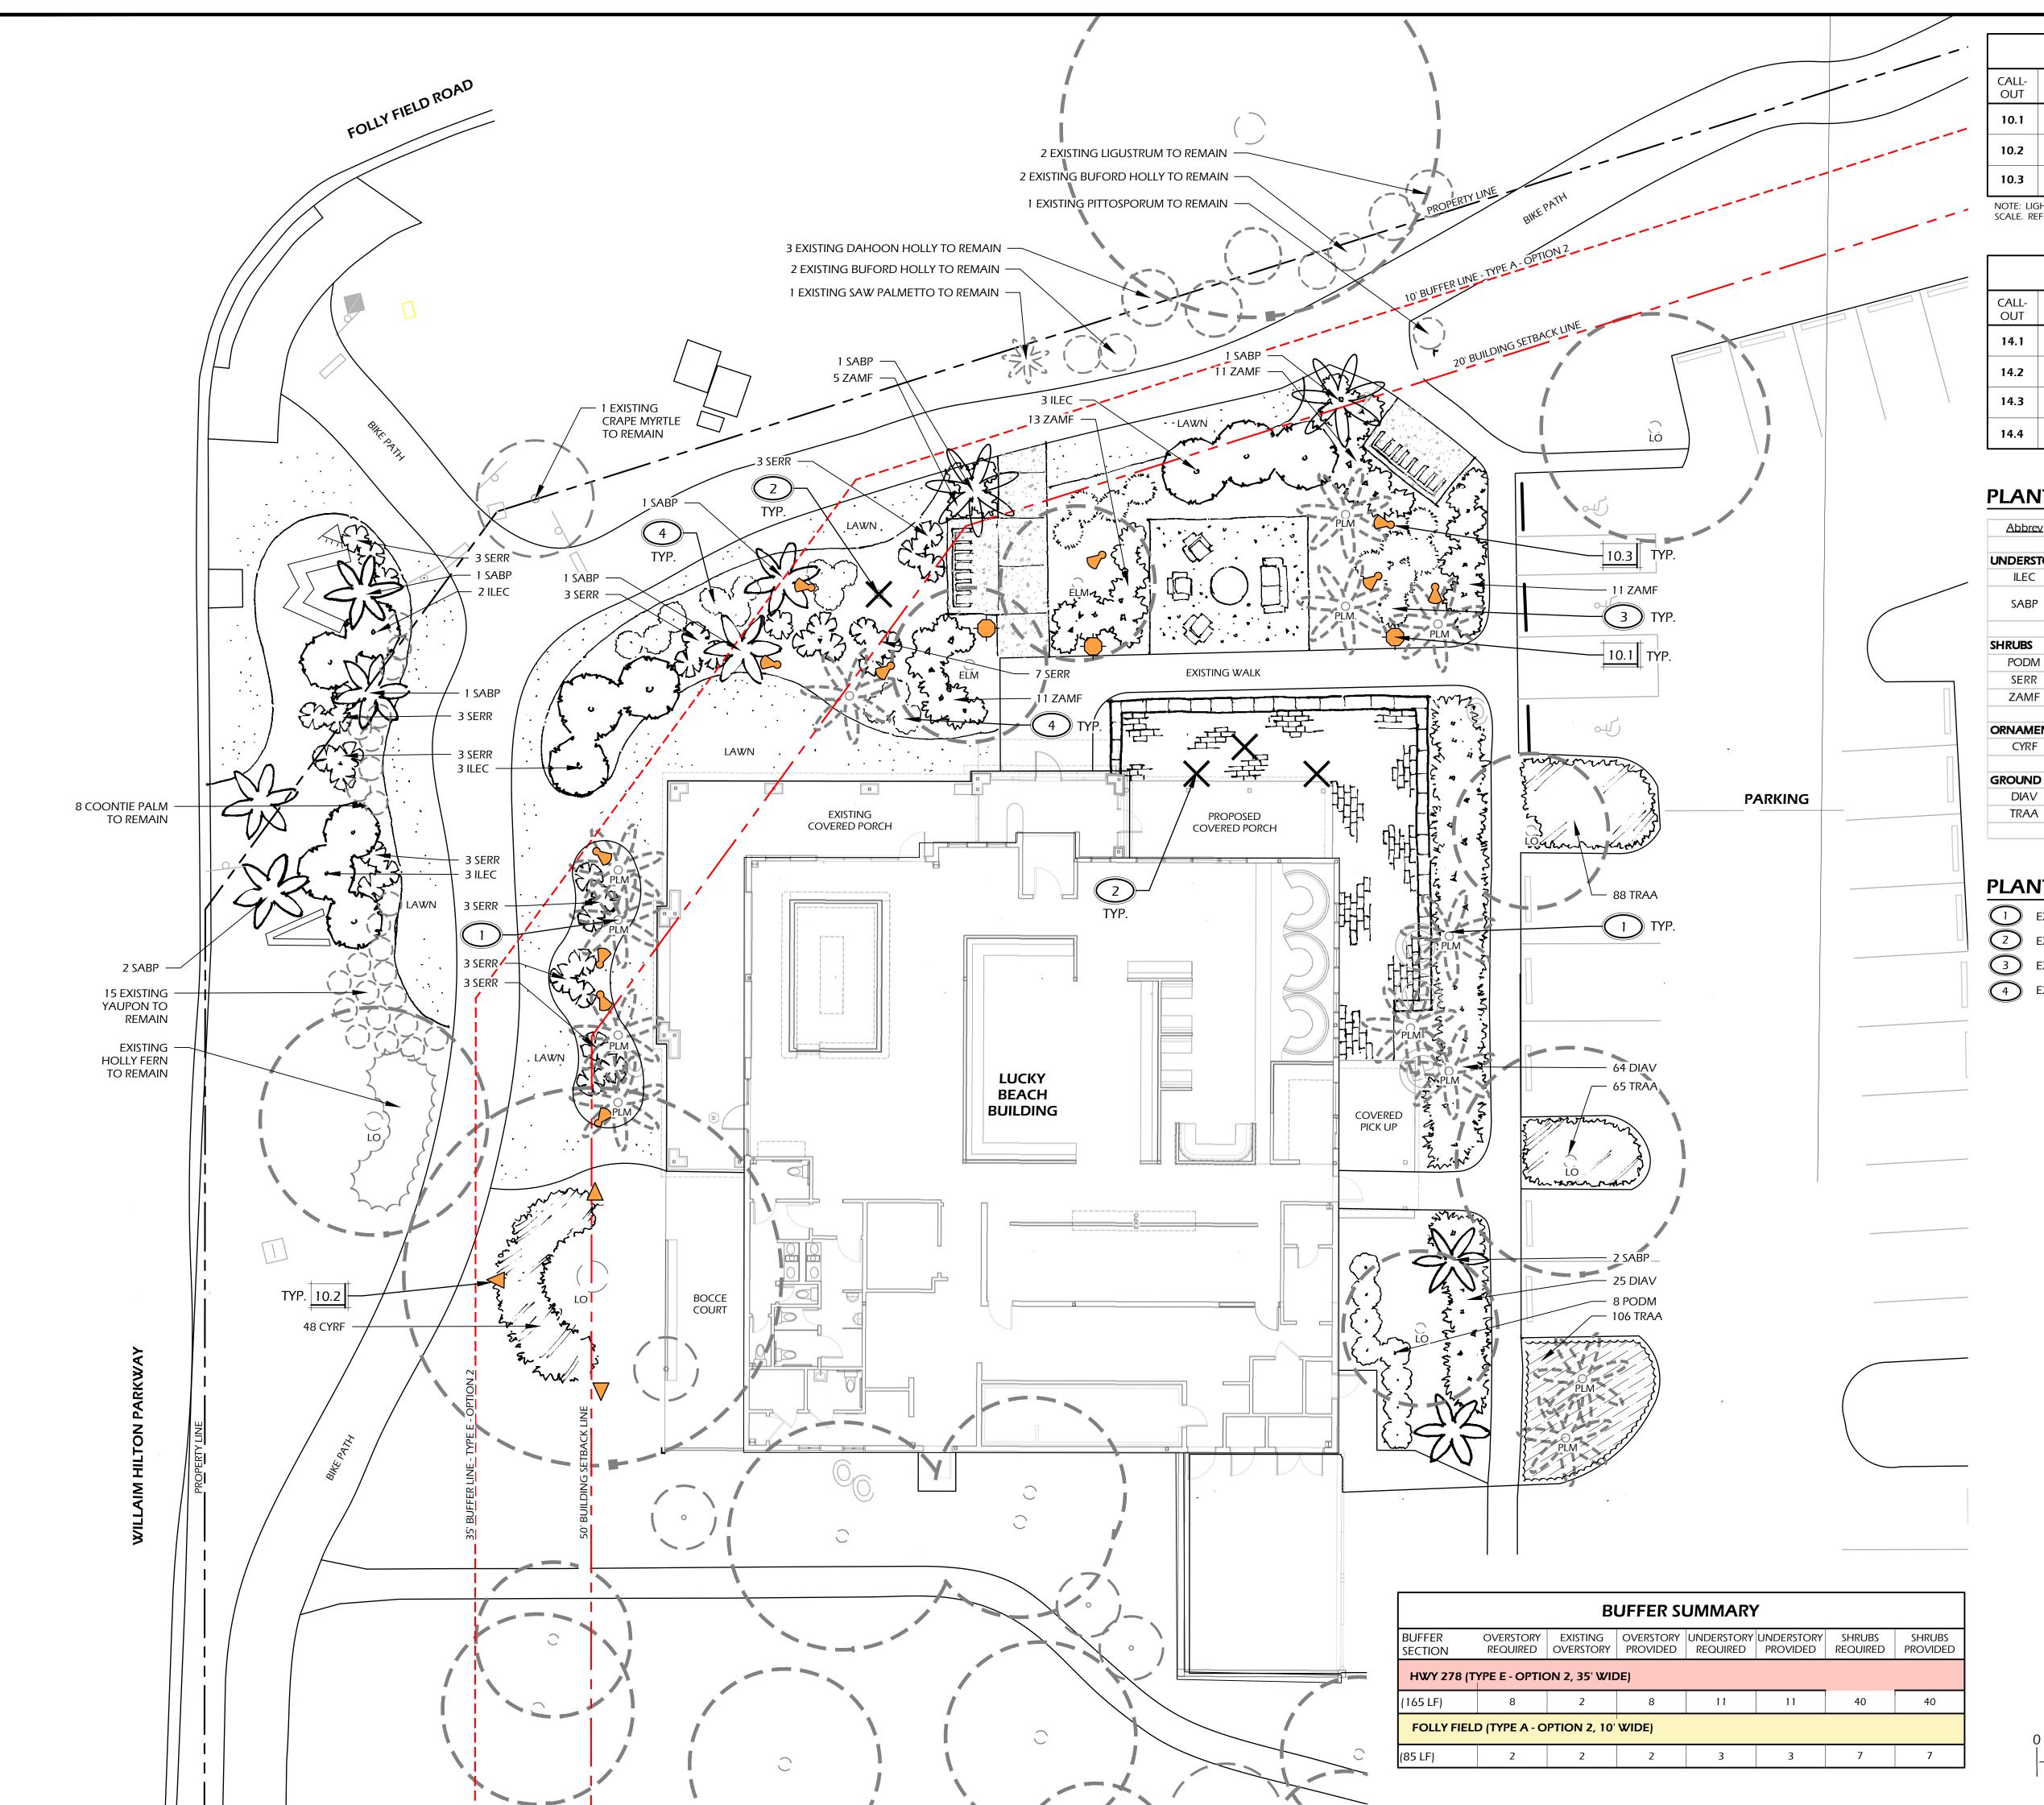
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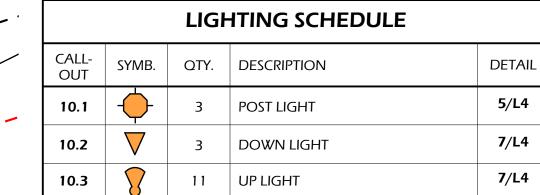
FINAL SUBMITTAL PLAN, NOT FOR CONSTRUCTION

REVISIONS:

DRAWING TITLE KEY SHEET AND LAYOUT PLAN

DRAWING NUMBER





NOTE: LIGHTING SYMBOLS ARE GRAPHIC IN NATURE AND ARE NOT INTENDED TO BE TO SCALE. REFER TO SITE DETAILS FOR SIZES AND DIMENSIONS.

	PLANTING DETAILS	
CALL- OUT	DESCRIPTION	DETAIL
14.1	TREE PLANTING	1/L3
14.2	PALM TREE PLANTING	2/L3
14.3	SHRUB PLANTING	3/L3
14.4	GROUND COVER PLANTING	4/3

PLANT KEY LEGEND

<u>Abbrev</u>	Botanical Name	Common Name
UNDERSTORY	/ TREES	
ILEC	llex cassine	Dahoon Holly
SABP	Sabal palmetto	Cabbage Palm
SHRUBS		
PODM	Podocarpus macrophyllus	Podocarpus
SERR	Serenoa repens	Saw Palmetto
ZAMF	Zamia floridana	Coontie Palm
ORNAMENTA	L GRASSES & FERNS	
CYRF	Cyrtomium falcatum	Holly Fern
GROUND CO	VERS, VINES & PERENNIALS	
DIAV	Dianella tasmanica 'Variegata'	Variegated Flax Lily
TRAA	Trachelospermum asiaticum	Asiatic Jasmine

PLANTING REFERENCE NOTES:

	EXISTING TREES TO REMAIN.
\bigcirc	EXISTING TREES TO BE REMOVED.
\bigcirc	EXISTING GRASSES TO REMAIN.

EXISTING AZALEAS IN GOOD HEALTH TO REMAIN.

ones

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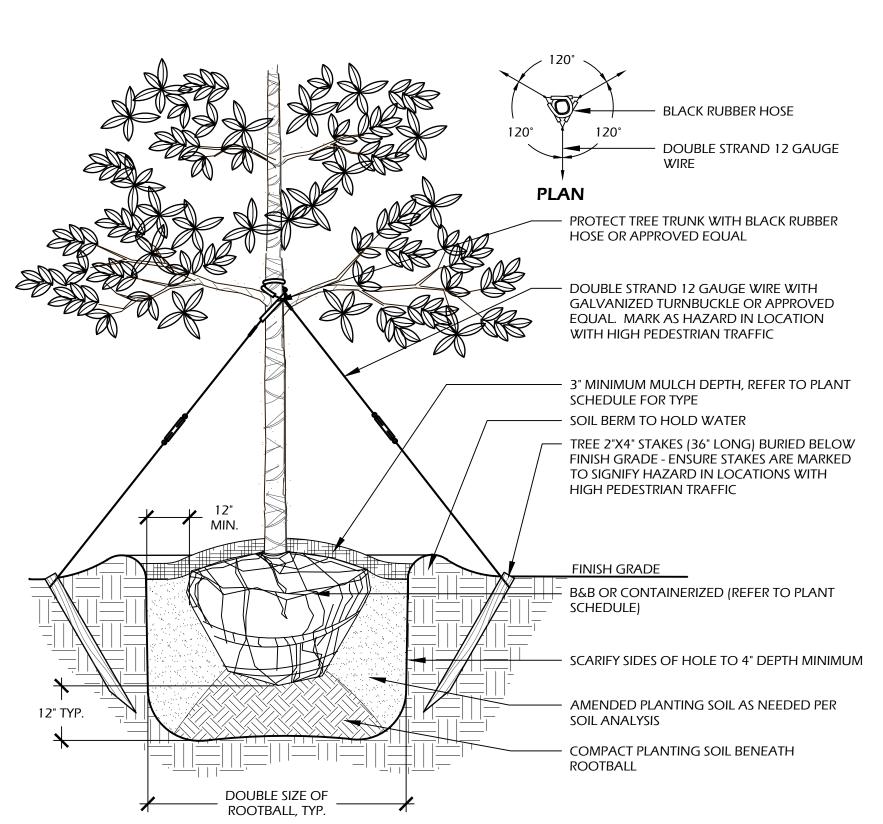
FINAL SUBMITTAL PLAN, NOT FOR CONSTRUCTION

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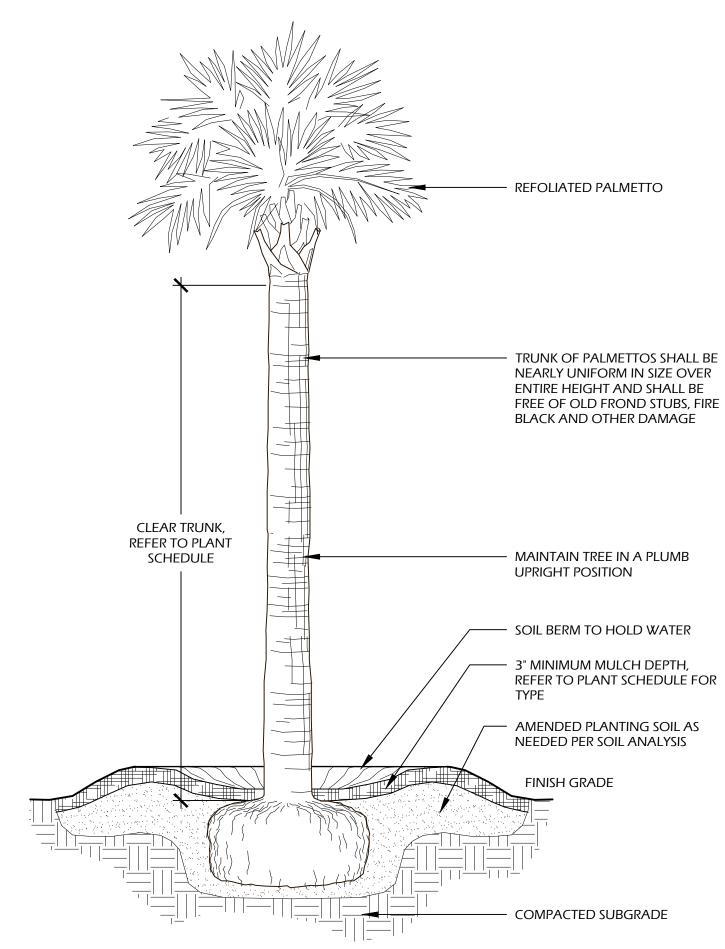
DRAWING TITLE LIGHTING AND PLANTING PLAN

DRAWING NUMBER



- 1. TREE STAKING OPTIONAL, HOWEVER, LANDSCAPE CONTRACTOR RESPONSIBLE FOR MAINTAINING TREES IN AN UPRIGHT (90 DEGREE/ PERPENDICULAR) POSITION FOR 1 YEAR AFTER PLANTING IS COMPLETE OR UNTIL TREE ROOT SYSTEM IS FULLY ESTABLISHED AND STURDY.
- FINAL TREE STAKING DETAILS AND PLACEMENT TO BE APPROVED BY OWNER'S REPRESENTATIVE. 2. CONTRACTOR SHALL ASSURE PERCOLATION OF ALL PLANTING PITS PRIOR TO INSTALLATION.
- 3. IN SEMI-IMPERVIOUS SOIL CONDITIONS, ROOTBALL ELEVATION SHALL BE 2" ABOVE FINISH GRADE. COORDINATE WITH OWNER'S REPRESENTATIVE PRIOR TO SETTING ROOTBALL ELEVATIONS.

TREE PLANTING



- 1. FINAL TREE STAKING DETAILS AND PLACEMENT TO BE APPROVED BY OWNER OR OWNER'S REPRESENTATIVE,
- 2. CONTRACTOR SHALL ASSURE PERCOLATION OF ALL PLANTING PITS PRIOR TO INSTALLATION. 3. SABAL PALMETTOS SHALL BE REFOLIATED, PROTECT CABBAGE HEAD FROM DAMAGE.

PALM TREE PLANTING

PLANT SCHEDULE:

Quantity	Abbrev	<u>Botanical Name</u>	Common Name	Height	Spread	Container	Cal./Spacing	Notes
UNDERSTOR	Y TREES							
11	ILEC	llex cassine	Dahoon Holly	6'-7'	3'-4'	15 gal.	-	Full
10	SABP	Sabal palmetto	Cabbage Palm	12'-16'	-	Cont.	-	Refoliated, full clear trunk refer to plan for heights
SHRUBS								
8	PODM	Podocarpus macrophyllus	Podocarpus	36"-42"	24"-30"	15 gal.	-	Full
34	SERR	Serenoa repens	Saw Palmetto	24"-30"	24"-30"	15 gal.	-	Full
51	ZAMF	Zamia floridana	Coontie Palm	12"-18"	18"-24"	7 gal.	-	Full
ORNAMENT	AL GRASSES & F	ERNS						
48	CYRF	Cyrtomium falcatum	Holly Fern	10"-12"	8"-12"	1 gal.	24" O.C.	Full
GROUND CO	OVERS, VINES &	PERENNIALS						
89	DIAV	Dianella tasmanica 'Variegata'	Variegated Flax Lily	12"-18"	12"-18"	1 gal.	30" O.C.	Full
259	TRAA	Trachelospermum asiaticum	Asiatic Jasmine	4"-6"	12" runners	1 gal.	18" O.C.	Full
SOD & MULC	H							
2,490	SOD-SF	≅	Empire Zoysia Sod	-	-		-	
7,168	MULCH-SF	Pine Straw - all disturbed areas	Pine Straw	-	-	-	-	-


3" MINIMUM MULCH DEPTH, REFER TO PLANT SCHEDULE FOR - SOIL BERM TO HOLD WATER FINISH GRADE B&B OR CONTAINERIZED (SEE PLANTING SCHEDULE, THIS SHEET) AMENDED PLANTING SOIL AS NEEDED PER SOIL ANALYSIS – DOUBLE SIZE OF ROOTBALL, TYP.


- 1. WHEN GROUNDCOVERS AND SHRUBS ARE USED IS MASSES, ENTIRE BED TO BE EXCAVATED TO RECEIVE PLANTING SOIL AND
- 2. CONTRACTOR SHALL ASSURE PERCOLATION OF ALL PLANTING PITS PRIOR TO INSTALLATION.
- 3. IN SEMI-IMPERVIOUS SOIL CONDITIONS, ROOTBALL ELEVATION SHALL BE ± 2 " ABOVE FINISH GRADE. COORDINATE WITH

OWNER'S REPRESENTATIVE PRIOR TO SETTING ROOTBALL ELEVATIONS.

SHRUB PLANTING

GROUND COVER PLANTING

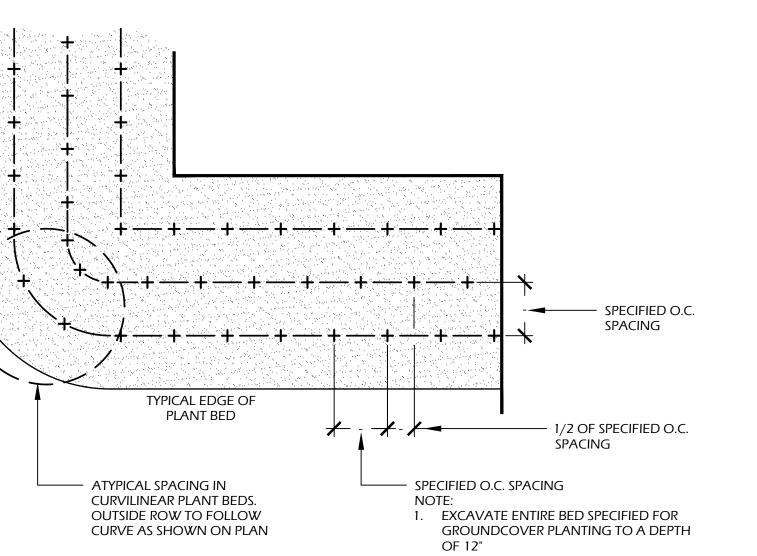

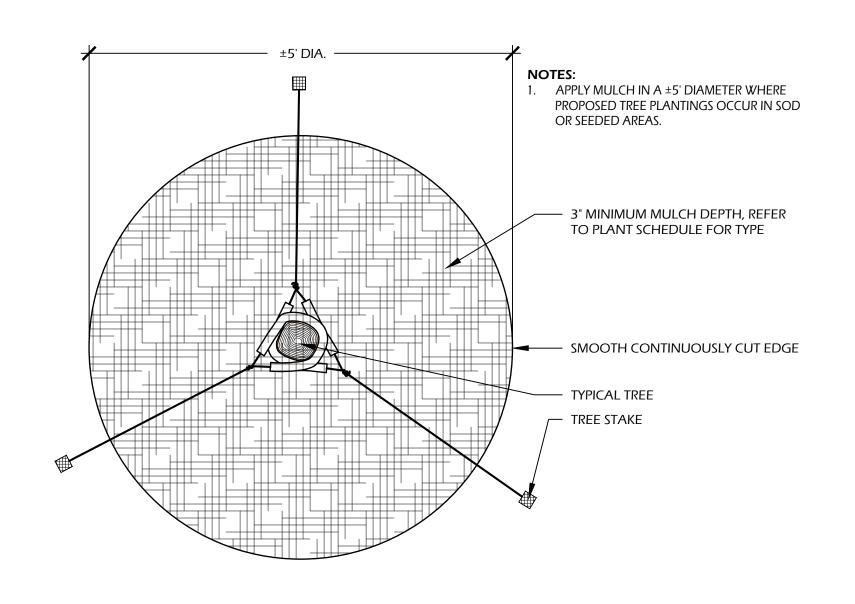

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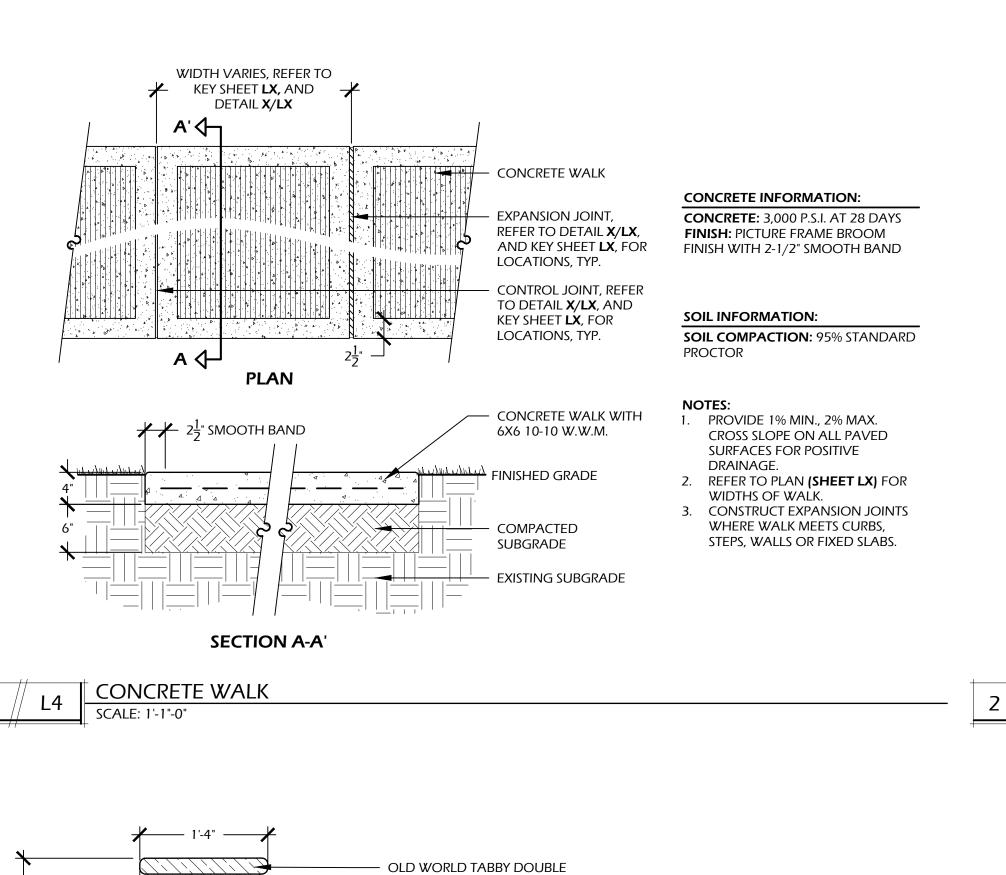
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REVISIONS:

DRAWING TITLE PLANT SCHEDULE AND **DETAILS**

DRAWING NUMBER



BULL NOSE CAP

COURSES, TYP.

CONTINUOUS

— EXISTING SUBGRADE

+/- 30"

FINISHED GRADE

SEAT WALL

UP/DOWN LIGHT SCALE: N.T.S.

FILL VOIDS WITH MORTAR, TYP.

STUCCO FINISH TO MATCH

WITH GROUT, ALTERNATE

- 12"X8"X16" CMU, FILL ALL VOIDS

- #4 VERTICAL REBAR AT 16" O.C.


CONCRETE FOOTING, 3,000 P.S.I.


#4 HORIZONTAL REBAR @ 12"


#4 BOTTOM REBAR @ 12" O.C.,

- 6" 95% COMPACTED SUBGRADE

EXISTING ON BUILDING

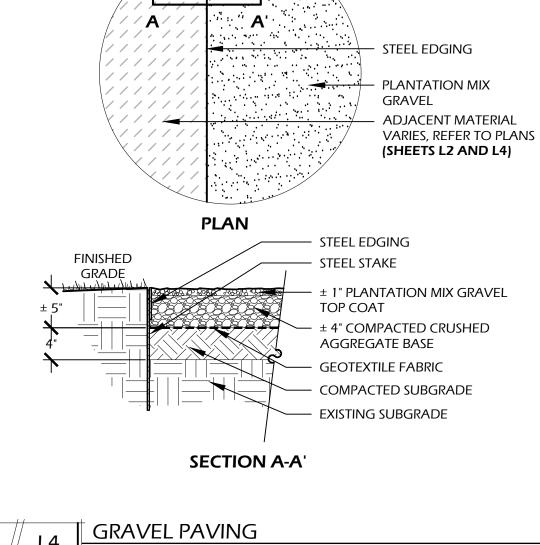

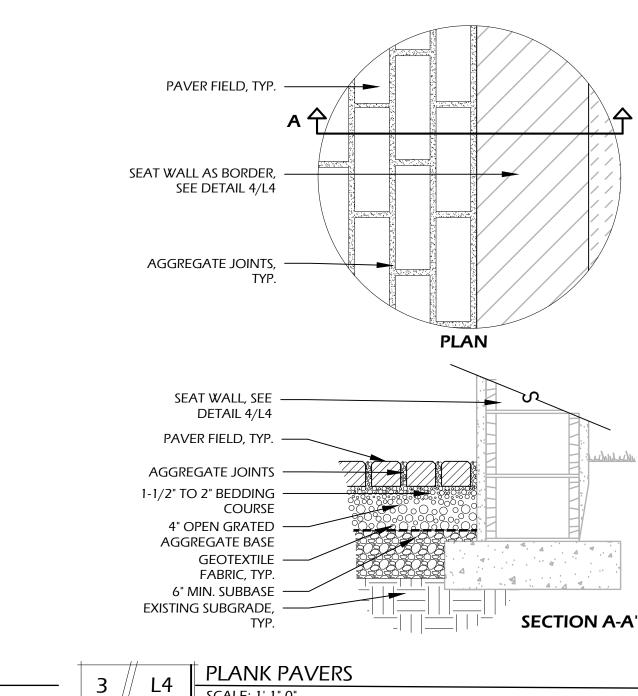

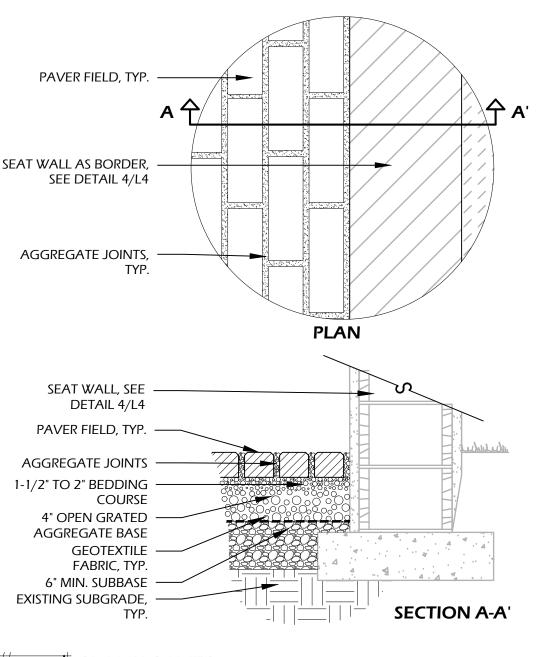

VERTICAL STEP LIGHT

The Vertical Step Light offers excellent

beauty of your installation. Coastal Source Vertical Step Lights utilize the patented Coastal Connector

Note: Protrusion is about 3/4"...please see 'Step Light

0

[ENGINEERED] FOR LIFE

VERTICAL STEP LIGHT

system for easy installment and long life.

3.25

vertical surfaces. The Vertical Step Light allows for 3,



GEOTEXTILE INFORMATION:

APPROVED EQUAL

VERTICAL STEP LIGHT SPECIFICATIONS

Size (H x W): 3.25in x 8.375in

Lamp: Replaceable LED Module

Fixture Connector: CMC Male Direct Connect

Wiring: 5' CMC Cable (not included)

Warranty: 5-Year Limited Warranty*

Wattage: 3.5 Watts (200lm) Mounting: Surface Mount

Finish: Vintage Brass

GEOTEXTILE FABRIC: TYPAR 3401 OR

1. PROVIDE MIN. 1% CROSS SLOPE ON ALL

2. CONTRACTOR SHALL COORDINATE

ALL OTHER STEPS SHALL HAVE A

CONTINUOUS RUN OF STUCCO TABBY.

PAVED SURFACES FOR POSITIVE DRAINAGE.

REPRESENTATIVE PRIOR TO CONSTRUCTION.

BORDERS AND PATTERN WITH OWNER'S

LIGHTS ARE LOCATED ON ONE SET OF STEPS

ONLY. REFER TO SHEET L4 FOR LOCATION.

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ELOPMENT

SOUTH

ISLAND,

Q


FEB. 22, 2022 DATE: PROJECT NO.: 22040.01 PT DRAWN BY: CHECKED BY: ВW

FINAL SUBMITTAL PLAN, NOT FOR CONSTRUCTION

REVISIONS:

DRAWING TITLE SITE DETAILS

DRAWING NUMBER

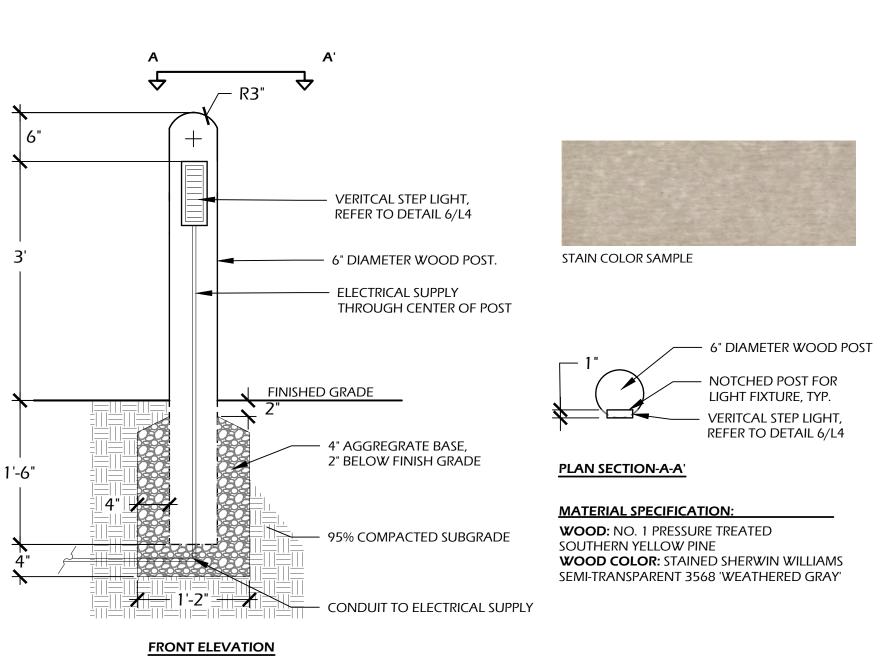

EDGING AND STAKE INFORMATION:

WEB: WWW.BORDER CONCEPTS.COM

STEEL EDGE: BORDER GUARD 3/16" X 4" X 16" **STAKES:** :STANDARD STAKE 3/16" THICK X 15"

NOTE: INSTALL FLUSH PER MANUFACTURES

GEOTEXTILE FABRIC: TYPAR 3401 OR

SOIL COMPACTION: 95% STANDARD

MANUFACTURER:

LONG (6 PER 16')

COLOR: BLACK

SPECIFICATIONS

OTHER INFORMATION:

APPROVED EQUAL


BORDER CONCEPTS, INC.

CHARLOTTE, NC. 28226

PHONE: (800) 845.3343

7621 LITTLE AVE., SUITE 426



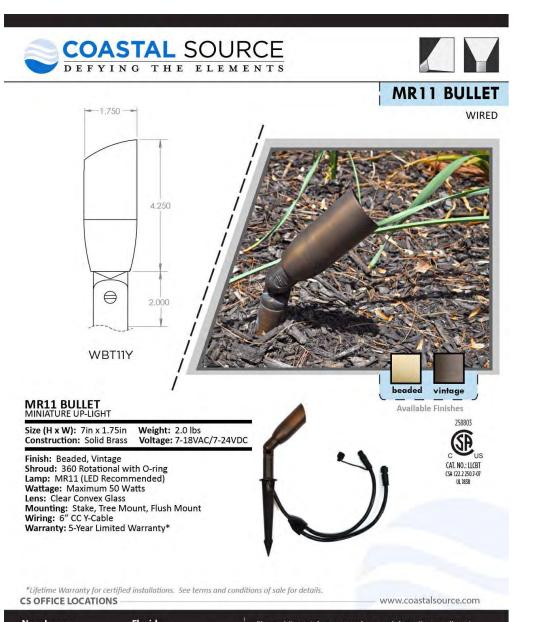

11450 Overseas Highway 1 1-800-719-1996. You will always be pleased you purchased
Coastal Source product.

STONE MANUFACTURER INFORMATION:

STONE: TO MATCH ARCHITECTURE

COLOR: TO MATCH ARCHITECTURE

PATTERN: SINGLE COURSE BORDER

JOINTS: MORTAR JOINTS TO MATCH

ARCHITECTURE

NOTES:

MANUFACTURER: TO MATCH ARCHITECTURE

1. REFER TO LAYOUT PLAN (SHEET L3) FOR

OVERALL DIMENSIONS OF SEAT WALL.

DESIGN TEAM/DRB COMMENT SHEET

The comments below are staff recommendations to the Design Review Board (DRB) and do NOT constitute DRB approval or denial.

PROJECT NAME: Lucky Beach Bar + Kitche	n		DRB	#: DRB-000498-2022
DATE: 02/23/2022				
RECOMMENDATION: Approval RECOMMENDED CONDITIONS: 1. Provide a color board for DRB review. 2. Specify the color of the rope. 3. Specify the light temperature of the landse 4. Provide a specification for the bike racks.	cape lighting		conditions 🔀	Denial
ARCHITECTURAL DESIGN				
DESIGN GUIDE/LMO CRITERIA	Complies Yes	No	Not Applicable	Comments or Conditions
DESIGN GUIDE/LMO CRITERIA Utilizes natural materials and colors	_	No 🖂	Not Applicable	Comments or Conditions Specify the color of the rope in the fence.
·	_	_	Not Applicable	
Utilizes natural materials and colors Decorative lighting is limited and low wattage and adds	_		Not Applicable	Specify the color of the rope in the fence. Specify 3000K or less on the landscape lighting
Utilizes natural materials and colors Decorative lighting is limited and low wattage and adds	_		Not Applicable	Specify the color of the rope in the fence. Specify 3000K or less on the landscape lighting
Utilizes natural materials and colors Decorative lighting is limited and low wattage and adds to the visual character MISC COMMENTS/QUESTIONS	_		Not Applicable	Specify the color of the rope in the fence. Specify 3000K or less on the landscape lighting
Utilizes natural materials and colors Decorative lighting is limited and low wattage and adds to the visual character	_		Not Applicable	Specify the color of the rope in the fence. Specify 3000K or less on the landscape lighting
Utilizes natural materials and colors Decorative lighting is limited and low wattage and adds to the visual character MISC COMMENTS/QUESTIONS 1. This project required DPR review.	_		Not Applicable	Specify the color of the rope in the fence. Specify 3000K or less on the landscape lighting
Utilizes natural materials and colors Decorative lighting is limited and low wattage and adds to the visual character MISC COMMENTS/QUESTIONS 1. This project required DPR review. 2. Provide a bike rack specification.	_		Not Applicable	Specify the color of the rope in the fence. Specify 3000K or less on the landscape lighting
Utilizes natural materials and colors Decorative lighting is limited and low wattage and adds to the visual character MISC COMMENTS/QUESTIONS 1. This project required DPR review. 2. Provide a bike rack specification.	_		Not Applicable	Specify the color of the rope in the fence. Specify 3000K or less on the landscape lighting